MICHAEL LEWIS ARCHITECTS PC

145 Palisade Street Suite 307 Dobbs Ferry, New York 10522 V: 914.231.7700 Fx: 914.231.7701 INFO@MLARCHITECT.COM

LETTER OF TRANSMITTAL

To: Building Department - Irvington, NY

Date: July 17, 2023

Project: Modifications to 3 Woodbine Road - Application No. 807

The following materials are enclosed / attached By Hand - for revised ARB Drawings

Quant.	Description	Date	Item No.	Notes
3	Transmittal	7/17/23		1 Page
3	Cover Letter	7/14/23		1 Page
3	Architectural drawings	7/14/23		Signed and sealed. 10 pages per set
1	USB drive	-		

The materials listed above are submitted in application for ARB review at the meeting scheduled for July 24, 2023.

Please do not hesitate to contact us with any questions or concerns: mlewis@mlarchitect.com (914) 224-4745

Cc: Alex and Elizabeth Reynolds - Owner

MICHAEL LEWIS ARCHITECTS PC

145 Palisade St · Suite 307 · Dobbs Ferry, NY 10522 · 914.231.7700 · info@mlarchitect.com

To: Architectural Review Board

Building Department Village of Irvington, NY

Date: July 14, 2023

Re: Modifications to 3 Woodbine Road - Application No. 807

Dear Architectural Review Board,

On behalf of our clients, Alexander and Elizabeth Reynolds – we are submitting this application for interior renovations and new windows at 3 Woodbine Place.

We have revised the drawings after getting comments from Sarah Palermo and the ARB, please see new drawings dated 7.14.23.

As shown on the drawings, the work is primarily interior with the 1st floor Kitchen renovated, Living Room interior ceiling raised, minor reconfiguration of walls, renovated existing Bath, and insulation in walls and ceilings at the lower level, and new windows in existing openings throughout.

Exterior work – No sitework or change to the building footprint is proposed. Proposed work at the exterior is limited to replacement of windows and addition of a skylight above the central stair. Most of the windows are being replaced within the existing openings with the exception to this occurring at the Lower Level rear façade and 1st Floor South Side where some of the existing openings have been enlarged. None of these are proposed window revisions are visible from the street. Proposed trim at all windows is existing to remain or replaced to match the existing in configuration and finish.

Thank you in advance for your time and attention to the project.

Sincerely Yours,

Michael B. Lewis

AIA, Leed AP

GENERAL REQUIREMENTS

1. Related Documents: Drawings, Specifications and General Conditions of the Contract for Construction apply to Work of this Project.

2. Scope of Work: Includes all items described in Drawings & Specifications, verbally & graphically, with more stringent and/or costly items assumed in all

3. All new construction shall adhere to the 2020 Residential Code of New York State and the 2020 Energy Conservation Code of New York State. Notify Architect of any inadvertent noncompliance with Codes regarding information contained in Drawings and Specifications, with no Work to be performed knowingly in noncompliance with Code.

4. The General Contractor (G.C.) shall coordinate all work procedures w/requirements of Local Authorities. Prior to commencement of Construction, the G.C. shall be responsible for the acquisition of a Building Permit and pay all fees required by Governing Agencies. The G.C. shall be responsible for calling for Inspections and Sign-offs of all Work, including Plumbing & Electrical, as required by Governing Agencies.

5. The G.C., Subcontractors, and all others working for Owner shall comply with National, State, and Local Laws and Regulations relating to insurance for work under this Contract. The following insurance policies shall be in force and copies shall be submitted to Architect prior to signing Agreement Between Owner and Contractor: Workman's Compensation & Unemployment Insurance as required by law, Contractor's Liability Coverage in the amount required by applicable Governing Agencies, & Liability Coverage for damages & uninstalled materials. The G.C. shall submit to the Owners, Insurance Certificates naming Owner as Additional Insured. All insurance shall be at Contractor's expense.

6. All Terms & Conditions laid out in the A.I.A. Standard Form Of General Conditions shall apply to the G.C. & to all of his Sub-Contractors.

7. The G.C. & Subcontractors shall attend regular job meetings as required by the Architect.

DIVISION 01: PROJECT REQUIREMENTS

1. The G.C. shall verify all Dimensions & Conditions in the field prior to Construction. Any discrepancies are to be brought to the attention of the Architect prior to work. The G.C. shall be responsible for Field Fit & Quality of all Work, whether by the G.C. or by Subcontractors. No allowances shall be made on behalf of the G.C. for any error or neglect on his part. Under no circumstances are the Drawings to be scaled for location of Work. G.C. shall verify all clearances & locations prior to installation including requirements for appliances, fixtures, or equipment.

2. Retain licensed Surveyor to mark site before beginning construction and to verify location of foundation and slab-on-grade formwork before pouring concrete. Verify that all work conforms to zoning requirements including all setbacks and yard requirements.

3. The G.C. shall be responsible for the protection of all new & existing Work, Owner's Property, Building, and its Premises from damage & dirt or dust.

4. Plumbing & Electrical Work shall be performed by Contractors licensed in their trade. G.C. shall be licensed to perform the Work as required.

5. The G.C. shall maintain at the Site one Record Copy of all Drawings, Clarification Sketches, Approved Shop Drawings, Approved Samples, and Change Orders continuously updated to record all changes during Construction. G.C. shall fully correct, at no additional expense, all Work wrongly constructed or materials wrongly ordered from obsolete Drawings.

6. Details not usually shown or specified, but necessary for proper construction on any part of the work shall be included as if they were indicated in the

7. Architectural Drawings shall be Followed as closely as actual Field Conditions & the work of other trades permit. Any piping, wiring, or materials not specifically shown or specified but required to complete Work shall be deemed to be part of Work & shall be furnished & installed by the G.C.

8. G.C. shall prepare schedule for completion of Work prior to commencement and submit to Architect for approval. Contractor shall follow approved schedule and immediately notify Architect of any deviations from the approved schedule.

9. The G.C. must submit all Engineering & Shop Drawings (including Millwork) & cut sheets of all equipment, plumbing & electrical fixtures, hardware & accessories to the Architect for approval prior to Fabrication, Ordering and /or Construction. Shop Drawings shall be revised per Architect's instruction if required prior to approval.

10. The G.C. shall supervise & be solely responsible for all aspects of the Work, including Site Safety, maintenance of exit clearances & fire extinguishers as required by Code. The G.C. shall have sole responsibility for any damage or injuries caused by or during the execution of the Work.

11. The G.C. shall be responsible for demolition & safe removal from the Site of all materials that must be removed to enable completion of Work and occupation of the Premises. All removed materials shall be disposed of regularly in a legal manner.

12. All piping & wiring to be demolished shall be removed to a point of concealment & shall be properly capped or plugged.

13. The G.C. shall do all cutting, patching & repairing as required to perform all Work required to complete the Job. All patching where new construction

14. All new construction shall be laid-out in field for Architect's approval prior to starting construction.

15. No changes to approved layouts shall be made without Written Consent Of The Architect.

16. When "Approved Equal", "Equal To", "Similar" or other general qualifying terms are used, it shall be subject to final review by the Architect. There shall be no substitutions unless agreed upon in writing by the Architect.

17. The G.C. shall verify all equipment dimensions, locations & hook-ups with Manufacturer's Specifications whether the G.C. or Others supply the equipment.

18. All items noted "Furnished By Owner" shall be installed by the G.C. under this Contract as per Manufacturers' Specifications & industry standards. Wall

reinforcement & all other requirements required to incorporate Owner furnished items shall be provided & coordinated by the G.C. 19. G.C. shall employ experienced workers or professional cleaners for final cleaning prior to request of inspection for Certificate of Substantial Completion.

NYS CODE COMPLIANCE

1. This design is in compliance with requirements of 2020 Residential Code of New York State and the 2020 Energy **Conservation Code of New York State.**

2. Contractor shall perform all work in accordance with applicable codes as listed in the 2020 NYS Code Books.

2020 RESIDENTIAL CODE OF NYS ENERGY EFFICIENCY NOTES

WESTCHESTER NY: CLIMATE ZONE 4A

[NY] TABLE N1102.1.2 (R402.1.2) INSULATION AND FENESTRATION REQUIREMENTS BY COMPONENT^a

CLIMATE ZONE	FENESTRATION U-FACTOR ^b	SKYLIGHT ^b <i>U</i> -FACTOR	GLAZED FENESTRATION SHGC ^{b, e}	CEILING R-VALUE	WOOD FRAME WALL <i>R</i> -VALUE	MASS WALL R-VALUE	FLOOR <i>R</i> -VALUE	BASEMENT° WALL <i>R</i> -VALUE	SLAB ^d R-VALUE & DEPTH	CRAWL SPACE° WALL R-VALUE
1	NR	0.75	0.25	30	13	3/4	13	0	0	0
2	0.40	0.65	0.25	38	13	4/6	13	0	0	0
3	0.32	0.55	0.25	38	20 or 13 + 5 ^h	8/13	19	5/13 ^f	0	5/13
4 except Marine	0.32	0.55	0.40	49	20 or 13 + 5 ^h	8/13	19	10 /13	10,2 ft	10/13
5 and Marine 4	0.30	0.55	NR	49	20 or 13 + 5 ^h	13/17	30 ^g	15/19	10,2 ft	15/19
6	0.30	0.55	NR	49	$20 + 5^{\rm h}$ or $13 + 10^{\rm h}$	15/20	30 ^g	15/19	10,4 ft	15/19
7 and 8	0.30	0.55	NR	49	$20 + 5^{\rm h}$ or $13 + 10^{\rm h}$	19/21	38 ^g	15/19	10,4 ft	15/19

For SI: 1 foot = 304.8 mm

NR = Not Required.

- a. R-values are minimums. U-factors and SHGC are maximums. Where insulation is installed in a cavity that is less than the label or design thickness of the insulation, the installed R-value of the insulation shall be not less than the R-value specified in the table.
- b. The fenestration *U*-factor column excludes skylights. The SHGC column applies to all glazed fenestration. c. "10/13" means R-10 continuous insulation on the interior or exterior of the home or R-13 cavity insulation on the interior of the basement wall. "15/19" means
- R-15 continuous insulation on the interior or exterior of the home or R-19 cavity insulation on the interior of the basement wall. Alternatively, compliance with "15/19" shall be R-13 cavity insulation on the interior of the basement wall plus R-5 continuous insulation on the interior or exterior of the home.
- d. R-5 insulation shall be provided under the full slab area of a heated slab in addition to the required slab edge insulation R-value for slabs. as indicated in the table. The slab edge insulation for heated slabs shall not be required to extend below the slab.
- e. Reserved. f. Reserved.
- g. Alternatively, insulation sufficient to fill the framing cavity providing not less than an R-value of R-19.
- h. The first value is cavity insulation, the second value is continuous insulation. Therefore, as an example, "13+5" means R-13 cavity insulation plus R-5
- i. Mass walls shall be in accordance with Section N1102.2.5. The second R-value applies where more than half of the insulation is on the interior of the mass



FRONT YARD - APPROACH

GENERAL CONDITIONS

1. APPROVED STAMPED SET OF BUILDING PLANS MUST BE PRESENT ON SITE AT ALL TIMES.


2. LICENSED ELECTRICIAN TO FILE ELECTRICAL PERMIT

HIGH WIND CONNECTIONS

PROVIDE STRAPPING AS REQUIRED TO RESIST HIGH WIND AND UPLIFT FORCES TO BE IN COMPLIANCE WITH TABLE R802.11 OF THE NY STATE RESIDENTIAL CODE. USE TENSION TIES EQUAL TO SIMPSON MODEL # H2 OR AS INDICATED AT ALL POST-PLATE-RAFTER CONNECTIONS.

PRE-ENGINEERED WOOD PLACARDING

CONTRACTOR SHALL PROVIDE PLACARD AS REQUIRED BY CODE, 6" DIA. CIRCLE WITH RED REFLECTIVE PRINT ON WHITE BACKGROUND, INDICATING THAT PRE-ENGINEERED WOOD HAS BEEN USED IN CONSTRUCTION. PLACARD SHALL BE PLACED AT EXTERIOR ON OR NEAR ELECTRIC METER IN PLAIN VIEW AND INDICATE THAT PRE-ENGINEERED WOOD HAS BEEN USED FOR ROOF AND FLOOR SUPPORT IN THE BUILDING OF TYPE-V CONSTRUCTION.

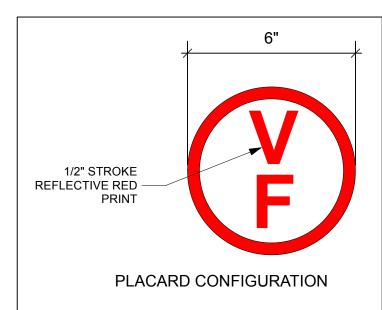

CLIMATE AND GEOGRAPHIC DESIGN CRITERIA

2020 INTERNATIONAL RESIDENTIAL CODE

CHAPTER 3 - BUILIDING PLANNING SECTION R301 DESIGN CRITERIA

WESTCHESTER, NY: CLIMATE ZONE 4 TABLE R301.2(1) CLIMATIC AND GEOGRAPHIC DESIGN CRITERIA

GROUND	WIND	TOPOGRAPHIC	SPECIAL	WIND-BORNE	SEISMIC	SUBJECT TO DAMAGE FROM			WINTER	ICE BARRIER	FLOOD	AIR	MEAN
SNOW	SPEED	EFFECTS	WIND	DEBRIS	DESIGN	WEATHERING	FROST	TERMITE	DESIGN	UNDERLAYMENT	HAZARDS	FREEZING	ANNUAL
LOAD	(MPH)		REGION	ZONE	CATEGORY		DEPTH		TEMP	REQUIRED		INDEX	TEMP
30 PSF	115-120	NO	YES	NO	С	SEVERE	3'6"	MODERATE/	15°F	YES	NO	2000	51.6°F

DRAWING INDEX

NO.	SHEET	ISSUE DATE	REV. DATE
T-000.00	Title Sheet & Notes	7/14/23	
S-000.00	Site Plan, Site Photos Existing	7/14/23	
A-101.00	Lower Level Plans Exstg + Proposed	7/14/23	
A-102.00	1st FLoor Plans - Exstg + Proposed	7/14/23	
A-103.00	Kitchen Detail Plan + Elevation-Sections	7/14/23	
A-104.00	Living Room Ceiling Plan + Section	7/14/23	
A-105.00	Window + Interior Door Schedule	7/14/23	
A-106.00	Electrical, Lighting, Ceiling Plans	7/14/23	
A-107.00	Existing Exterior Elevations	7/14/23	
A-108.00	Proposed Exterior Elevations	7/14/23	

STRUCTURAL & LOADING NOTES

Design bearing capacity of soil shall be 2,000 PSI in accordance with 2020 Residential Code of New York State R401.4.1 for Sand, Silty Sand, Clayey Sand

Concrete Compressive Strength


Shall be Min. 3,000 PSI at exposed exterior walls; shall be Min. 2,500 PSI at basement slabs; and shall be Min. 3,500 PSI at horizontal surfaces exposed to the weather including porches, steps, walks, and garage floor slabs, all to be in compliance with the 2020 Residential Code of New York State

Provide exterior placard as required by code indicating that engineered lumber is used for roof support in a Class V structure. Placard is to be permanentlymounted for display as required near electrical meter or as directed in field by

Provide strapping as required to resist high wind and uplift forces to be in compliance with table R802.11 of the Code. Use tension tie equal to Simpson model # HTT22 at all footing-post connections and equal to Simpson model #H2 at all post-plate-rafter connections.

NO. REVISIONS

NO.	ISSUE	DATE
В	Revised Filing	7/14/23

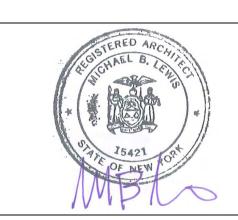

Michael Lewis Architects PC 145 Palisade St. Suite #307

Dobbs Ferry, NY 10522 tel 914-231-7700, fax 914-231-7701 info@mlarchitect.com www.mlarchitect.com

> PROJECT: 3 WOODBINE ROAD IRVINGTON, NY 10533

DRAWING TITLE:

TITLE SHEET & NOTES

FILE NAME:

DRAWN BY:	PG	
SCALE:	As Noted	
DATE:	7/14/23	
PROJECT ID:	2214A	

DRAWING NUMBER



1 - EXISTING "FRONT" -VIEW FROM WOODBINE ROAD



2 - EXISTING "NORTH SIDE ELEVATION"



3 - EXISTING REAR ELEVATION





- NO CHANGE IN BUILDING FOOTPRINT
- NO CHANGE IN SITE COVERAGE - EXTERIOR WORK
- NEW WINDOWS IN EXSTG OPENINGS WITH 1 NEW WINDOW OPENING ON THE SOUTH SIDE ELEVATION

3 WOODBINE ROAD - IRVINGTON NY. 10533

SECTION: 2.80 BLOCK: 39

BY: VINCENT TEUTONICO - NY STATE LIC. SURVEYOR DATE: 5/27/21



5 - EXISTING "SOUTH SIDE ELEVATION"

4 - EXISTING "SOUTH SIDE ELEVATION AND REAR ELEVATION"



6 - EXISTING FRONT ENTRY

NO. REVISIONS NO. ISSUE DATE **Revised Filing** 7/14/23

© 2022 Michael Lewis Architects P.C.

Michael Lewis Architects PC

145 Palisade St. Suite #307 Dobbs Ferry, NY 10522 tel 914-231-7700, fax 914-231-7701 info@mlarchitect.com www.mlarchitect.com

PROJECT:

DRAWING TITLE:

SCALE:

PROJECT ID:


DATE:


3 WOODBINE ROAD IRVINGTON, NY 10533


EXISTING SITE PLAN, PHOTOS


FILE NAME: DRAWN BY:


DRAWING NUMBER S-000.00 7/14/23 2214A

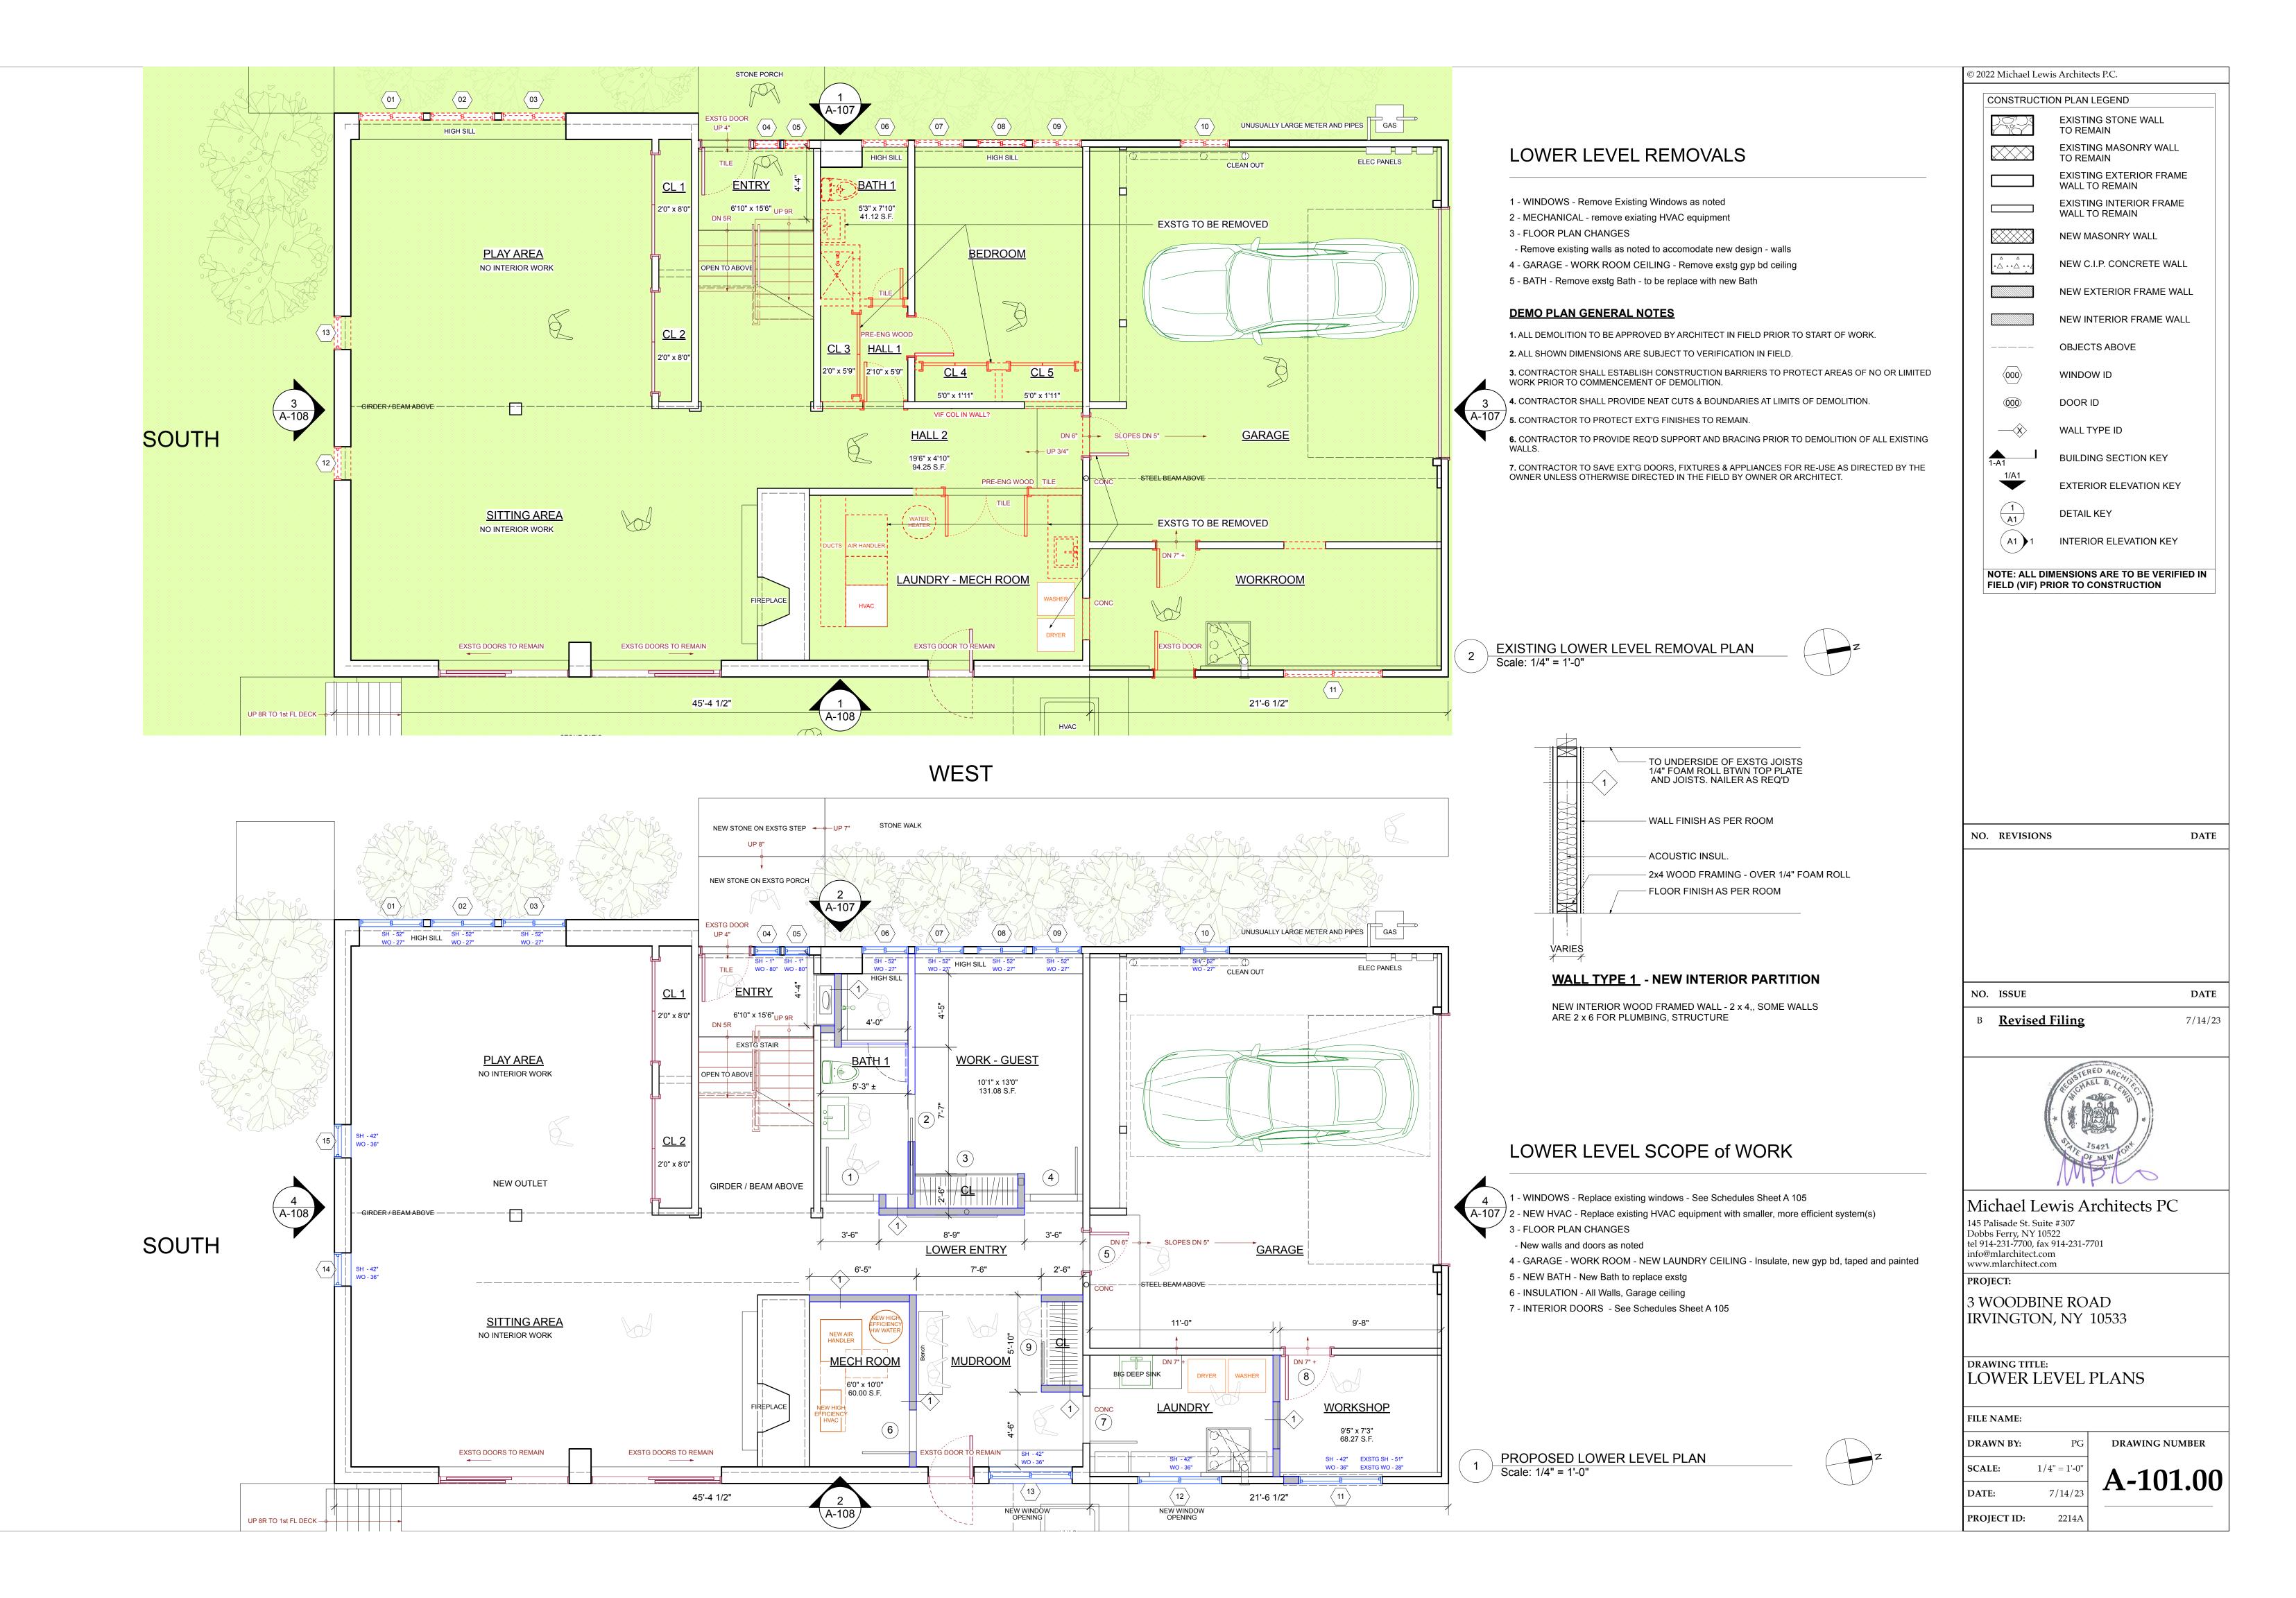


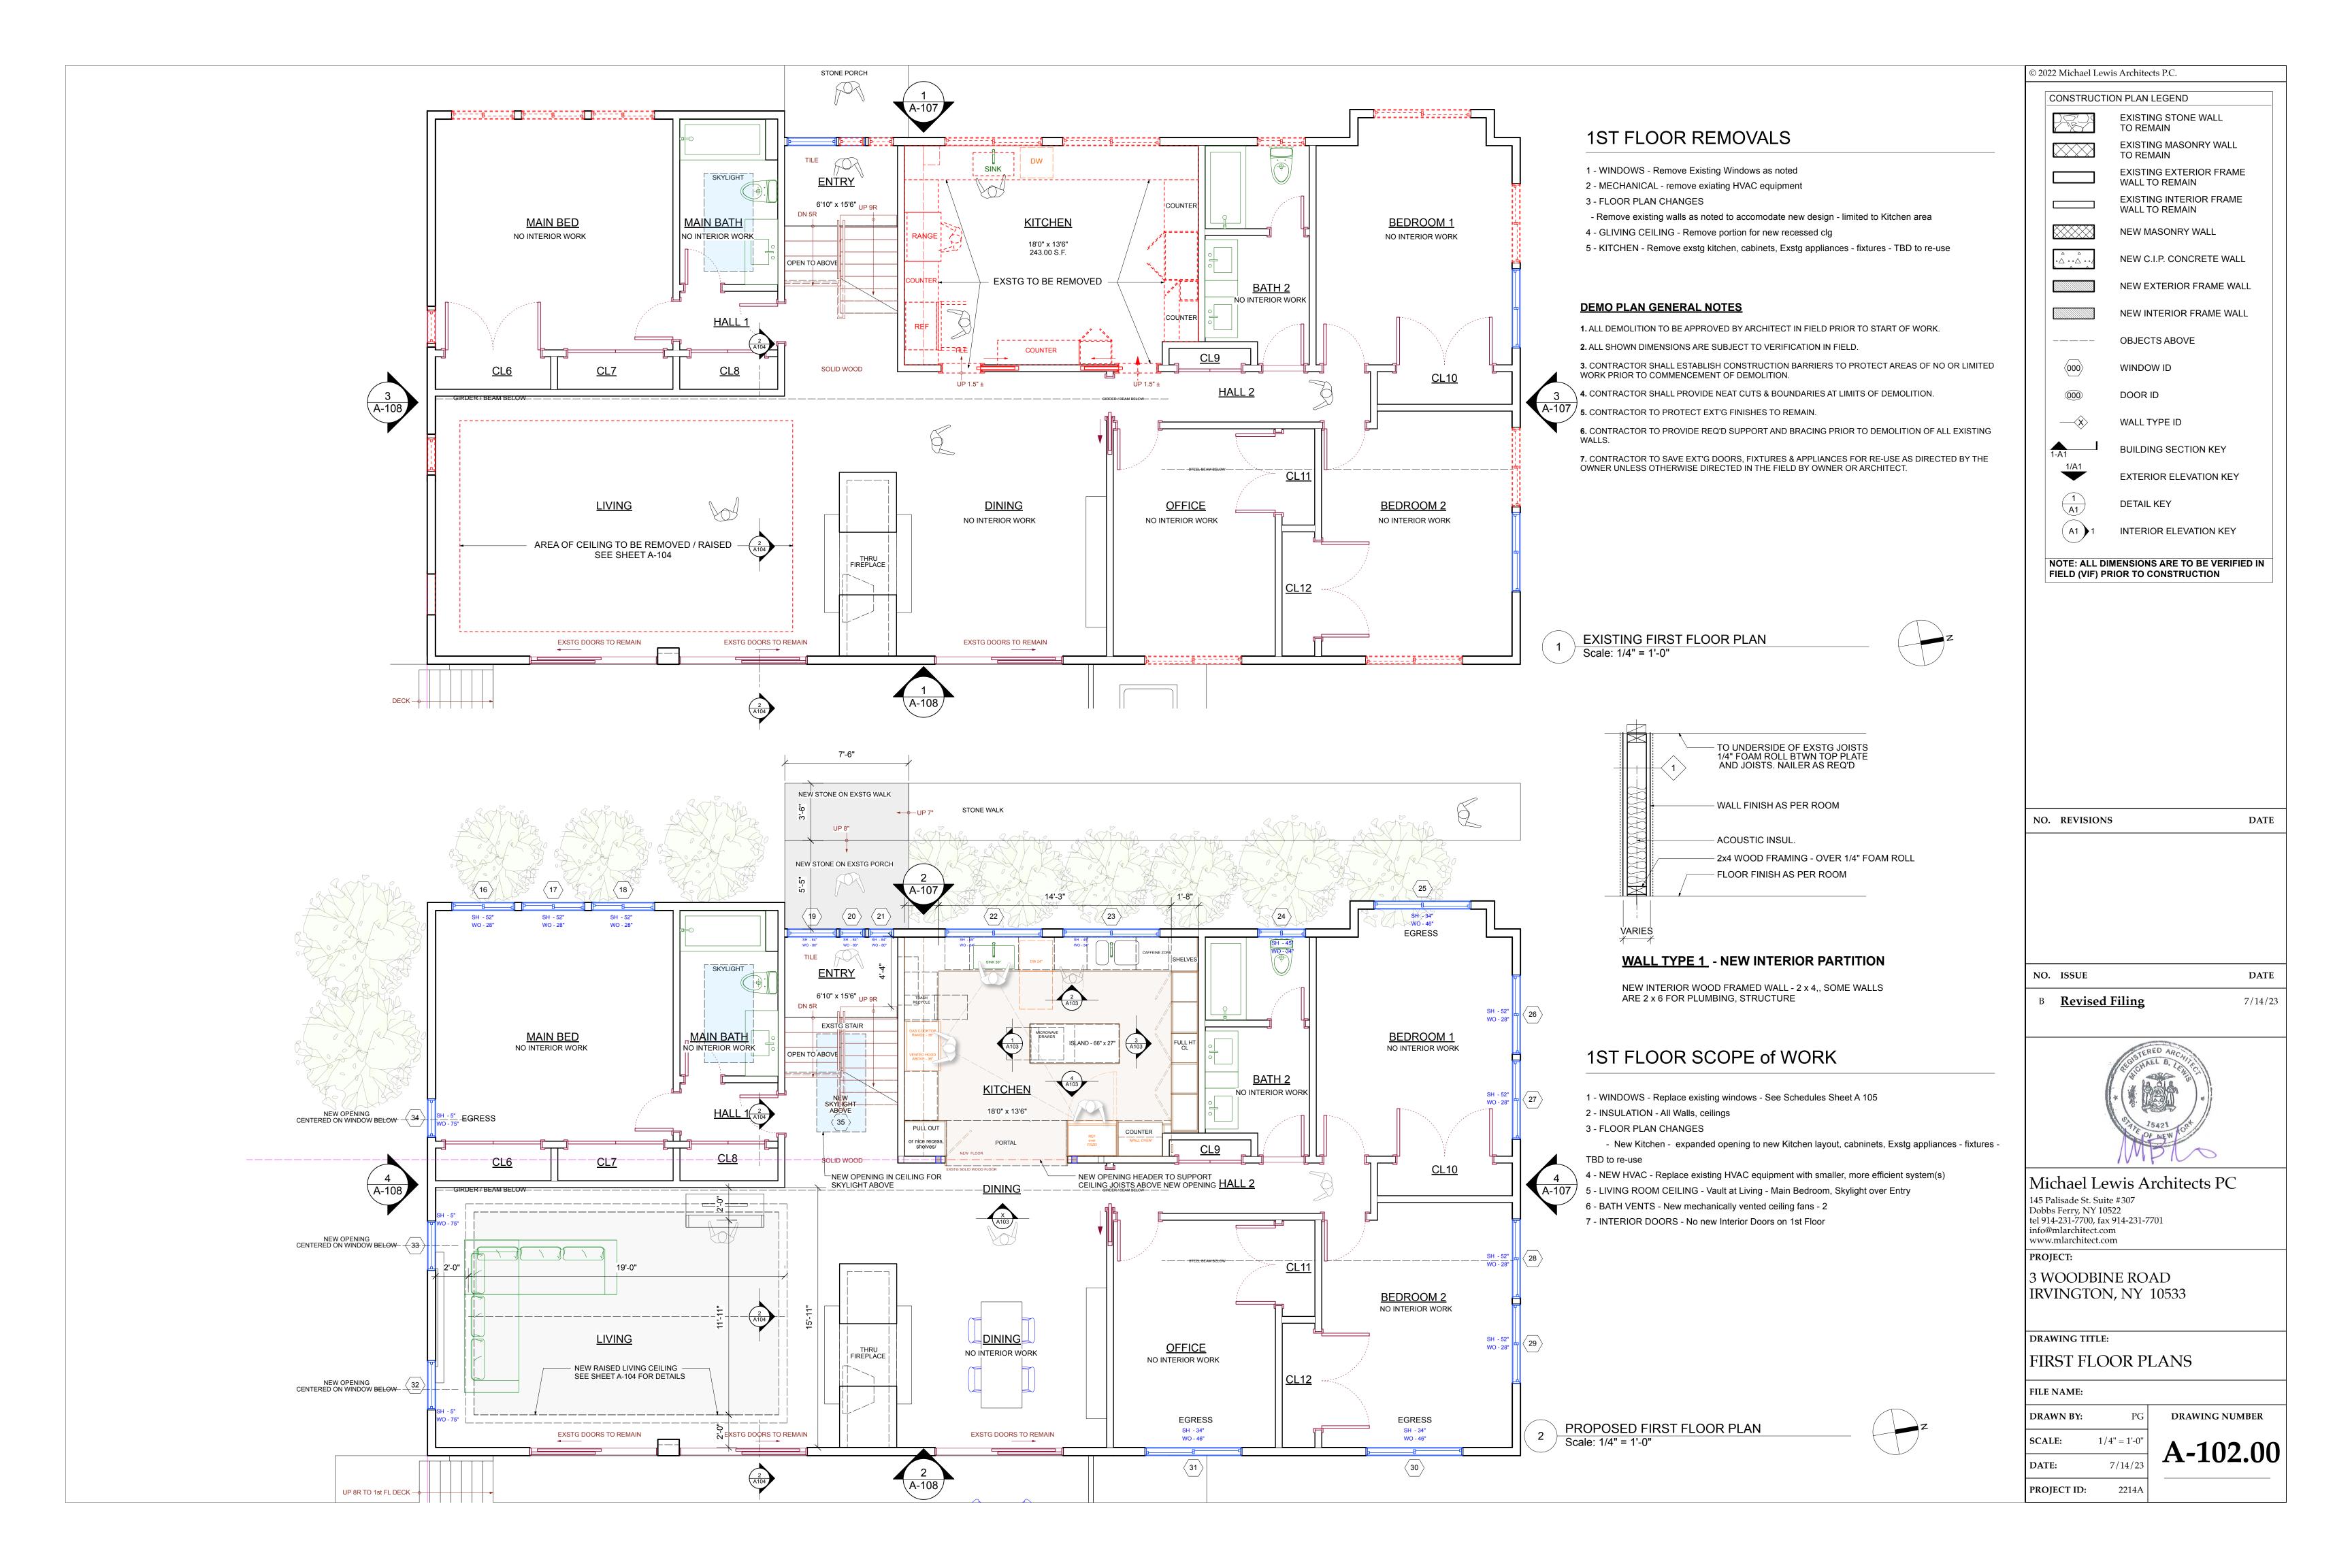


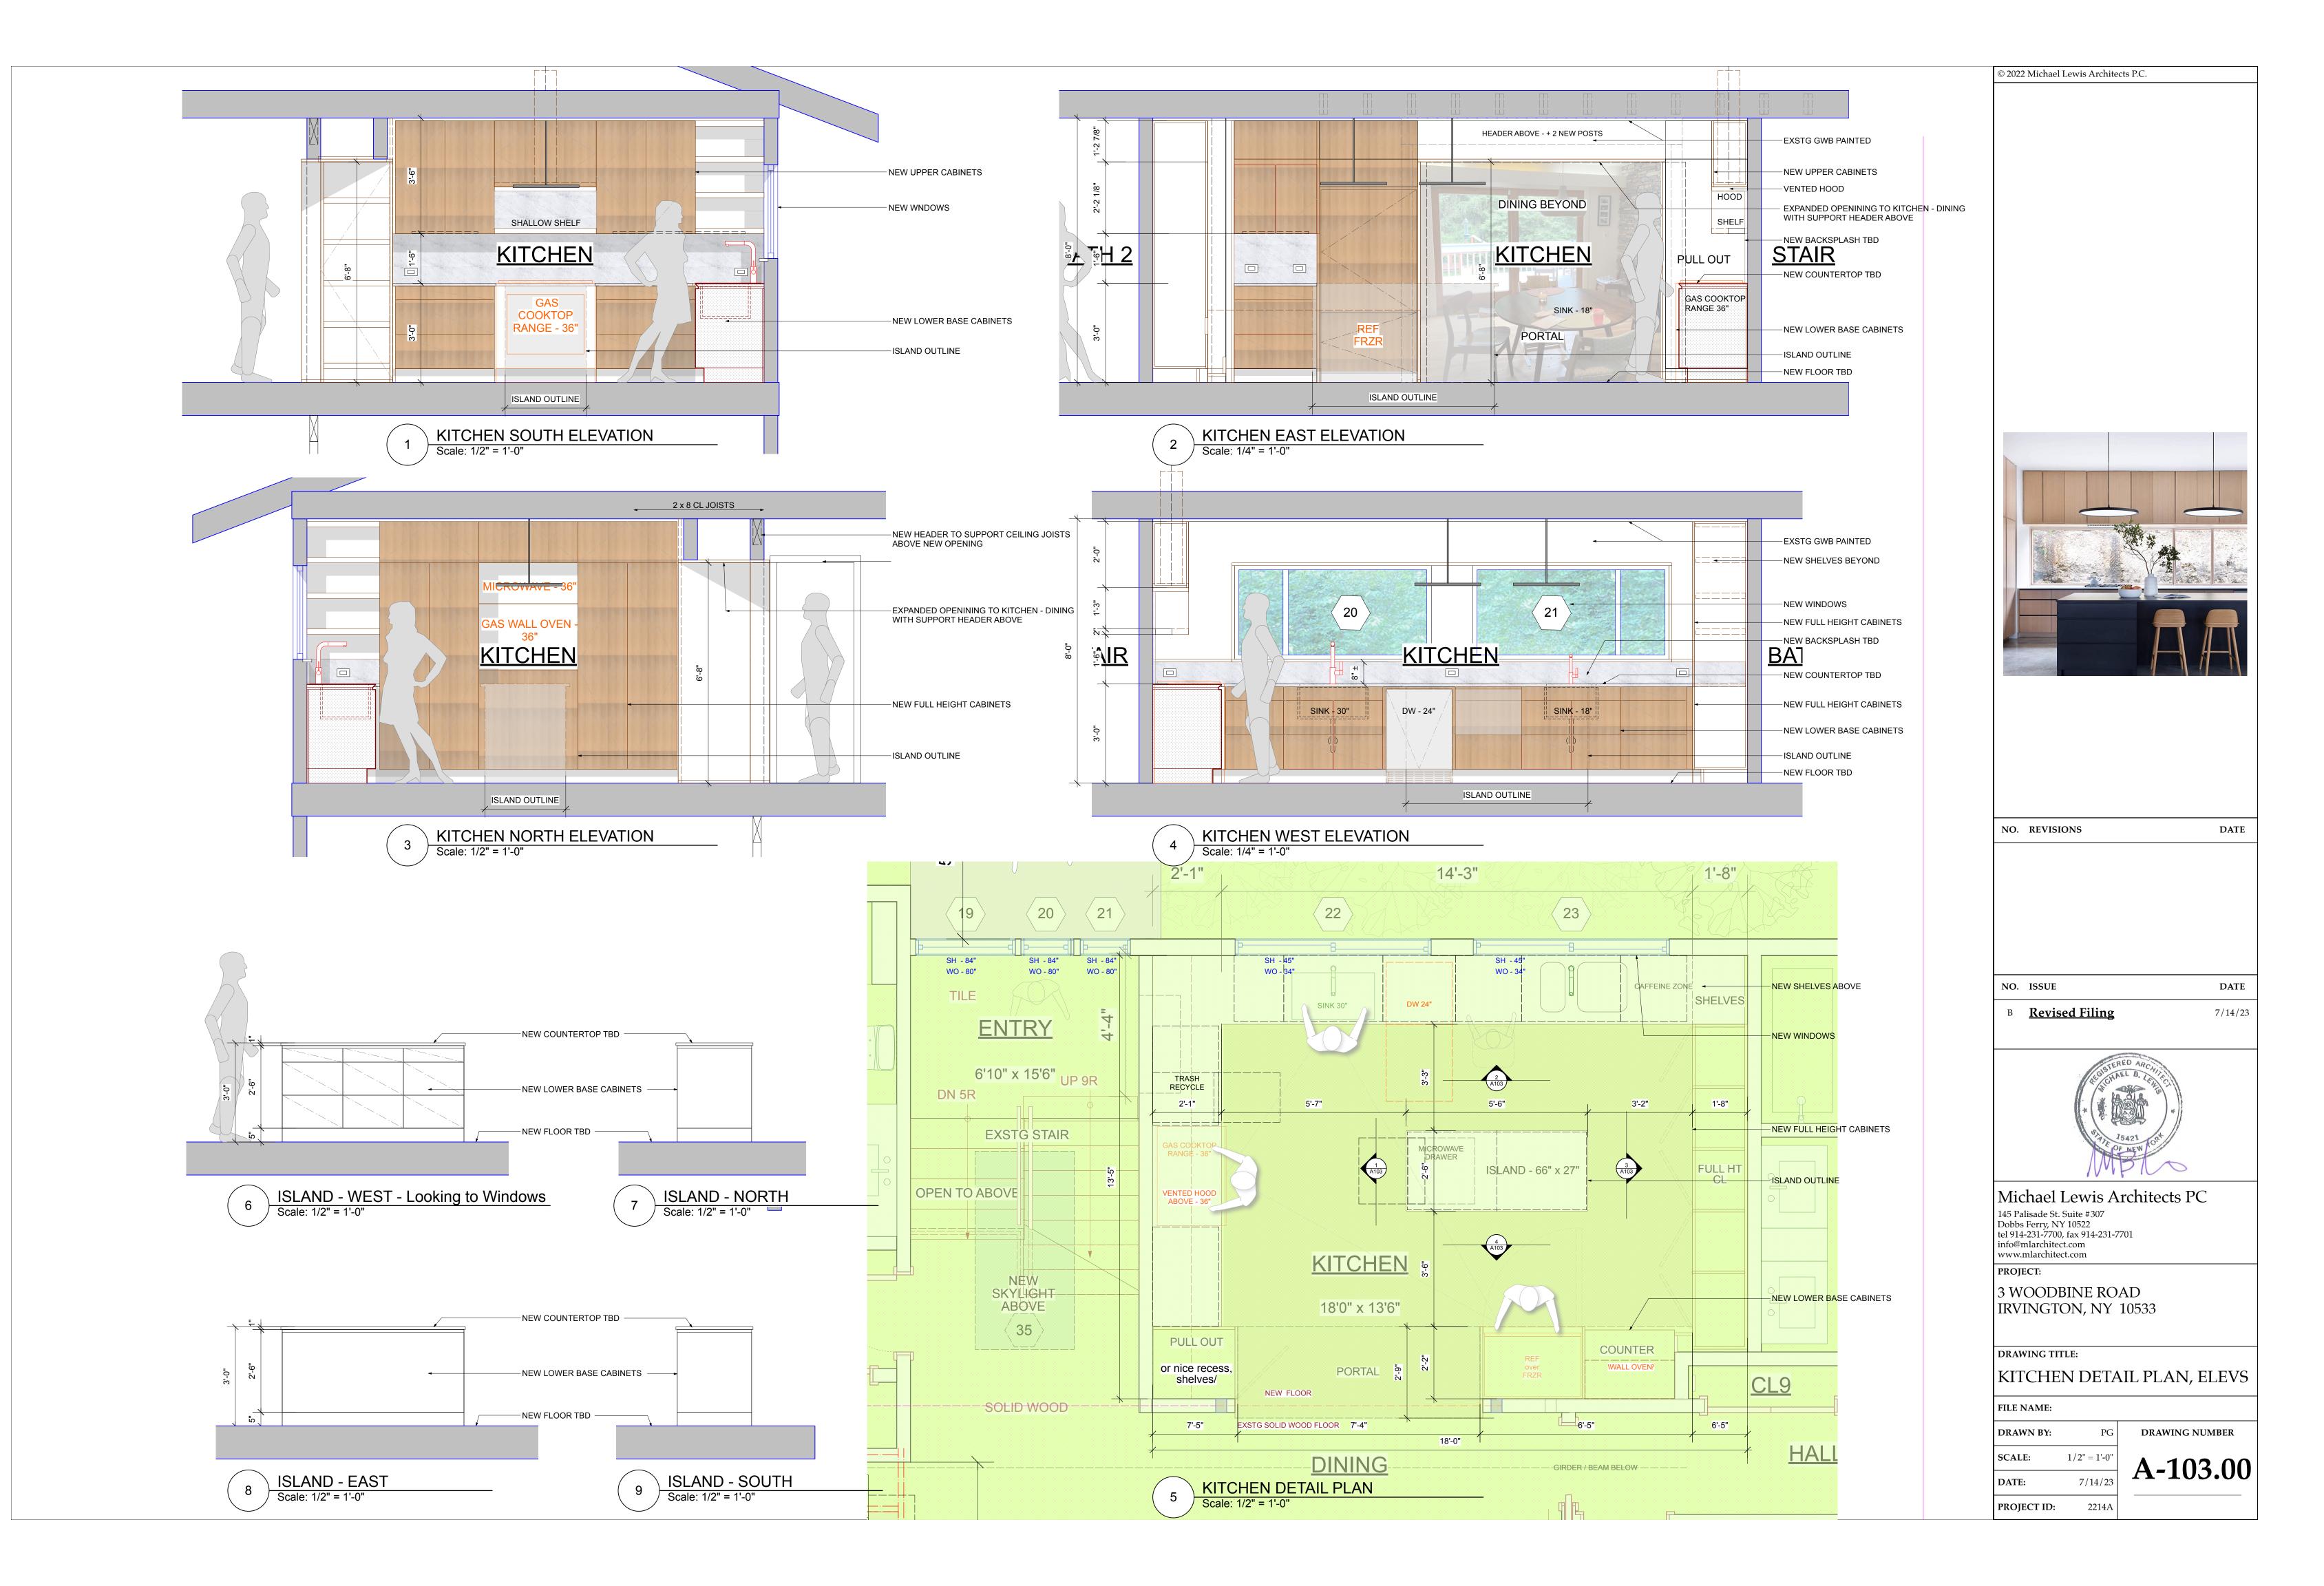

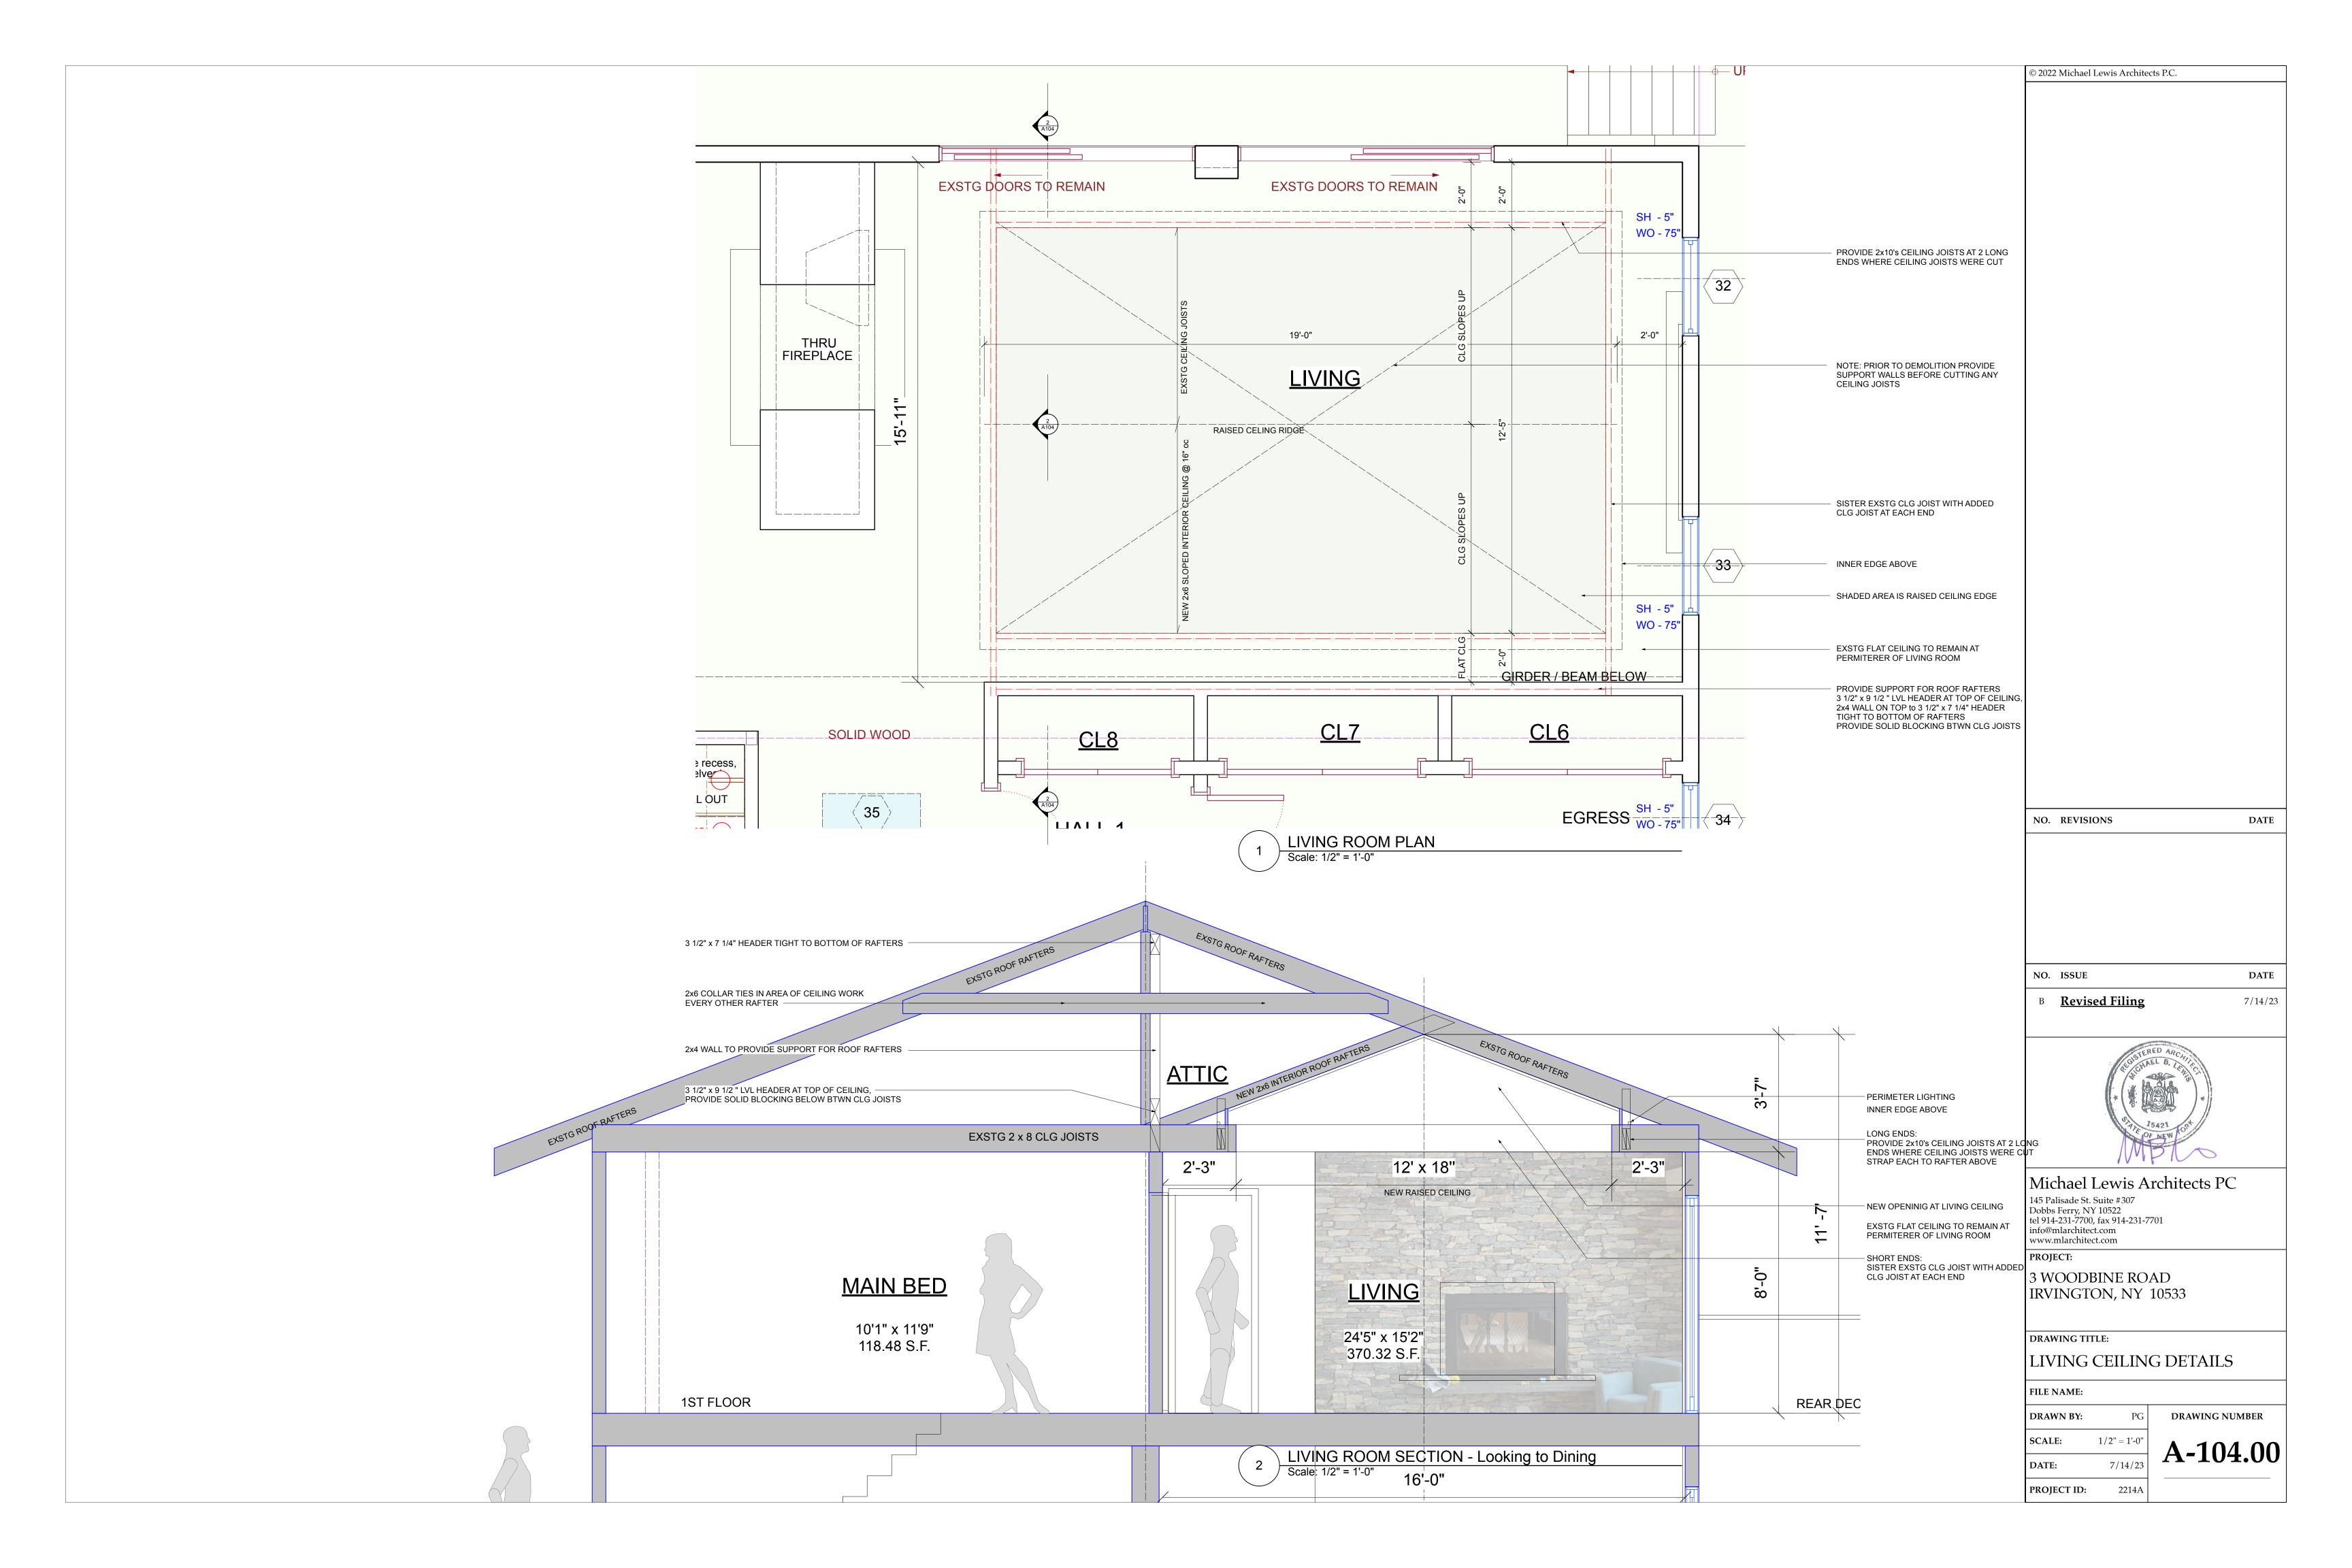

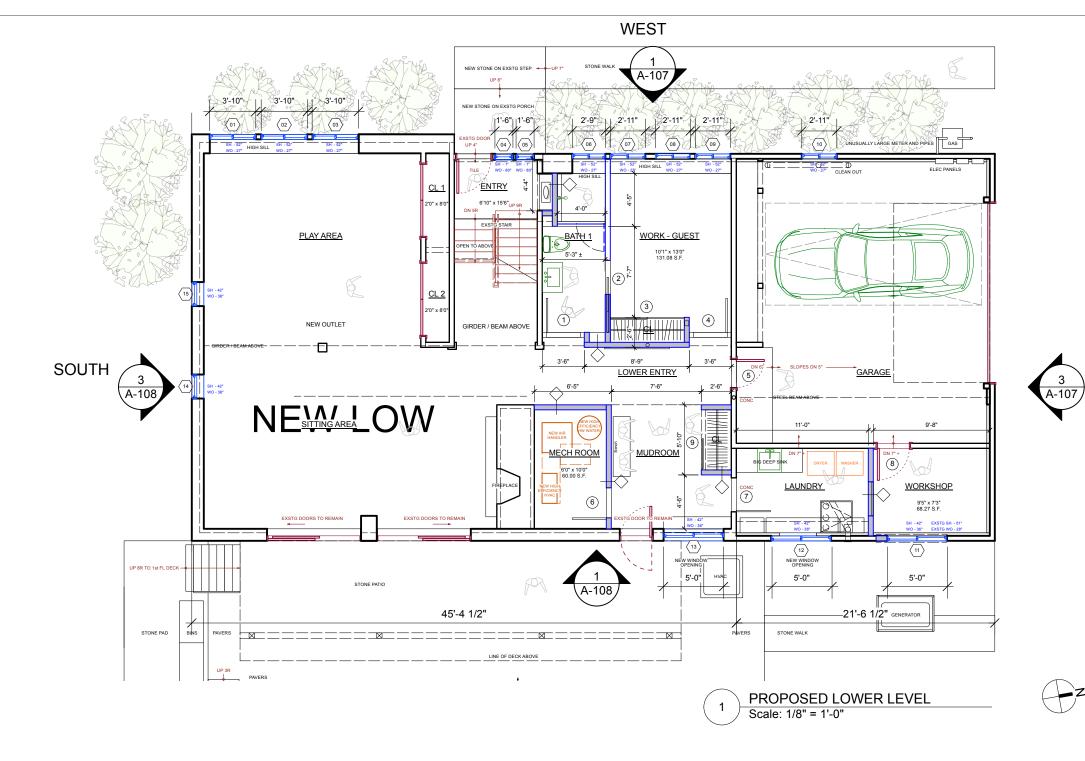

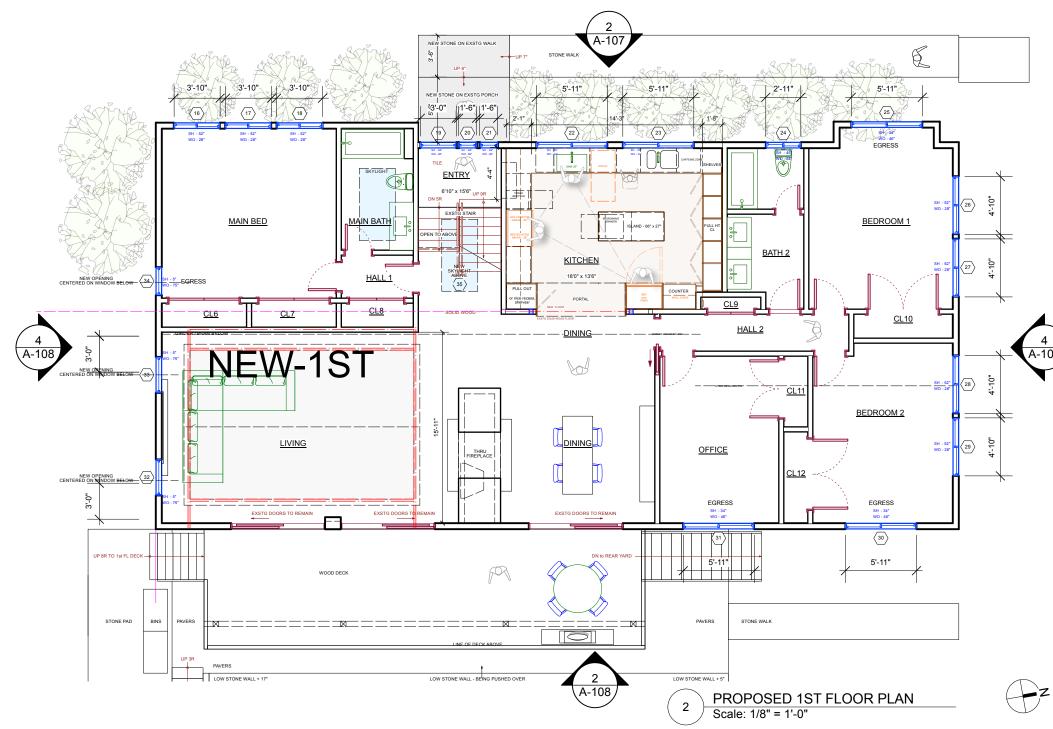

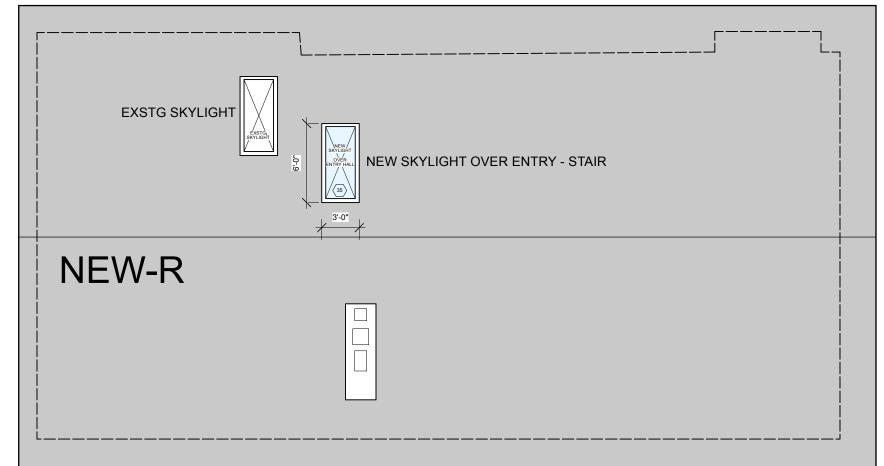

3 PROPOSED ROOF PLAN Scale: 1/8" = 1'-0"	Z

No.	Location	Description	Manuf.	Model No.	RO Width	RO Height	Hdr Ht	<u>Jam</u> b	Grille/SDL Exterior Fin Interior Fin	<u>Hardware</u>	U-Fact	SHGC	Remarks
	LOWER LEVEL												
1	Play Area	Glider	Marvin - Essential	-	3'10"	2'3"			Fiberglass Fiberglass				
2	Play Area	Glider	Marvin - Essential	1	3'10"	2'3"			Fiberglass Fiberglass				
3	Play Area	Glider	Marvin - Essential	-	3'10"	2'3"			Fiberglass Fiberglass				
4	Entry	Fixed	Marvin - Essential	-	1'6"	6'8"			Fiberglass Fiberglass				
5	Entry	Fixed	Marvin - Essential	-	1'6"	6'8"			Fiberglass Fiberglass				
6	Bath 1	Glider	Marvin - Essential	-	2'9"	2'3"			Fiberglass Fiberglass				
7	Work - Guest	Glider	Marvin - Essential	_	2'11"	2'3"			Fiberglass Fiberglass				
8	Work - Guest	Glider	Marvin - Essential	-	2'11"	2'3"			Fiberglass Fiberglass				
9	Work - Guest	Glider	Marvin - Essential	_	2'11"	2'3"			Fiberglass Fiberglass				
10	Garage	Glider	Marvin - Essential	_	2'11"	2'3"			Fiberglass Fiberglass				
11	Workshop	Glider	Marvin - Essential	-	5'0"	3'-0"			Fiberglass Fiberglass				
12	Laundry	Glider	Marvin - Essential	-	5'0"	3'-0"			Fiberglass Fiberglass				
13	Mudroom	Glider	Marvin - Essential	-	5'0"	3'-0"			Fiberglass Fiberglass				
14	Sitting Area	Fixed	Marvin - Essential	-	5'0"	3'-0"			Fiberglass Fiberglass				
15	Play Area	Fixed	Marvin - Essential	-	5'0"	3'-0"			Fiberglass Fiberglass				
	1st FLOOR												
16	Main Bed	Glider	Marvin - Essential	-	3'10"	2'4"			Fiberglass Fiberglass				
17	Main Bed	Glider	Marvin - Essential	_	3'10"	2'4"			Fiberglass Fiberglass				
18	Main Bed	Glider	Marvin - Essential	-	3'10"	2'4"			Fiberglass Fiberglass				
19	Entry	Fixed	Marvin - Essential	-	3'0"	6'8"			Fiberglass Fiberglass				
20	Entry	Fixed	Marvin - Essential		1'6"	6'8"			Fiberglass Fiberglass				
21	Entry	Fixed	Marvin - Essential	_	1'6"	6'8"			Fiberglass Fiberglass				
22	Kitchen	Glider	Marvin - Essential	_	5'11"	2'10"			Fiberglass Fiberglass				
23	Kitchen	Glider	Marvin - Essential	-	5'11"	2'10"			Fiberglass Fiberglass				
24	Bath 2	Glider	Marvin - Essential	-	2'11"	2'10"			Fiberglass Fiberglass				
25	Bed 1	Glider	Marvin - Essential	_	5'11"	3'10"			Fiberglass Fiberglass				EGRESS
26	Bed 1	Glider	Marvin - Essential	-	4'10"	2'10"			Fiberglass Fiberglass				
27	Bed 1	Glider	Marvin - Essential	-	4'10"	2'10"			Fiberglass Fiberglass				
28	Bed 2	Glider	Marvin - Essential	-	4'10"	2'10"			Fiberglass Fiberglass				
29	Bed 2	Glider	Marvin - Essential	-	4'10"	2'10"			Fiberglass Fiberglass				
30	Bed 2	Glider	Marvin - Essential	-	5'11"	3'10"			Fiberglass Fiberglass				EGRESS
31	Office	Glider	Marvin - Essential	-	5'11"	3'10"			Fiberglass Fiberglass				EGRESS
32	Living	Casement	Marvin - Essential	-	3'0"	6'3"			Fiberglass Fiberglass				
33	Living	Casement	Marvin - Essential	-	3'0"	6'3"			Fiberglass Fiberglass				
34	Main Bed	Casement	Marvin - Essential	-	2'4	6'3"			Fiberglass Fiberglass				EGRESS
	ROOF	0		• • •									.,,
35	Over Entry	Skylight	Velux	S 06	3'0	6'0			Aluminum				Velux - 800-888-3589

lo.	Loc.	Door					Frame				Remarks
		Туре	Mat.	Width	Height	Thick	Туре	Mat.	Sill	HRDW	
	1st FLOOR	0 Doors									
	NO NEW DOORS	-	-	-	-	-	-	-	-	-	
	LOWER LEVEL	9 Doors									
1	BATH 1	A	WD	3'0"	6'8"	1 1/2"	SWING	WD		А	
2	BATH 1	В	WD	3'0"	6'8"	1 1/2"	SLIDER	WD		С	
3	WORK-GUEST CL	С	WD	5'0"	6'8"	1 1/2"	SLIDERS	WD		А	
4	WORK-GUEST	A	WD	3'0"	6'8"	1 1/2"	SWING	WD		А	4 SIDED DOOR FRAME GASKET
5	LOWER ENTRY	A	WD	3'0"	6'8"	1 1/2"	SWING	WD		А	
6	MECH ROOM	A	WD	3'0"	6'8"	1 1/2"	SWING	WD		С	2 HR FIRE RATED
7	LAUNDRY	A	WD	3'0"	6'8	1 1/2"	SWING	WOOD			4 SIDED DOOR FRAME GASKET
8	WORKSHOP	A	WD	3'0"	6'8"	1 1/2"	SWING	WD		А	
9	MUDROOM	С	WD	5'0"	6'8"	1 1/2"	SLIDERS	WD		А	

Door Type Key

- A. WOOD FLUSH SOLID CORE DOOR PAINTED COLOR TBD
- B. WOOD SINGLE SLIDER
 C. WOOD 2 SLIDERS

Hardware Key

- A. PRIVACY AS PER CLIENT SPEC
- B. PRIVACY AS PER CLIENT SPEC
- B. PRIVACY AS PER CLIENT SPEC
 D. PRIVACY AS PER CLIENT SPEC

NO. ISSUE DATE B Revised Filing 7/14/23

DATE

© 2022 Michael Lewis Architects P.C.

Michael Lewis Architects PC

145 Palisade St. Suite #307 Dobbs Ferry, NY 10522 tel 914-231-7700, fax 914-231-7701 info@mlarchitect.com www.mlarchitect.com

NO. REVISIONS

PROJECT: 3 WOODBINE ROAD IRVINGTON, NY 10533


DRAWING TITLE: WINDOWS - INTERIOR DOORS

2214A


PROJECT ID:

FILE NAME: **DRAWN BY:** 1/8" = 1'-0"**SCALE:** 7/14/23 DATE:

DRAWING NUMBER

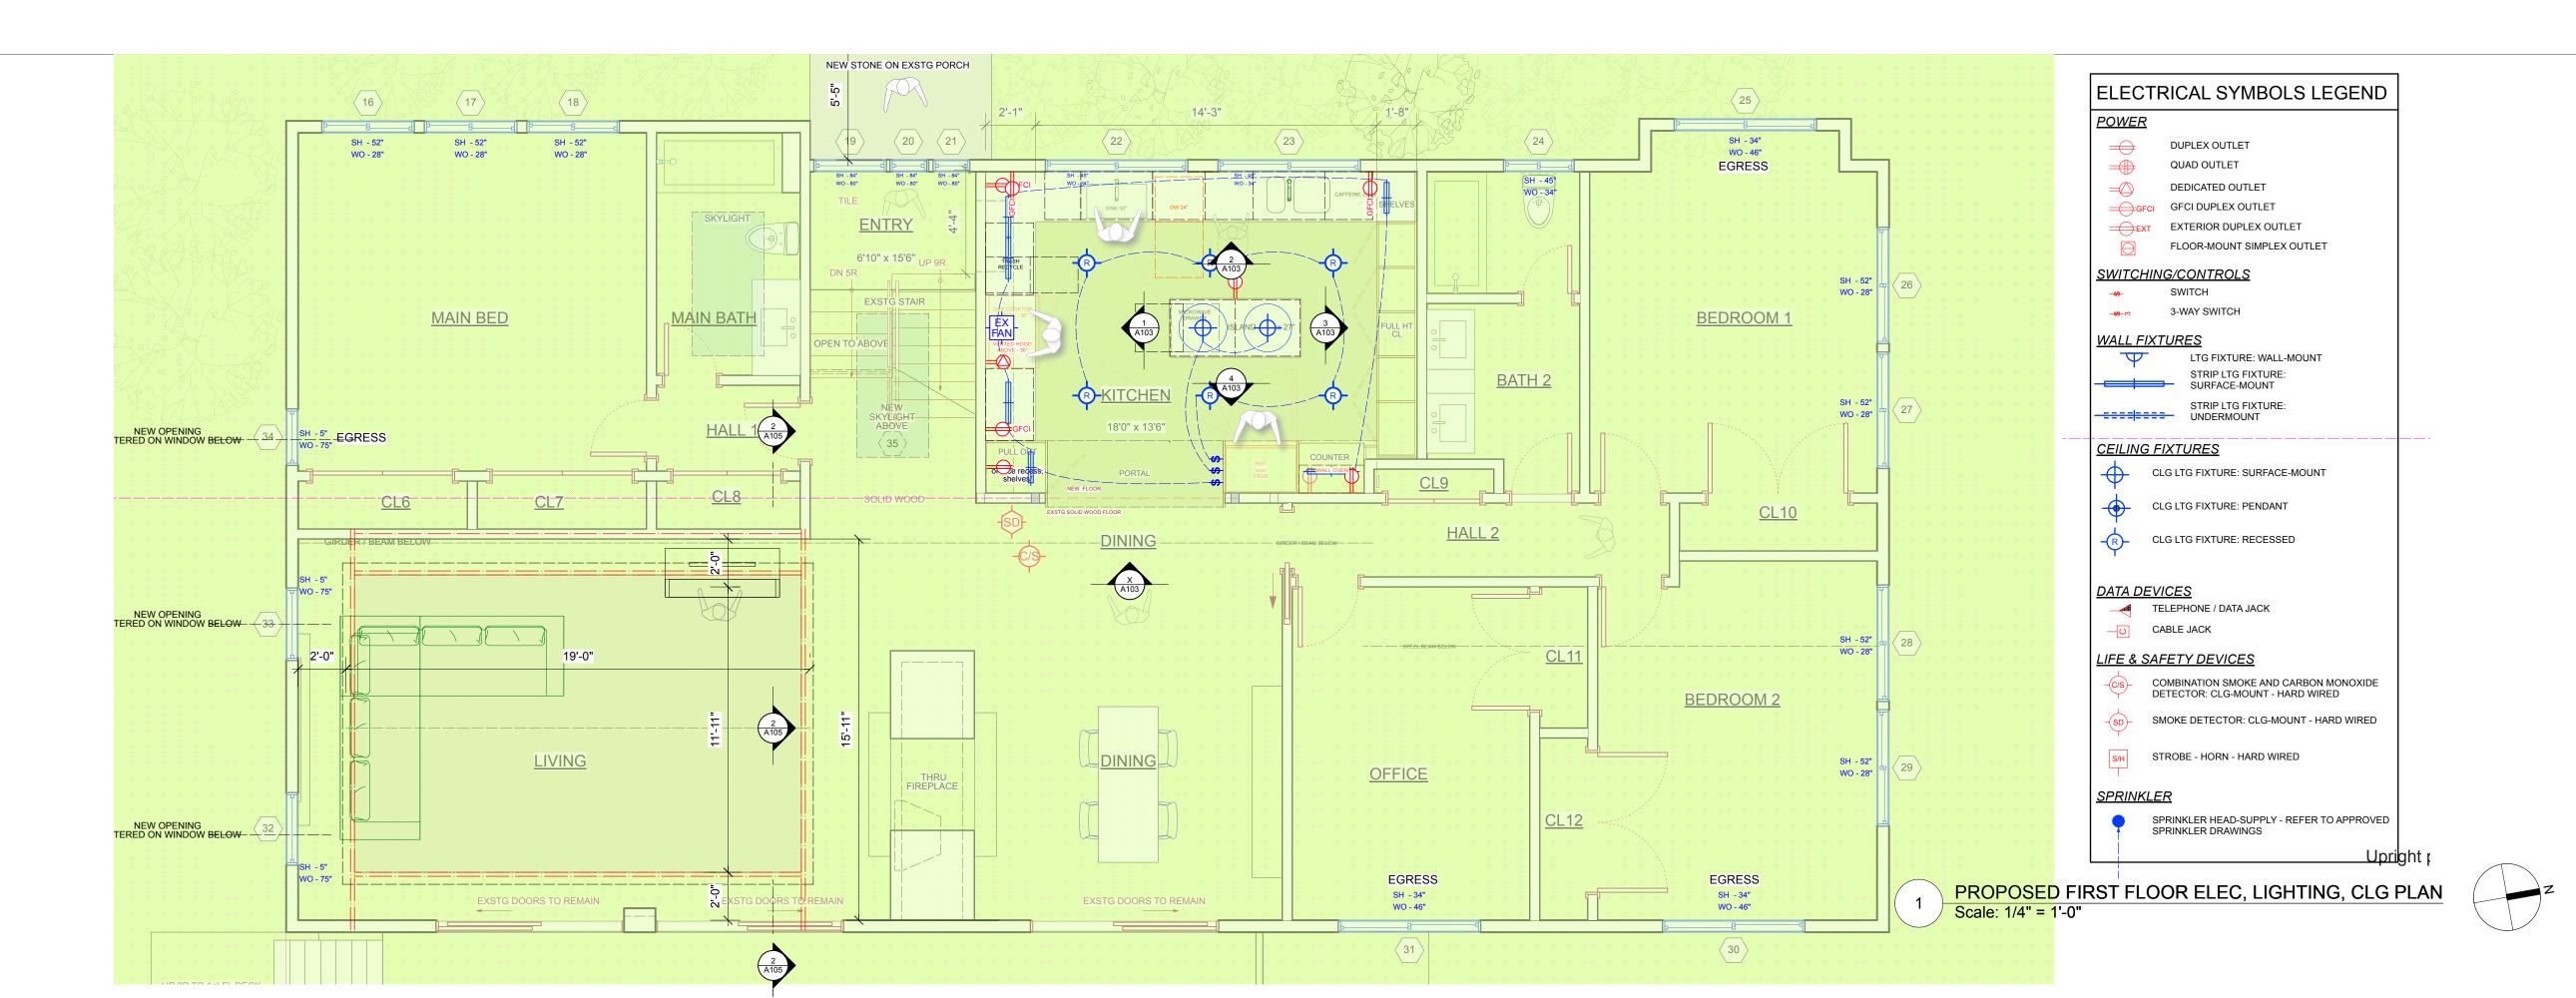



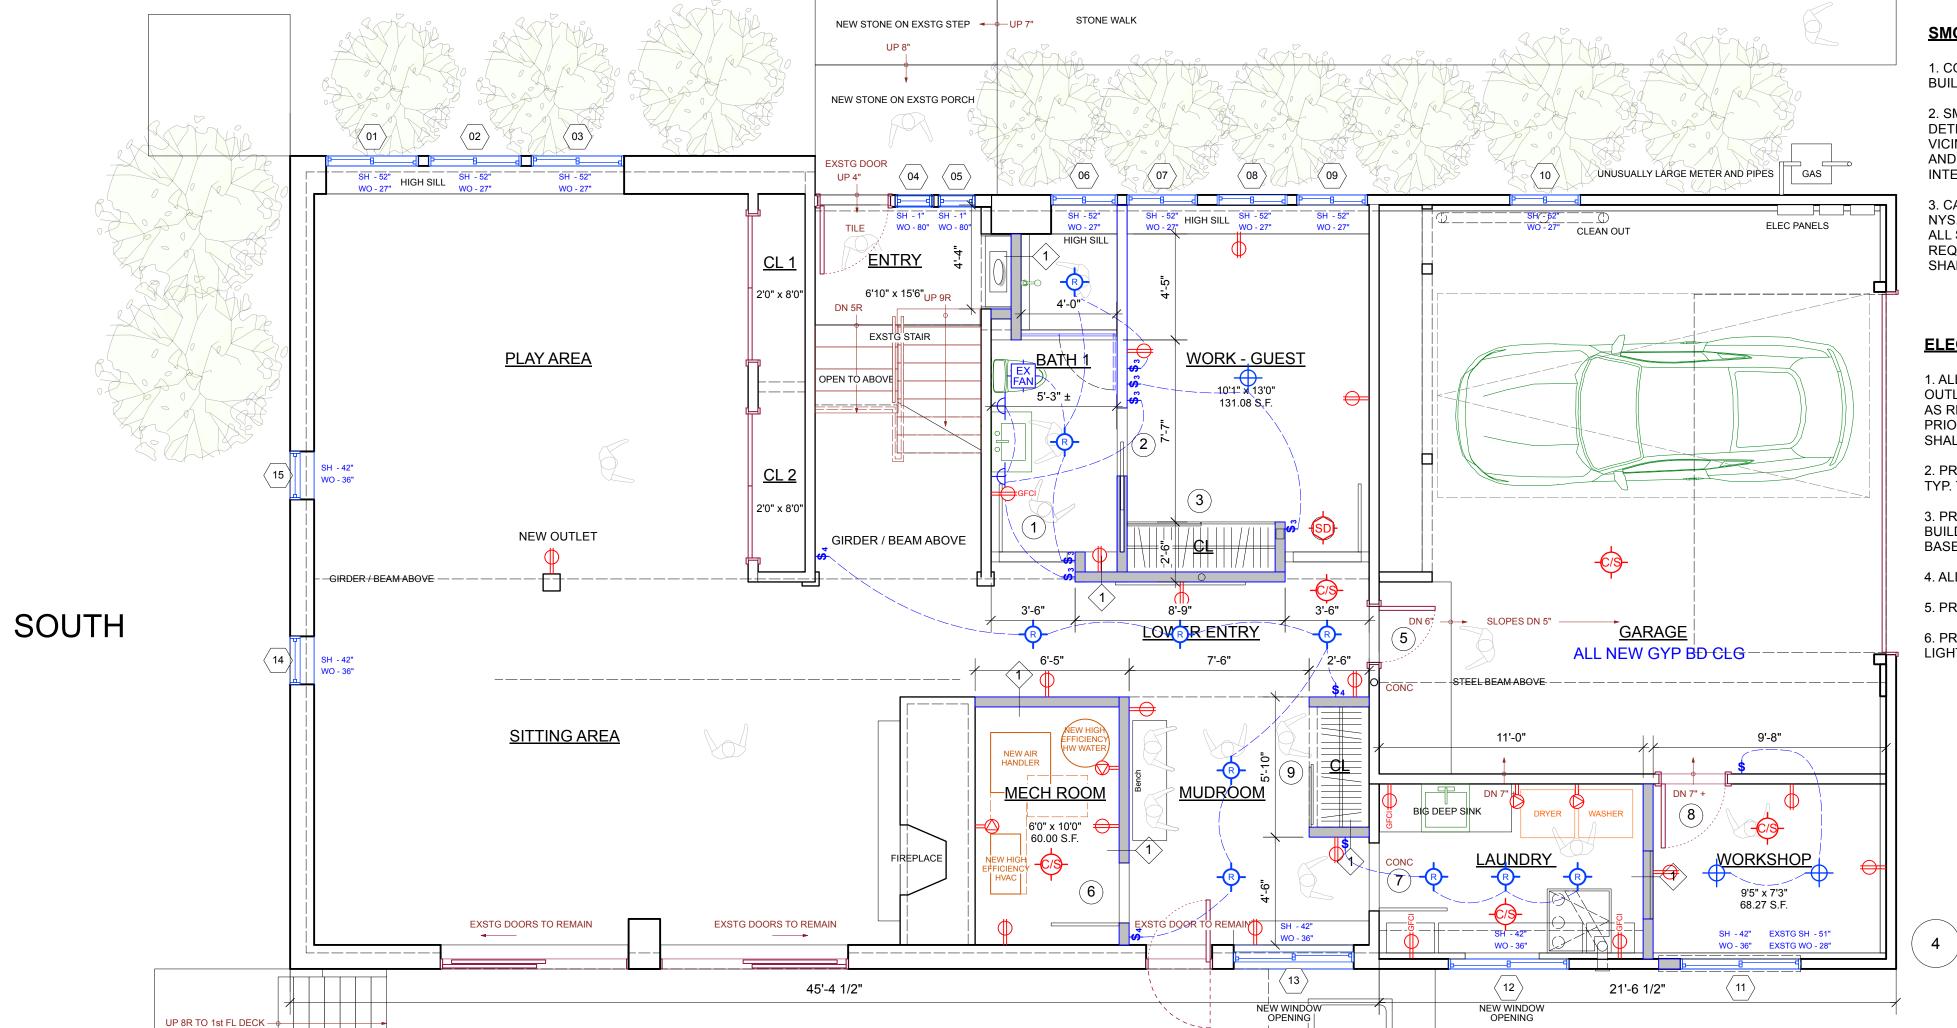

SMOKE AND CARBON MONOXIDE ALARMS

1. CONTRACTOR SHALL PROVIDE SMOKE AND CO DETECTORS THROUGHOUT AS REQUIRED BY THE 2020 BUILDING CODE OF NYS.

2. SMOKE DETECTORS SHALL MEET ALL REQUIREMENTS OF THE 2020 BUILDING CODE OF NYS. SMOKE DETECTORS ARE REQUIRED TO BE INSTALLED IN ALL SLEEPING ROOMS AND IN AREAS IN THE IMMEDIATE VICINITY OF SLEEPING ROOMS. SMOKE DETECTORS SHALL BE HARD-WIRED WITH BATTERY BACK UP AND INTERCONNECTED. SMOKE DETECTORS SHALL BE PERMITTED TO BE BATTERY WHERE EXISTING INTERIOR WALL OR CLG FINISHES ARE NOT REMOVED TO THE STRUCTURE.

3. CARBON MONOXIDE DETECTORS SHALL MEET ALL REQUIREMENTS OF THE 2020 BUILDING CODE OF NYS. CARBON MONOXIDE DETECTORS ARE REQUIRED TO BE INSTALLED IN THE IMMEDIATE VICINTY OF ALL SLEEPING AREAS. MORE THAN ONE CARBON MONOXIDE DETECTOR SHALL BE PROVIDED AS REQUIRED TO ASSURE THAT NO SLEEPING AREA IS MORE THAN 15 FEET FROM ALARM. DETECTORS SHALL BE HARD-WIRED WITH BATTERY BACK UP.

ELECTRICAL NOTES

1. ALL EQUIPMENT, DEVICE, AND FIXTURE LOCATIONS ARE SCHEMATIC. ONLY DEDICATED AND GFCI OUTLET LOCATIONS SHOWN ON PLANS. GC SHALL PROVIDE FOR ALL OTHER REGULAR DUPLEX OUTLETS AS REQUIRED BY CODE. FINAL LOCATIONS TO BE DETERMINED IN FIELD WITH OWNER OR ARCHITECT PRIOR TO ROUGH-IN: TYP. THROUGHOUT. ELECTRICAL WORK INSTALLED WITHOUT PRIOR APPROVAL SHALL BE SUBJECT TO RELOCATION AT NO ADDITIONAL CHARGE.

2. PROVIDE ALL ELECTRICAL SUPPLIES AND SHUTOFFS AS REQUIRED BY CODE, TYP. FOR ALL EQUIPMENT, TYP. THROUGHOUT


3. PROVIDE 5 INDIVIDUALLY METERED ELECTRICAL SERVICES: TO EACH OF THE 4 UNITS AND TO THE BUILDING COMMON, OF AT LEAST 220V 100AMP EACH, FINAL SIZE TO BE VERIFIED WITH CON-EDISON BASED ON PROPOSED LOADS AT EACH LOCATION.

4. ALL LIGHT FIXTURES ARE TO BE LED HIGH EFFICACY UNLESS SPECIFICALLY NOTED.

5. PROVIDE ALL LOW VOLTAGE AND COMMUNICATION WIRING AS INDICATED.

6. PROVIDE TEMPORARY ELECTRICAL SERVICE DURING CONSTRUCTION AND PROVIDE TEMPORARY LIGHTING AND POWER THROUGH SITE AS REQUIRED TO SUPPORT ALL CONSTRUCTION ACTIVITIES.

PROPOSED LOWER LEVEL ELEC< LIGHTING, CLG PLAN Scale: 1/4" = 1'-0"

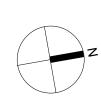

00110111001	
	EXISTING STONE WALL TO REMAIN
	EXISTING MASONRY WALL TO REMAIN
	EXISTING EXTERIOR FRAME WALL TO REMAIN
	EXISTING INTERIOR FRAME WALL TO REMAIN
	NEW MASONRY WALL
	NEW C.I.P. CONCRETE WALL
	NEW EXTERIOR FRAME WALL
	NEW INTERIOR FRAME WALL
	OBJECTS ABOVE
000	WINDOW ID
000	DOOR ID
─ ❖	WALL TYPE ID
1-A1	BUILDING SECTION KEY
1/A1	EXTERIOR ELEVATION KEY
1 A1	DETAIL KEY
A1 1	INTERIOR ELEVATION KEY
	IMENSIONS ARE TO BE VERIFIED IN


2022 Michael Lewis Architects P.C.

CONSTRUCTION PLAN LEGEND

F OF					
	NO.	ISSUE			DATE

DATE

NO. REVISIONS

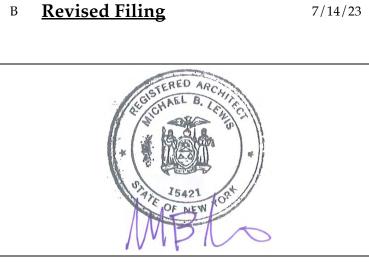

Michael Lewis Architects PC 145 Palisade St. Suite #307 Dobbs Ferry, NY 10522

Dobbs Ferry, NY 10522 tel 914-231-7700, fax 914-231-7701 info@mlarchitect.com www.mlarchitect.com

PROJECT:

3 WOODBINE

3 WOODBINE ROAD IRVINGTON, NY 10533

DRAWING TITLE:
ELEC, LIGHTING, CLG PLANS


FILE NAME:

DRAWN BY:	PG
SCALE:	1/4" = 1'-0"
DATE:	7/14/23
PROJECT ID:	2214A

A-106.00





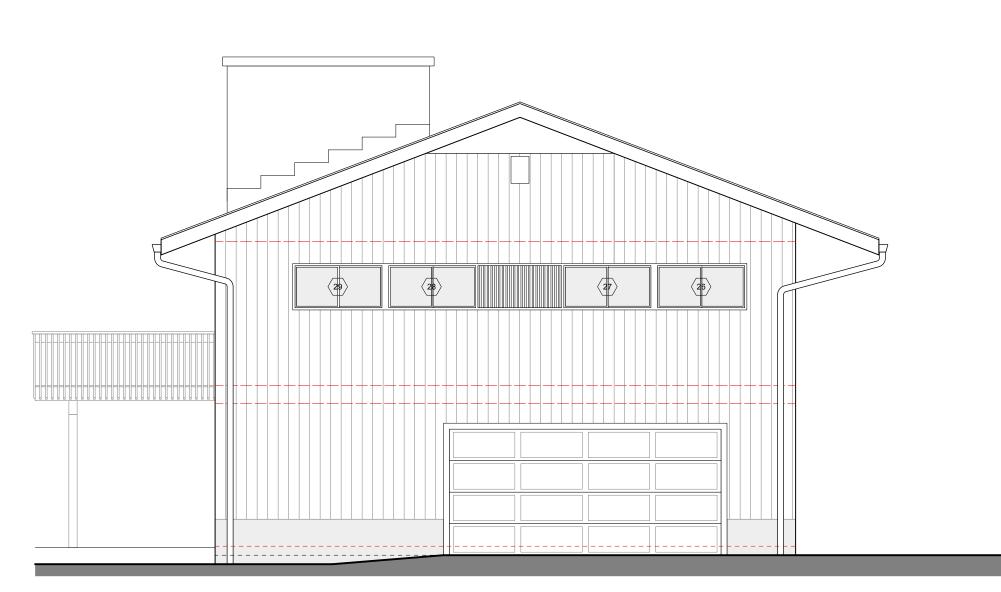

PROPOSED WEST EXTERIOR ELEVATION "FRONT"

Scale: 3/16" = 1'-0"






EXTERIOR MATERIAL FINISHES

WINDOWS EXTERIOR FINISH

MARVIN - ESSENTIAL SERIES
EXTERIOR COLOR - BRONZE



EXISTING EXTERIOR FINISH VERTICAL WOOD PAINTED

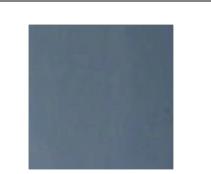

EXISTING EXTERIOR TRIM
EXISTING WOOD TO REMAIN



NEW SKYLIGHT


BRONZE ALUMINUM FRAME
TO MATCH EXISTING




PROPOSED FRONT PORCH STEPS

EXISTING STEPS REPLACED WITH STONE

BLUESTONE

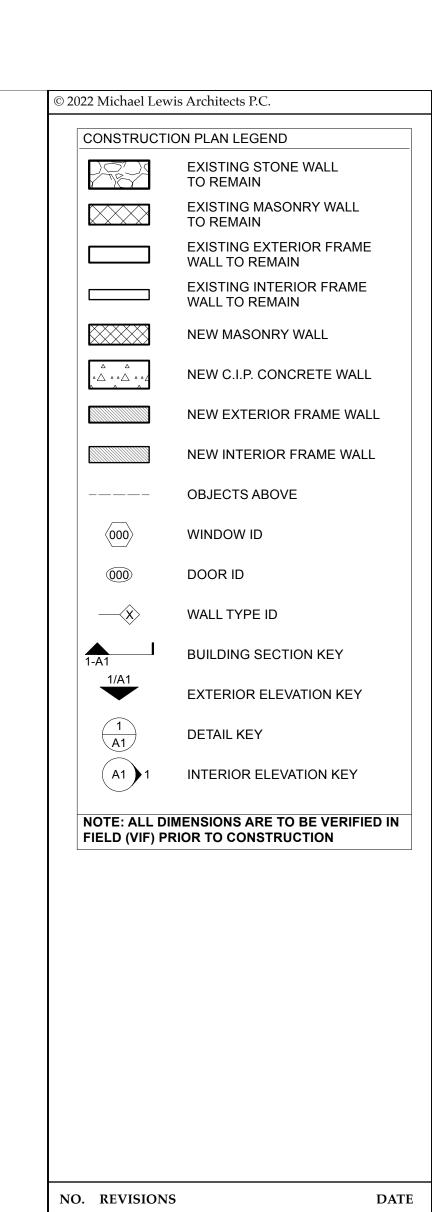

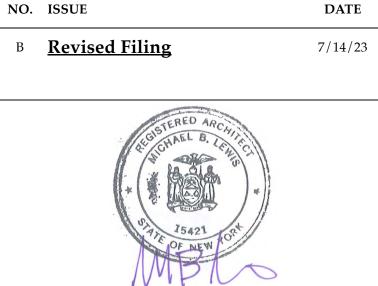

Michael Lewis Architects PC

145 Palisade St. Suite #307

Dobbs Ferry, NY 10522

tel 914-231-7700, fax 914-231-7701
info@mlarchitect.com

www.mlarchitect.com

PROJECT:

3 WOODBINE ROAD IRVINGTON, NY 10533

DRAWING TITLE:
ELEVATIONS - FRONT - NORTH

FILE NAME:

DRAWN BY: PA

SCALE: 3/16" = 1'-0"

DATE: 7/14/23

PROJECT ID: 2214A


A-107.00




1 EXISTING EAST EXTERIOR ELEVATION "REAR"
Scale: 3/16" = 1'-0"



3 EXISTING SOUTH EXTERIOR ELEVATION "SIDE"
Scale: 3/16" = 1'-0"

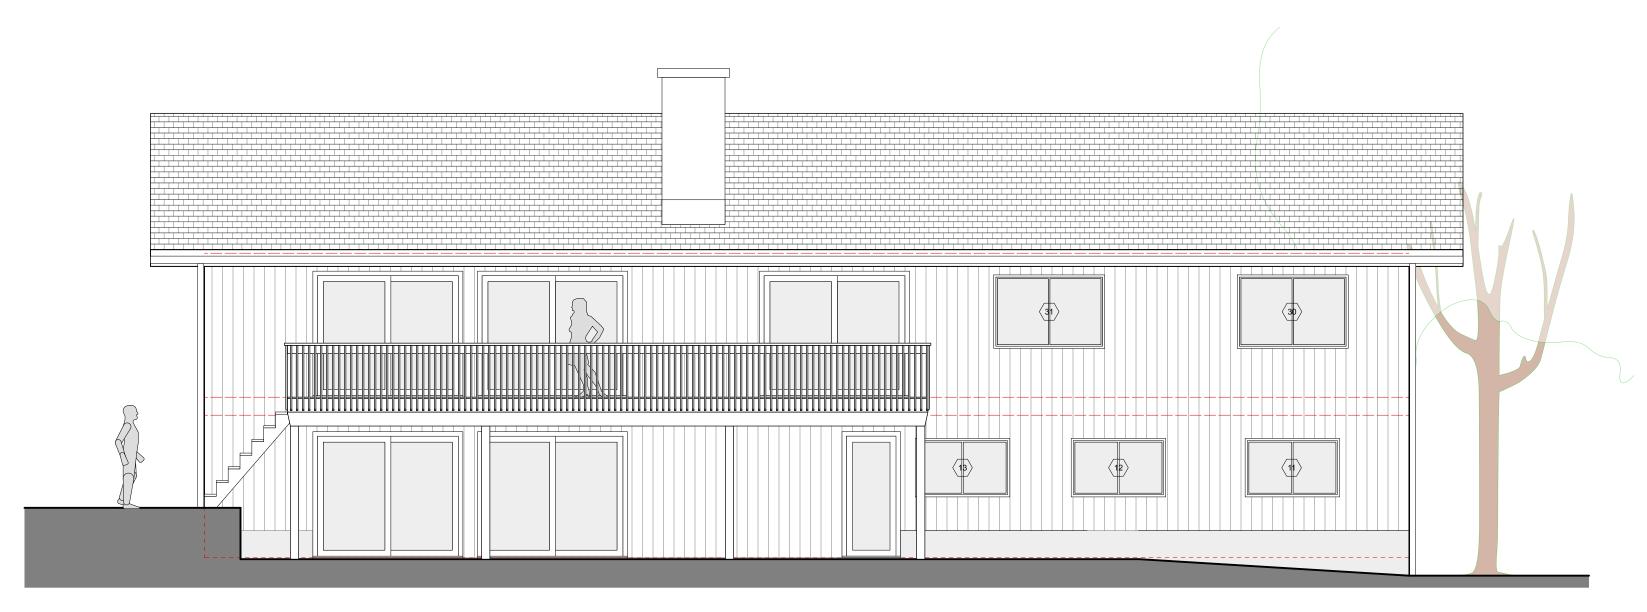


PROPOSED EAST EXTERIOR ELEVATION "REAR"
Scale: 3/16" = 1'-0"

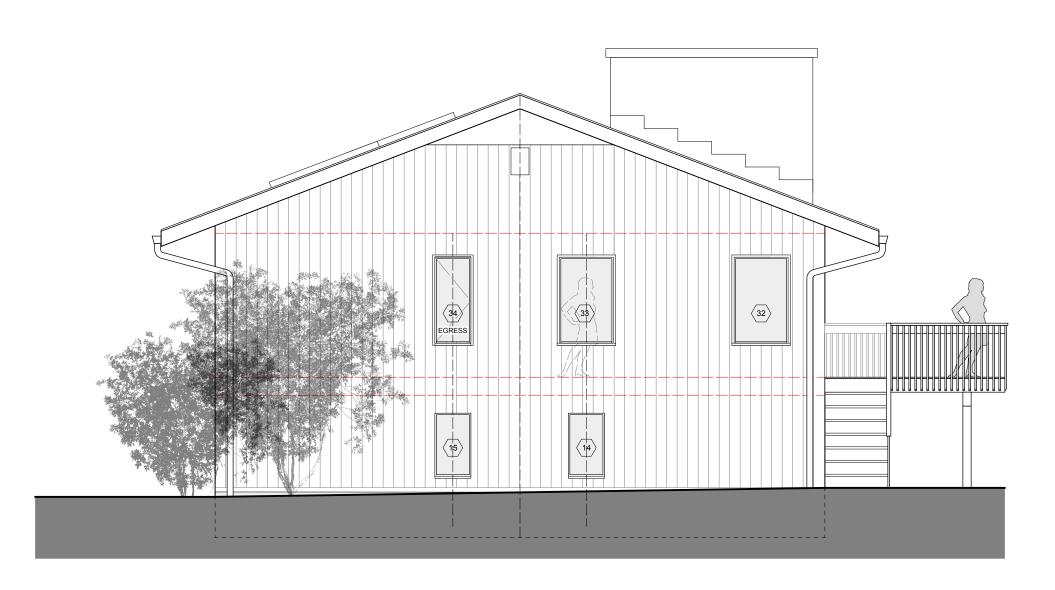

PROPOSED SOUTH EXTERIOR ELEVATION "SIDE"

Scale: 3/16" = 1'-0"

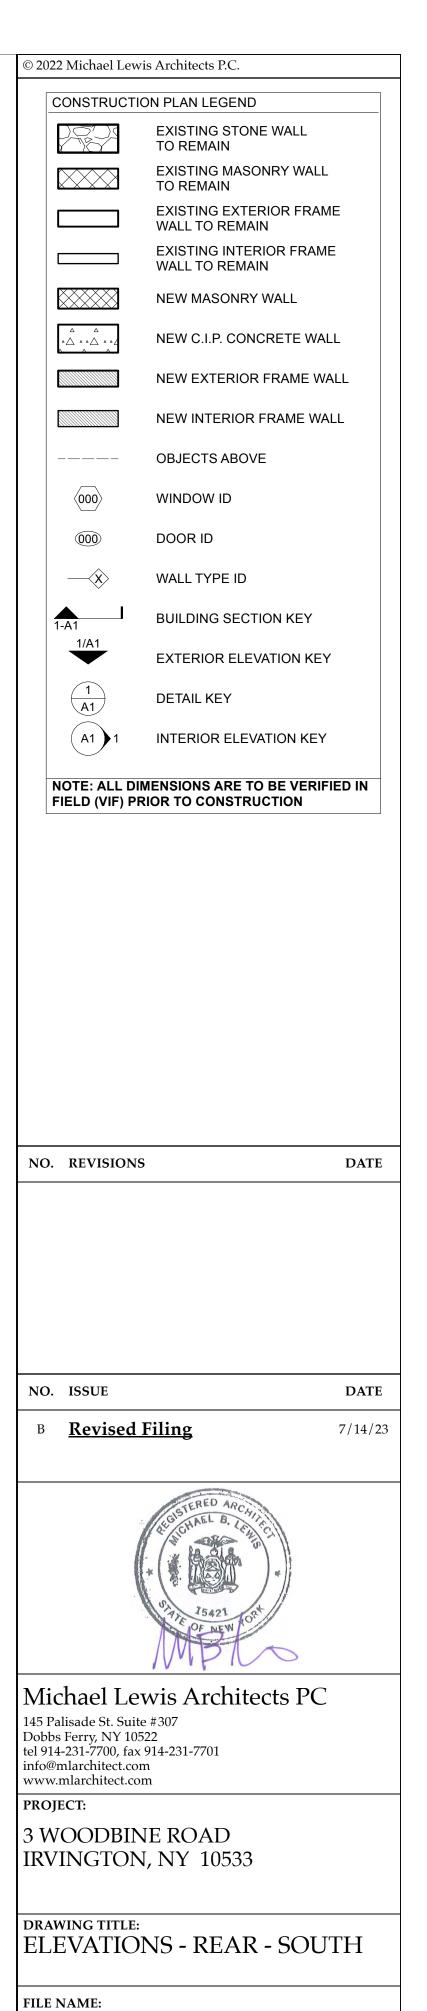

DRAWING NUMBER

DRAWN BY:

PROJECT ID:

3/16" = 1'-0"

7/14/23

2214A

SCALE:

DATE: