#### Padriac Steinschneider

**GOTHAM** 

Gotham Design & Community Development Ltd.
329 Broadway
Dobbs Ferry, New York 10522

(914) 693-5093 **Fax**: (914) 693-5390 Cell (914) 906-4802 **arch329@gmail.com** 

July 6, 2021

IPB No. 2020-6

Irvington Architectural Review Board Main Street Irvington, New York 10533

Single Family Residence Addition and Renovation

2 Heritage Hill Road Charlotte and Daniel Binns

Dear Members of the Architectural Review Board:

Re:

This project was previously approved by the Architectural Review Board July 2021. Since then, the building permit has been issued and the construction has proceeded. This project consists of two primary components. One is an addition to and renovation of an existing single-family home. The other is the construction of a two car garage with a usable space above. This letter is to request your review of changes proposed to the approved garage design.

As approved, the garage was set at a 45 degree orientation to the existing house. This was intended to preserve an existing 30 inch maple tree. Since we initiated construction, we have had the opportunity to better study the conditions of the existing trees and it has been determined that the existing 30 inch maple tree is in serious decline. We learned this when we brought in landscaping consultants with the interest of fortifying that tree to gain better health. The diagnosis is that the tree cannot be saved.

At the same time that we were learning the true condition of this tree, we did exploratory excavation to determine the extent of rock ledge in the area of the proposed garage. The previously designed garage is located where the rock ledge is close to the surface. We will need to hammer out an average depth of five feet of rock over an area of approximately 700 square feet. This is approximately 130 cubic yards of rock. The Village has specific rules and regulations for rock removal that encourage the reduction of rock removal where practical.

We have done exploratory excavation in the area to the south of the location of the approved garage. All indicators are that the rock ledge drops quickly in that area and that a shift of the garage approximately 20 feet further from the house, with a rotation of the garage to be orthogonal to the existing house would significantly reduce the amount of rock that needs to be removed. The elevation, size, and height of the garage would remain the same and the driveway in its current orientation serves this garage location equally well. We anticipate the amount of rock that would need to be removed in the new location would be closer to 55 cubic yards and maybe even less.

The reason that I mentioned the 30 inch maple was that saving this tree was the reason for the location closer to the house that was approved. If the tree needs to be removed for safety reasons anyway, we would like to shift the garage to reduce the amount of rock removal. A significant number of new trees approved by the Tree Commission have already been planted on the site and there are more planned.

We have also proposed making a series of what we are thinking will be small changes to the actual design, including the following:

Letter to the Irvington Architectural Review Board Re: Binns Residence - 2 Heritage Hill

July 6, 2021 Page two of two.

1. A shed dormer is proposed to be added to the roof facing south. This increases the usable space in the attic of the garage to make it more functional. Instead of skylights, we are proposing windows that provide views in this dormer.

- 2. The windows have been changed from the casements that echo the windows in the proposed tower to being double hung units that are more consistent with the windows in the original house.
- 3. The roof facing south has been extended to soften the appearance of the garage doors and large brackets have been added to support this roof extension, which we think adds character to the building.
- 4. A small gabled roof has been added to the north side of the house to bring attention to the entry to the space above the parking level in the garage.

The intention of the attic above the parking level is to provide a garden shed that is more than a repository for tools. The site coverage of the garage and the height is the same as the approved.


The following documents have been submitted for your review. All have been prepared by Gotham Design and Community Development Ltd., under the direction and supervision of Laura Wakefield, R.A.

- A. A set of three sheets of drawings including A-1.1 "Site Plan", A-1.2 "Zoning Table", and A-3.3 "Proposed Garage Plan and Elevations," dated as revised through **07-06-2021**. This set shows the projects revised design for the garage and its siting on the property.
- B. A set of three sheets of drawings including A-1.1 "Site Plan", A-1.2 "Zoning Table", and A-3.3 "Proposed Garage Plan and Elevations," dated as revised through **12-24-2020**. These sheets are from the set of drawings for which the building permit was issued. These sheets have been provided so that the proposed changes can be understood.

We look forward to reviewing this design with you at your next available Architectural Review Board meeting.

Thank you for your time and attention,

Paddy Steinschneider As Agent for Charlotte and Daniel Binns, Owner

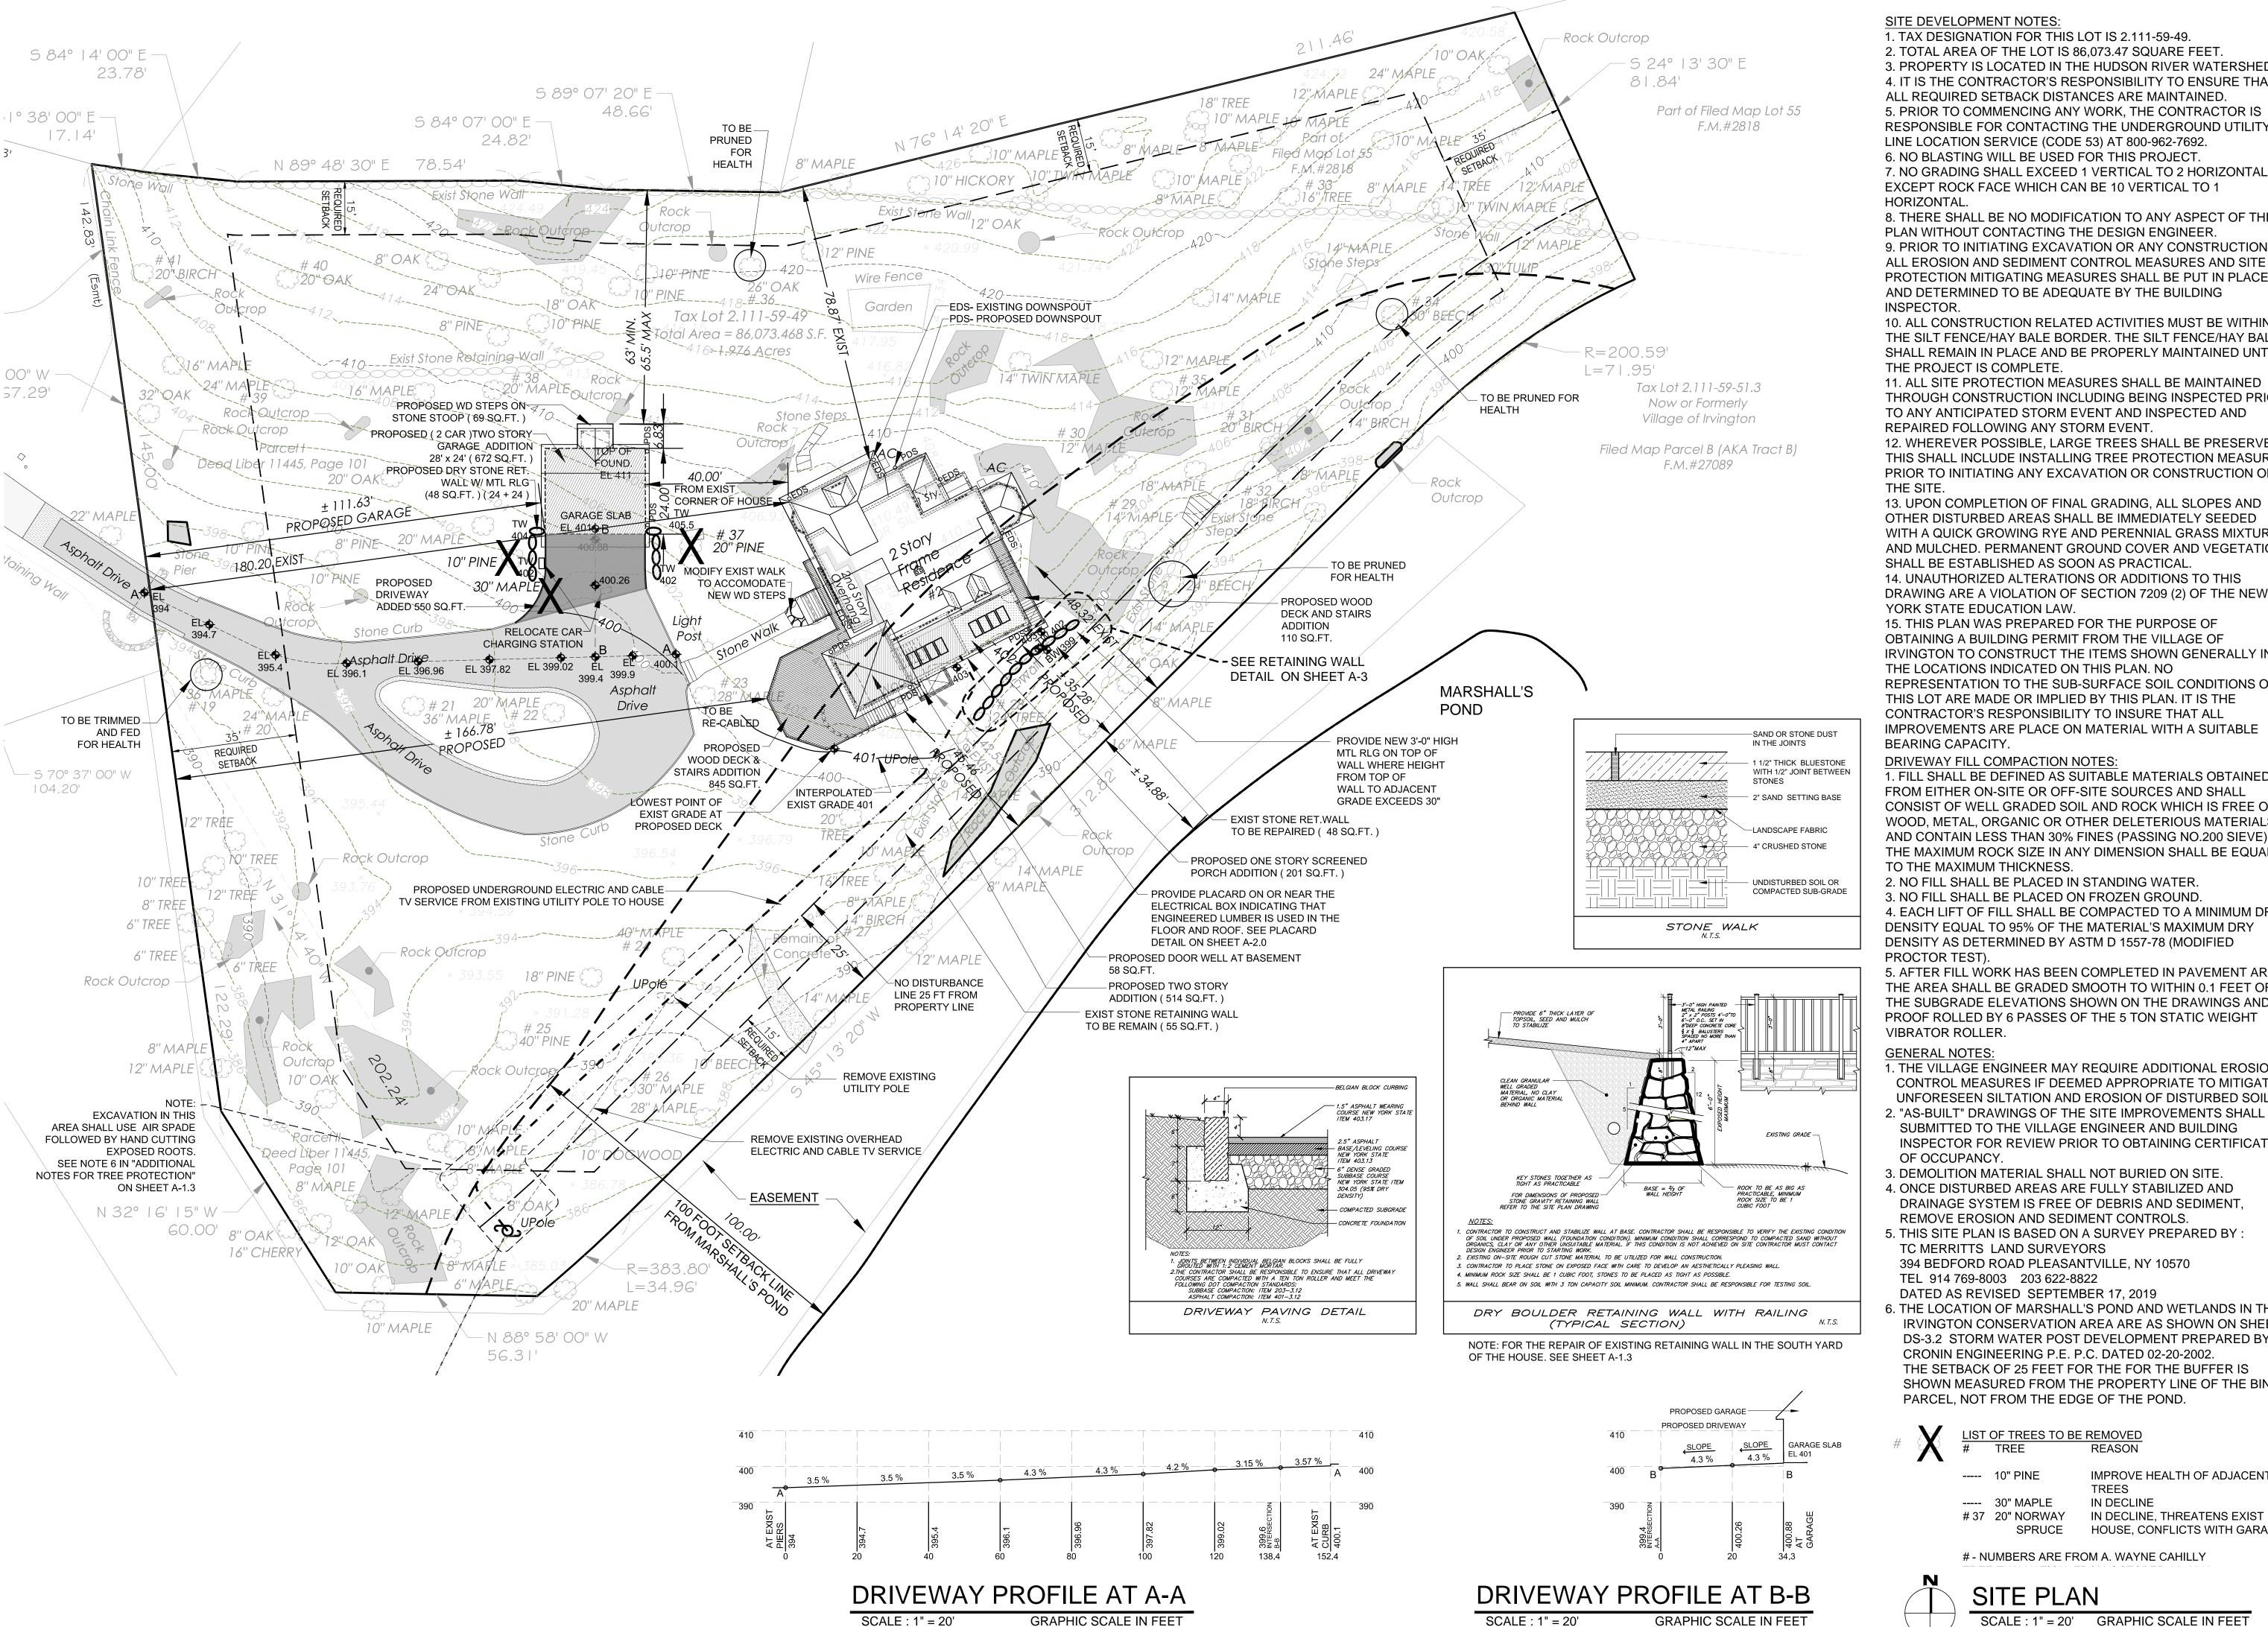

0 5 10 20

SITE DEVELOPMENT NOTES:

I. TAX DESIGNATION FOR THIS LOT IS 2.111-59-49. 2. TOTAL AREA OF THE LOT IS 86,073.47 SQUARE FEET 3. PROPERTY IS LOCATED IN THE HUDSON RIVER WATERSHED 4. IT IS THE CONTRACTOR'S RESPONSIBILITY TO ENSURE THAT ALL REQUIRED SETBACK DISTANCES ARE MAINTAINED 5. PRIOR TO COMMENCING ANY WORK, THE CONTRACTOR IS RESPONSIBLE FOR CONTACTING THE UNDERGROUND UTILITY LINE LOCATION SERVICE (CODE 53) AT 800-962-7692

6. NO BLASTING WILL BE USED FOR THIS PROJECT. 7. NO GRADING SHALL EXCEED 1 VERTICAL TO 2 HORIZONTAL, EXCEPT ROCK FACE WHICH CAN BE 10 VERTICAL TO 1 HORIZONTAL

8. THERE SHALL BE NO MODIFICATION TO ANY ASPECT OF THIS PLAN WITHOUT CONTACTING THE DESIGN ENGINEER 9. PRIOR TO INITIATING EXCAVATION OR ANY CONSTRUCTION, ALL EROSION AND SEDIMENT CONTROL MEASURES AND SITE PROTECTION MITIGATING MEASURES SHALL BE PUT IN PLACE AND DETERMINED TO BE ADEQUATE BY THE BUILDING INSPECTOR.

10. ALL CONSTRUCTION RELATED ACTIVITIES MUST BE WITHIN THE SILT FENCE/HAY BALE BORDER. THE SILT FENCE/HAY BALES SHALL REMAIN IN PLACE AND BE PROPERLY MAINTAINED UNTIL THE PROJECT IS COMPLETE

11. ALL SITE PROTECTION MEASURES SHALL BE MAINTAINED THROUGH CONSTRUCTION INCLUDING BEING INSPECTED PRIOR TO ANY ANTICIPATED STORM EVENT AND INSPECTED AND REPAIRED FOLLOWING ANY STORM EVENT

12. WHEREVER POSSIBLE, LARGE TREES SHALL BE PRESERVED. THIS SHALL INCLUDE INSTALLING TREE PROTECTION MEASURES PRIOR TO INITIATING ANY EXCAVATION OR CONSTRUCTION ON

13. UPON COMPLETION OF FINAL GRADING, ALL SLOPES AND OTHER DISTURBED AREAS SHALL BE IMMEDIATELY SEEDED WITH A QUICK GROWING RYE AND PERENNIAL GRASS MIXTURE AND MULCHED. PERMANENT GROUND COVER AND VEGETATION SHALL BE ESTABLISHED AS SOON AS PRACTICAL 14. UNAUTHORIZED ALTERATIONS OR ADDITIONS TO THIS

YORK STATE EDUCATION LAW. 15. THIS PLAN WAS PREPARED FOR THE PURPOSE OF OBTAINING A BUILDING PERMIT FROM THE VILLAGE OF IRVINGTON TO CONSTRUCT THE ITEMS SHOWN GENERALLY IN THE LOCATIONS INDICATED ON THIS PLAN. NO REPRESENTATION TO THE SUB-SURFACE SOIL CONDITIONS ON THIS LOT ARE MADE OR IMPLIED BY THIS PLAN. IT IS THE CONTRACTOR'S RESPONSIBILITY TO INSURE THAT ALL

DRIVEWAY FILL COMPACTION NOTES

1. FILL SHALL BE DEFINED AS SUITABLE MATERIALS OBTAINED FROM EITHER ON-SITE OR OFF-SITE SOURCES AND SHALL CONSIST OF WELL GRADED SOIL AND ROCK WHICH IS FREE OF WOOD, METAL, ORGANIC OR OTHER DELETERIOUS MATERIALS AND CONTAIN LESS THAN 30% FINES (PASSING NO.200 SIEVE). THE MAXIMUM ROCK SIZE IN ANY DIMENSION SHALL BE EQUAL TO THE MAXIMUM THICKNESS.

2. NO FILL SHALL BE PLACED IN STANDING WATER. 3. NO FILL SHALL BE PLACED ON FROZEN GROUND. 4. EACH LIFT OF FILL SHALL BE COMPACTED TO A MINIMUM DRY DENSITY EQUAL TO 95% OF THE MATERIAL'S MAXIMUM DRY DENSITY AS DETERMINED BY ASTM D 1557-78 (MODIFIED

5. AFTER FILL WORK HAS BEEN COMPLETED IN PAVEMENT AREA THE AREA SHALL BE GRADED SMOOTH TO WITHIN 0.1 FEET OF THE SUBGRADE ELEVATIONS SHOWN ON THE DRAWINGS AND PROOF ROLLED BY 6 PASSES OF THE 5 TON STATIC WEIGHT VIBRATOR ROLLER.

GENERAL NOTES:

I. THE VILLAGE ENGINEER MAY REQUIRE ADDITIONAL EROSION CONTROL MEASURES IF DEEMED APPROPRIATE TO MITIGATE UNFORESEEN SILTATION AND EROSION OF DISTURBED SOILS. 2. "AS-BUILT" DRAWINGS OF THE SITE IMPROVEMENTS SHALL BE

SUBMITTED TO THE VILLAGE ENGINEER AND BUILDING INSPECTOR FOR REVIEW PRIOR TO OBTAINING CERTIFICATE OF OCCUPANCY.

3. DEMOLITION MATERIAL SHALL NOT BURIED ON SITE.

4. ONCE DISTURBED AREAS ARE FULLY STABILIZED AND DRAINAGE SYSTEM IS FREE OF DEBRIS AND SEDIMENT. REMOVE EROSION AND SEDIMENT CONTROLS. 5. THIS SITE PLAN IS BASED ON A SURVEY PREPARED BY

TC MERRITTS LAND SURVEYORS 394 BEDFORD ROAD PLEASANTVILLE, NY 10570 TEL 914 769-8003 203 622-8822 DATED AS REVISED SEPTEMBER 17, 2019


6. THE LOCATION OF MARSHALL'S POND AND WETLANDS IN THE IRVINGTON CONSERVATION AREA ARE AS SHOWN ON SHEET DS-3.2 STORM WATER POST DEVELOPMENT PREPARED BY CRONIN ENGINEERING P.E. P.C. DATED 02-20-2002. THE SETBACK OF 25 FEET FOR THE FOR THE BUFFER IS

SHOWN MEASURED FROM THE PROPERTY LINE OF THE BINN PARCEL, NOT FROM THE EDGE OF THE POND.

IMPROVE HEALTH OF ADJACENT ----- 10" PINE TREES ---- 30" MAPLE IN DECLINE

# 37 20" NORWAY IN DECLINE, THREATENS EXIST HOUSE, CONFLICTS WITH GARAGE

# - NUMBERS ARE FROM A. WAYNE CAHILLY

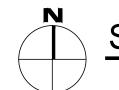


0 5 10 20

SITE PLAN SCALE : 1" = 20'

GRAPHIC SCALE IN FEET 0 5 10 20

TO THE BEST OF MY KNOWLEDGE, BELIEF, AND PROFESSIONAL JUDGEMENT OF THE UNDERSIGNED THE PLANS AND SPECIFICATIONS DEPICTED ON THESE DRAWINGS ARE IN COMPLIANCE WITH THE APPLICABLE PROVISION OF THE NEW YORK STATE UNIFORM FIRE PREVENTION AND BUILDING CODE AND THE NEW YORK STATE ENERGY CONSERVATION CONSTRUCTION

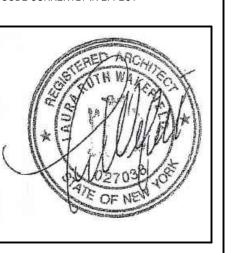

LAURA WAKEFIELD ARCHITECT 329 BROADWAY DOBBS FERRY, NY 10522 TEL: 914 693 6165 N.Y.S STATE LICENSE

No. 27038

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S

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AND COMMUNITY DEVELOPMENT LTD.

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Phone: (914) 693-5093 Fax: (914)693-5390 email: arch329@gmail.com

ISSUED FOR / REVISIONS: **REVISED** 02-19-2020 REVISED 02-28-2020 GRADING BETWEEN PROPOSED TERRACE AND PROPERTY LINE ( ELIMINATED RET'G WALL ) PROPOSED GARAGE LOCATION AND DRIVEWAY ADDED DRIVEWAY PROFILE REVISED

PROPOSED GARAGE LOCATION PROPOSED DRIVEWAY GRADING DRIVEWAY PROFILE PROPOSED STONE WALK PROPOSED DECK + STAIRS PROPOSED GRADING AT SOUTH SIDE OF HOUSE ELIMINATED PROP. TERRACE

ADDED EXIST UTILITIES ADDED STONE WALK DETAIL ADDED MARSHALLS POND LINE REVISED 04-21-2020

DRIVEWAY AND PROFILES ADDED 100 FT SETBACK LINE FROM MARSHALL'S POND REVISED 05-20-2020

ADDED NOTES REVISED 12-24-2020 **ELIMINATED 1 STORY ADDITION** ADDED LOCATION OF PLACARD ( ENGINEERED WOOD ) NOTE REVISED 07-06-2021 RELOCATED PROPOSED GARAGE

30" MAPLE TREE IN DECLINE TO BE REMOVED

SHEET TITLE: SITE PLAN

DRAWN BY: 01-22-2020 MB CHECKED BY: AS NOTED | PRS

#### **VOLUME CHART**


|              | EXISTING       |        | PROPOSED       |        |
|--------------|----------------|--------|----------------|--------|
| SPACE        | SQUARE FOOTAGE | VOLUME | SQUARE FOOTAGE | VOLUME |
| BASEMENT     | 1,927          | 12,610 | 442            | 3,978  |
| FIRST FLOOR  | 1,970          | 20,095 | 573            | 5,845  |
| SECOND FLOOR | 1,575          | 14,346 | 393            | 4,444  |
| ATTIC        |                | 3,938  |                | 370    |
| TOTAL        | 5,899          | 50,589 | 1,408          | 14,637 |
|              |                |        |                |        |

14,637 / 50,589 = 28.93%

**FIRST & SECOND** FLOOR ONLY 10,289 10,289 / 34,441 = 29.87%

**VOLUME CHART NOTES** 

- 1. THE VOLUME OF THE BASEMENT SPACE HAS BEEN CALCULATED AS THE AREA FOR EACH SPACE WITHIN THE PERIMETER OF THE FOUNDATION BELOW HABITABLE AREA MULTIPLIED BY THE HEIGHT OF THAT SPACE FROM
- TOP OF SLAB TO TOP OF THE FLOOR STRUCTURE ABOVE 2. THE VOLUME OF THE FIRST AND SECOND FLOOR SPACE HAS BEEN CALCULATED AS THE AREA OF EACH SPACE OF HABITABLE AREA WITHIN THE PERIMETER OF THE EXTERIOR SHEATHING MULTIPLIED BY THE HEIGHT OF THAT
- SPACE FROM THE TOP OF FLOOR TO THE TOP OF STRUCTURE ABOVE, WHETHER FLOOR OR CEILING 3. THE VOLUME OF THE ATTIC HAS BEEN CALCULATED BY MULTIPLYING THE LENGTH, WIDTH AND HEIGHT OF THE AREAS BETWEEN THE CEILING OR FLOOR OUTSIDE OF THE PERIMETER WALLS AND INSIDE THE ROOF SHEATHING.
- IN THE PROPOSED AREAS THIS CONSISTS OF THE VOLUME OF THE ROOF FRAMING. 4.THE EXISTING FOOTPRINT OF THE HOUSE WILL INCREASE FROM 1,970 SQ.FT. TO 2,543 SQ.FT. AN INCREASE OF 29.1 %.
- THE EXISTING FLOOR AREA IN THE HOUSE WILL INCREASE FROM 3,545 SQ.FT. TO 4,511 SQ.FT, AN INCREASE OF 27.25 %. THE VOLUME OF THE HOUSE WILL INCREASE FROM 50,589 CU. FT. TO 65,226 CU.FT. AN INCREASE OF 28.93 %.

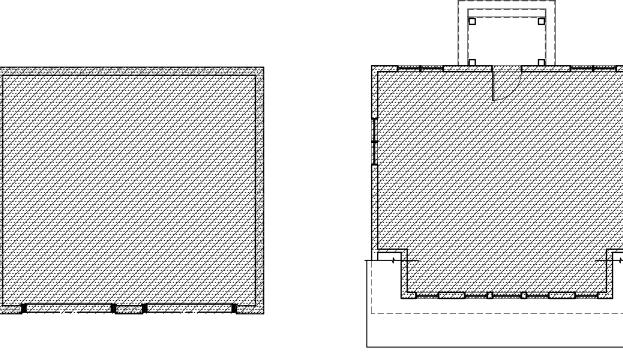


FLOOR AREA 676 SQ.FT.

FLOOR AREA 607 SQ.FT. **EXCLUDED FROM FAR CALCULATION** AS PER SECTION 224-137 D ( 1 )

### PROPOSED GARAGE AND ATTIC PLANS

**GRAPHIC SCALE IN FEET** 

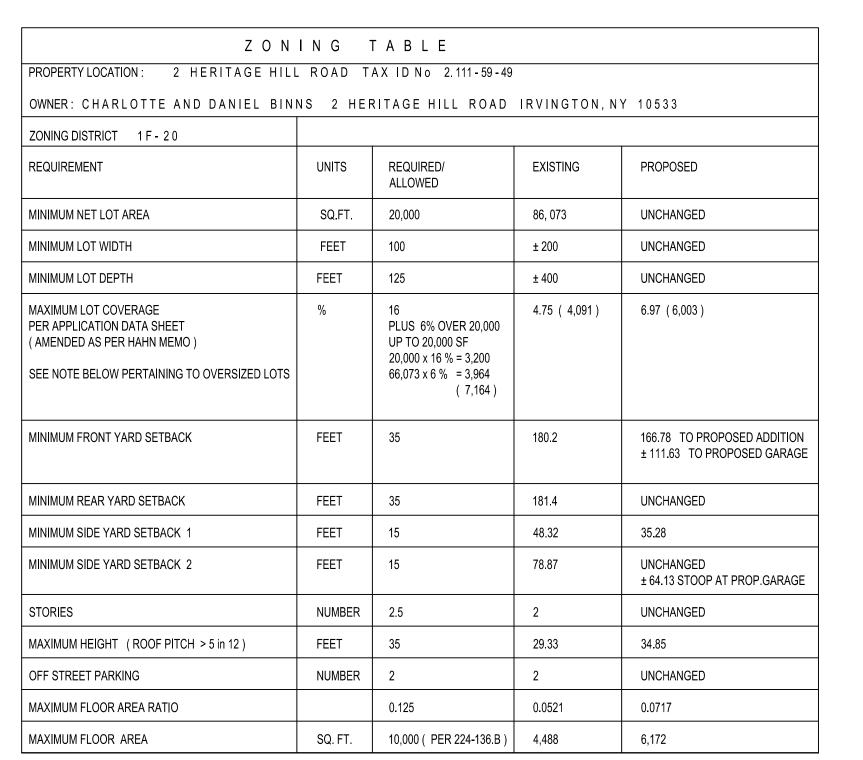

LOT COVERAGE NOTE FOR OVERSIZED LOTS PER SECTION 224-13.B: THE SUM OF ALL AREAS COVERED BY ALL PRINCIPAL AND ACCESSORY BUILDINGS IN LOTS LOCATED IN 1F-5, 1F-10 AND 1F-20 DISTRICTS SHALL NOT EXCEED THAT WHICH WOULD BE PERMISSIBLE IF THE LOT WERE LOCATED IN THE DISTRICT HAVING THE LARGEST MINIMUM LOT SIZE SMALLER THAN THE AREA OF THE LOT. BASED ON THIS SECTION LOT COVERAGE CALCULATES AS FOLLOWS: 6.75% UP TO 80,000 SF PLUS 6% OVER 80,000 ( 80,000 X 6.75% = 5,400 PLUS 6,073 X 6% = 364 5400 + 364 = 5,764 ) NOTE: A VARIANCE HAS BEEN GRANTED BY THE ZONING BOARD OF APPEALS

#### FLOOR AREA RATIO CALCULATIONS

**EXISTING FLOOR AREA** BASMENT FLR 943 SQ.FT. 1,970 SQ.FT. SECOND FLR 1,575 SQ.FT.

**TOTAL** 4,488 SQ.FT.

4,488 / 86,073 = 0.0521 < 0.125

ADDITION-

21 SQ.FT.


PROPOSED FLOOR AREA BASEMENT FLR 1,385 SQ.FT. FIRST FLR 2,543 SQ.FT. SECOND FLR 1,968 SQ.FT.

<sup>∠</sup>ADDITION


352 SQ.FT.

**GARAGE 319 SQ.FT. (719 - 400 GARAGE DEDUCTION** AS PER 224-137 D (1))

6,215 SQ.FT. 6,215 / 86,073 = 0.0722 < 0.125

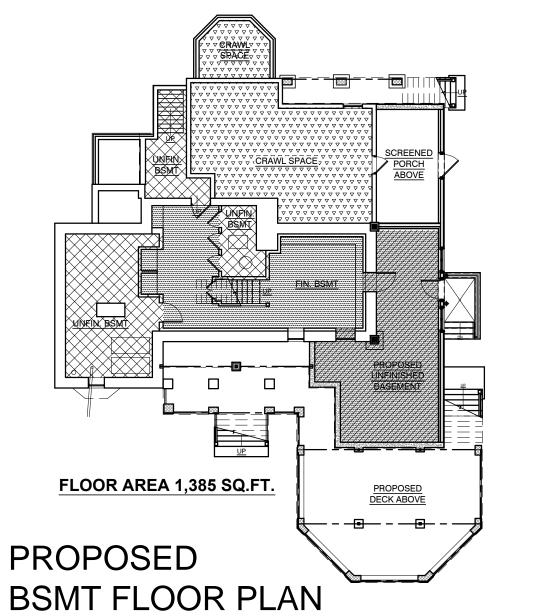


**BSMT FLOOR PLAN** SCALE: 1" = 15' GRAPHIC SCALE IN FEET

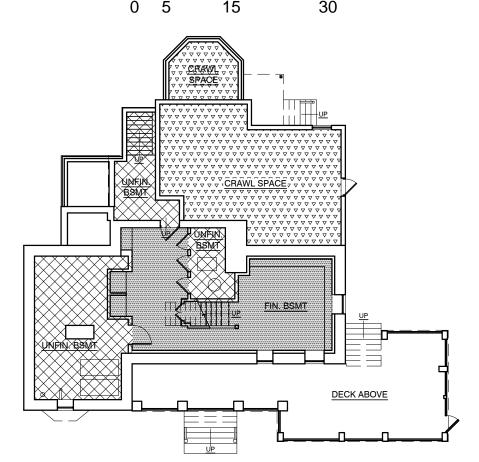


FLOOR AREA 943 SQ.FT.

#### EXIST BSMT FLOOR PLAN

SCALE: 1" = 15' **GRAPHIC SCALE IN FEET** 0 5 15

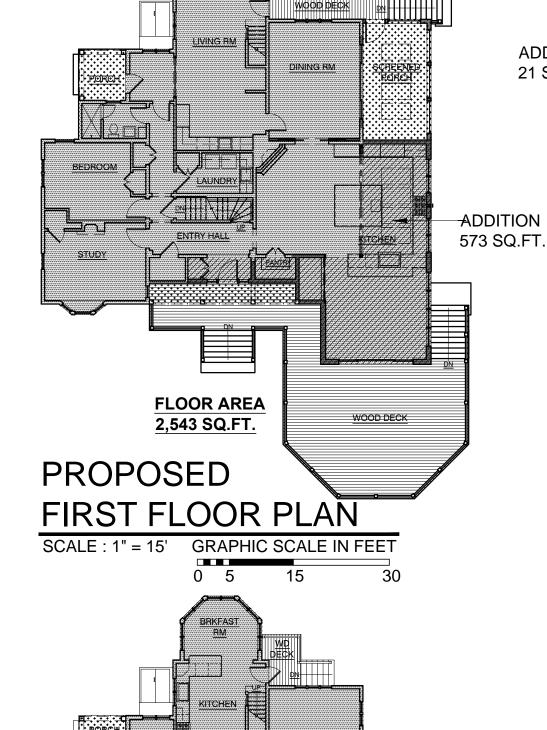


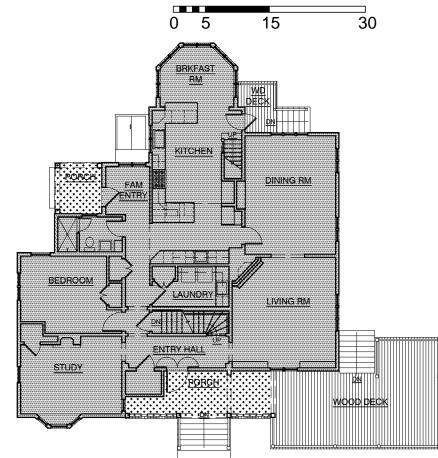

FLOOR AREA 1,970 SQ.FT.

#### EXIST FIRST FLOOR PLAN

SCALE : 1" = 15' **GRAPHIC SCALE IN FEET** 

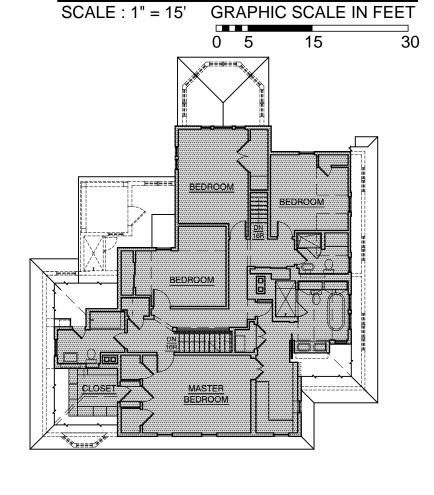

-ADDITION

8 SQ.FT.

SECOND FLOOR PLAN


**FLOOR AREA** 

1,968 SQ.FT.

PROPOSED

LEGEND **EXISTING FLOOR** AREA INCLUDED PROPOSED FLOOR AREA INCLUDED



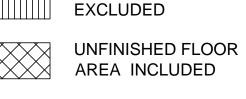


CRAWL SPACE **EXCLUDED** 

FLOOR AREA 1,575 SQ.FT.


SCALE: 1" = 15'

#### EXIST SECOND FLOOR PLAN

**GRAPHIC SCALE IN FEET** 

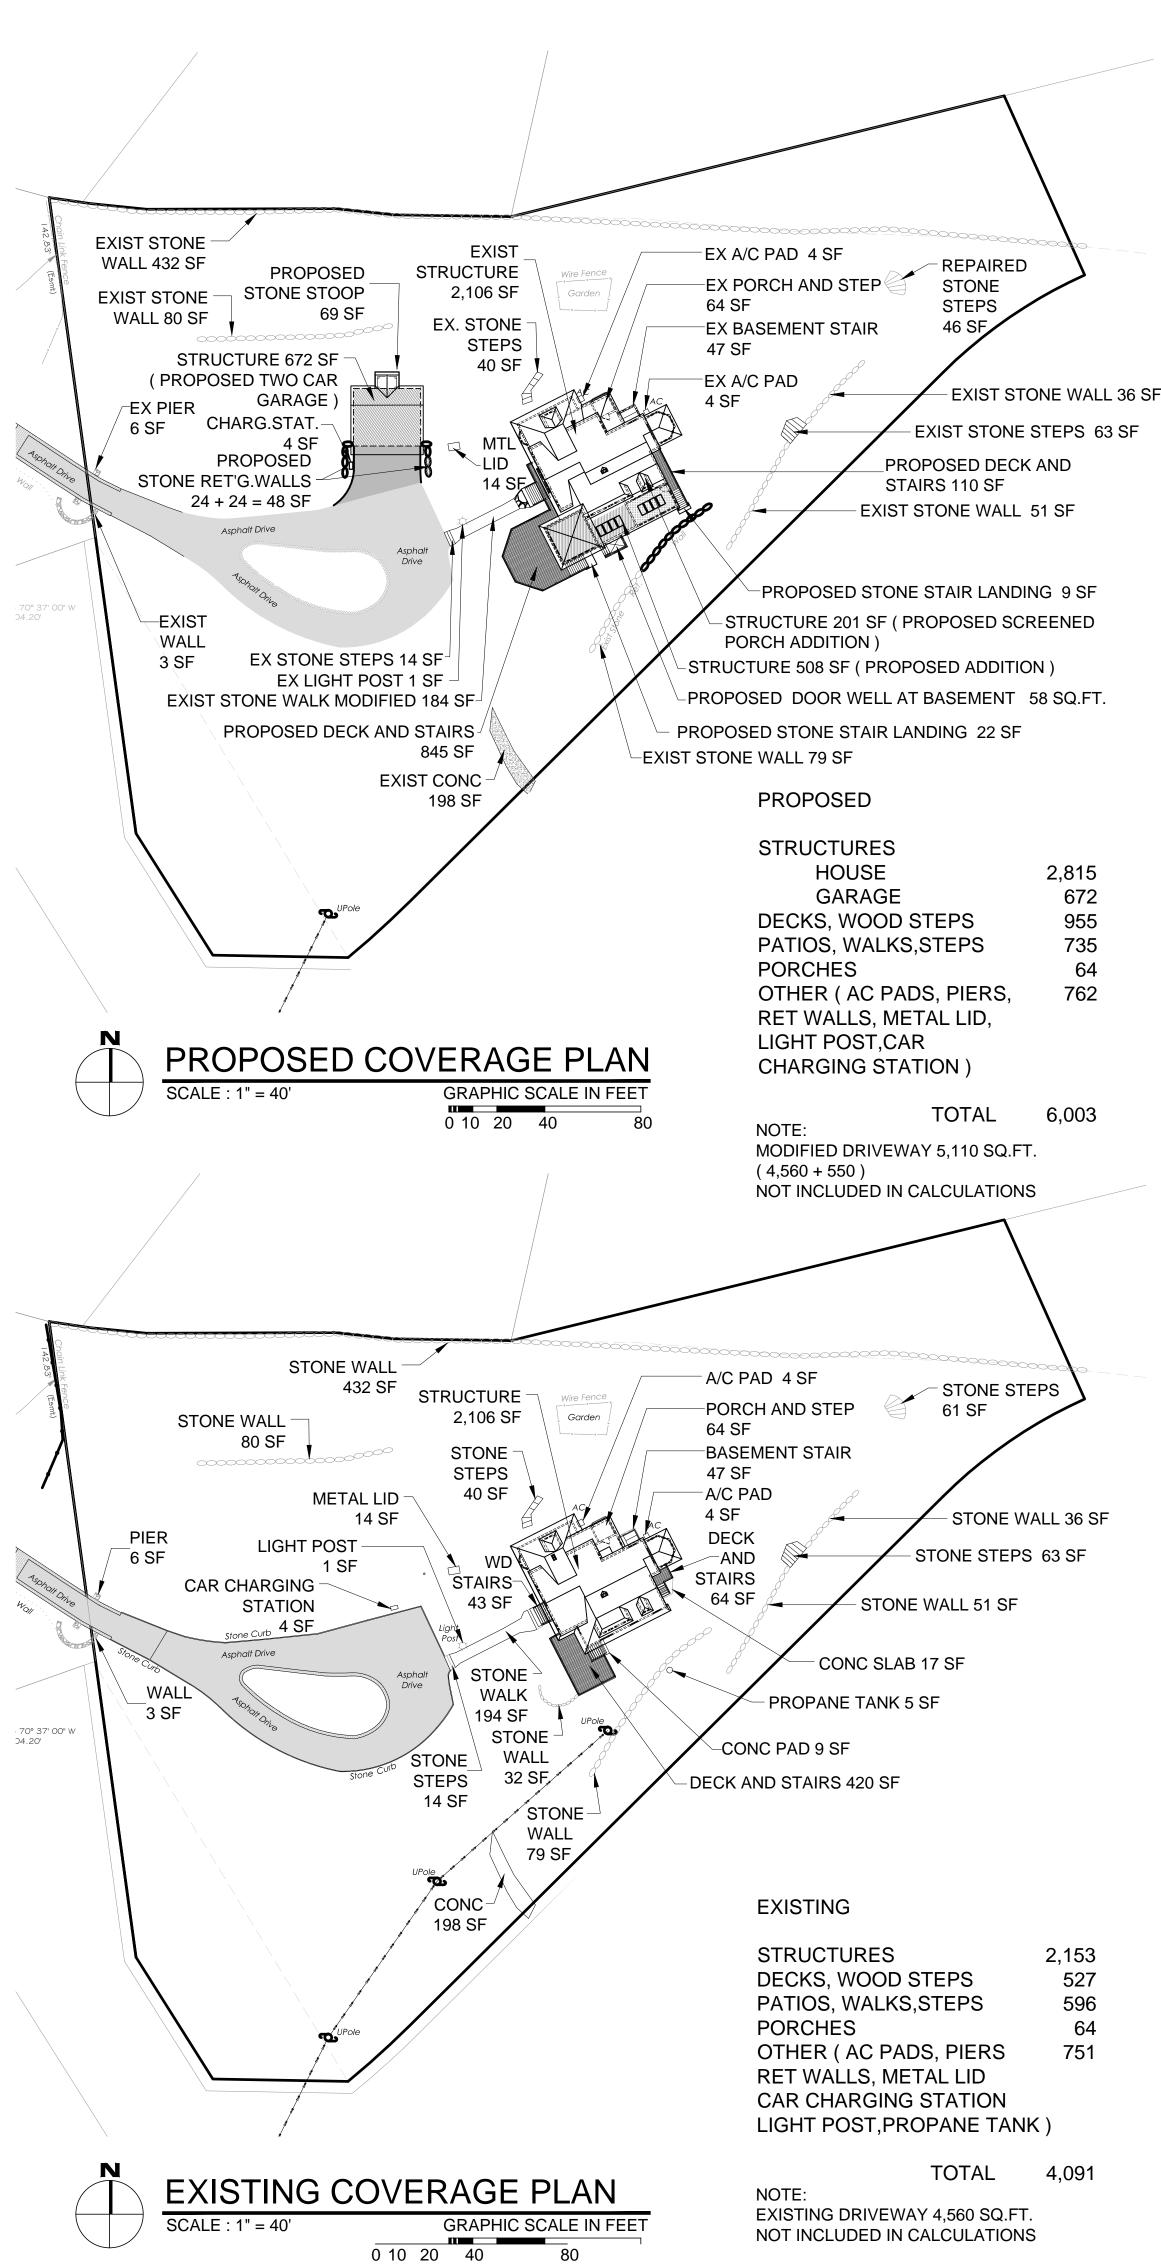

TO THE BEST OF MY KNOWLEDGE, BELIEF, AND PROFESSIONAL JUDGEMENT OF THE LINDERSIGNED THE PLANS AND SPECIFICATIONS DEPICTED ON THESE DRAWINGS ARE IN COMPLIANCE WITH THE APPLICABLE PROVISION OF THE NEW YORK STATE UNIFORM FIRE PREVENTION AND BUILDING CODE AND THE NEW YORK STATE **ENERGY CONSERVATION CONSTRUCTION** CODE CURRENTLY IN EFFECT

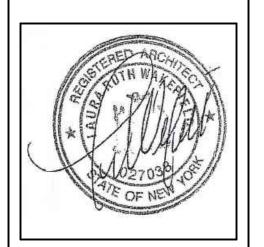

LAURA WAKEFIELD **ARCHITECT** 329 BROADWAY DOBBS FERRY, NY 10522 TEL: 914 693 6165 N.Y.S STATE LICENSE

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BINN

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ISSUED FOR / REVISIONS: REVISED 02-19-2020 REVISED 02-28-2020 ZONING TABLE PROPOSED LOT COVERAGE SETBACKS TO PROP. GARAGE PROPOSED COVERAGE PLAN OTHER - TOTAL ( ELIMINATED RET.G WALL )

REVISED ZONING TABLE PROPOSED COVERAGE PLAN FLOOR AREA RATIO CALC'S ADDED EXISTING & PROPOSED BASEMENT PLANS **ZONING TABLE** 


PROPOSED COVERAGE PLAN FLOOR AREA RATIO CALC'S **ELIMINATED 1 STORY ADDITION** CHANGED ZONING TABLE, PROPOSED LOT COVERAGE & FLOOR AREA RATIO CALC'S ADDED VOLUME CHART & NOTES

REVISED RELOCATED GARAGE REVISED ZONING TABLE AND PROPOSED LOT COVERAGE


**ZONING TABLE** SITE COVERAGE PLANS **FLOOR AREA RATIO CALCULATIONS** 

DRAWN BY: 01-22-2020 MB CHECKED BY

AS NOTED | PRS

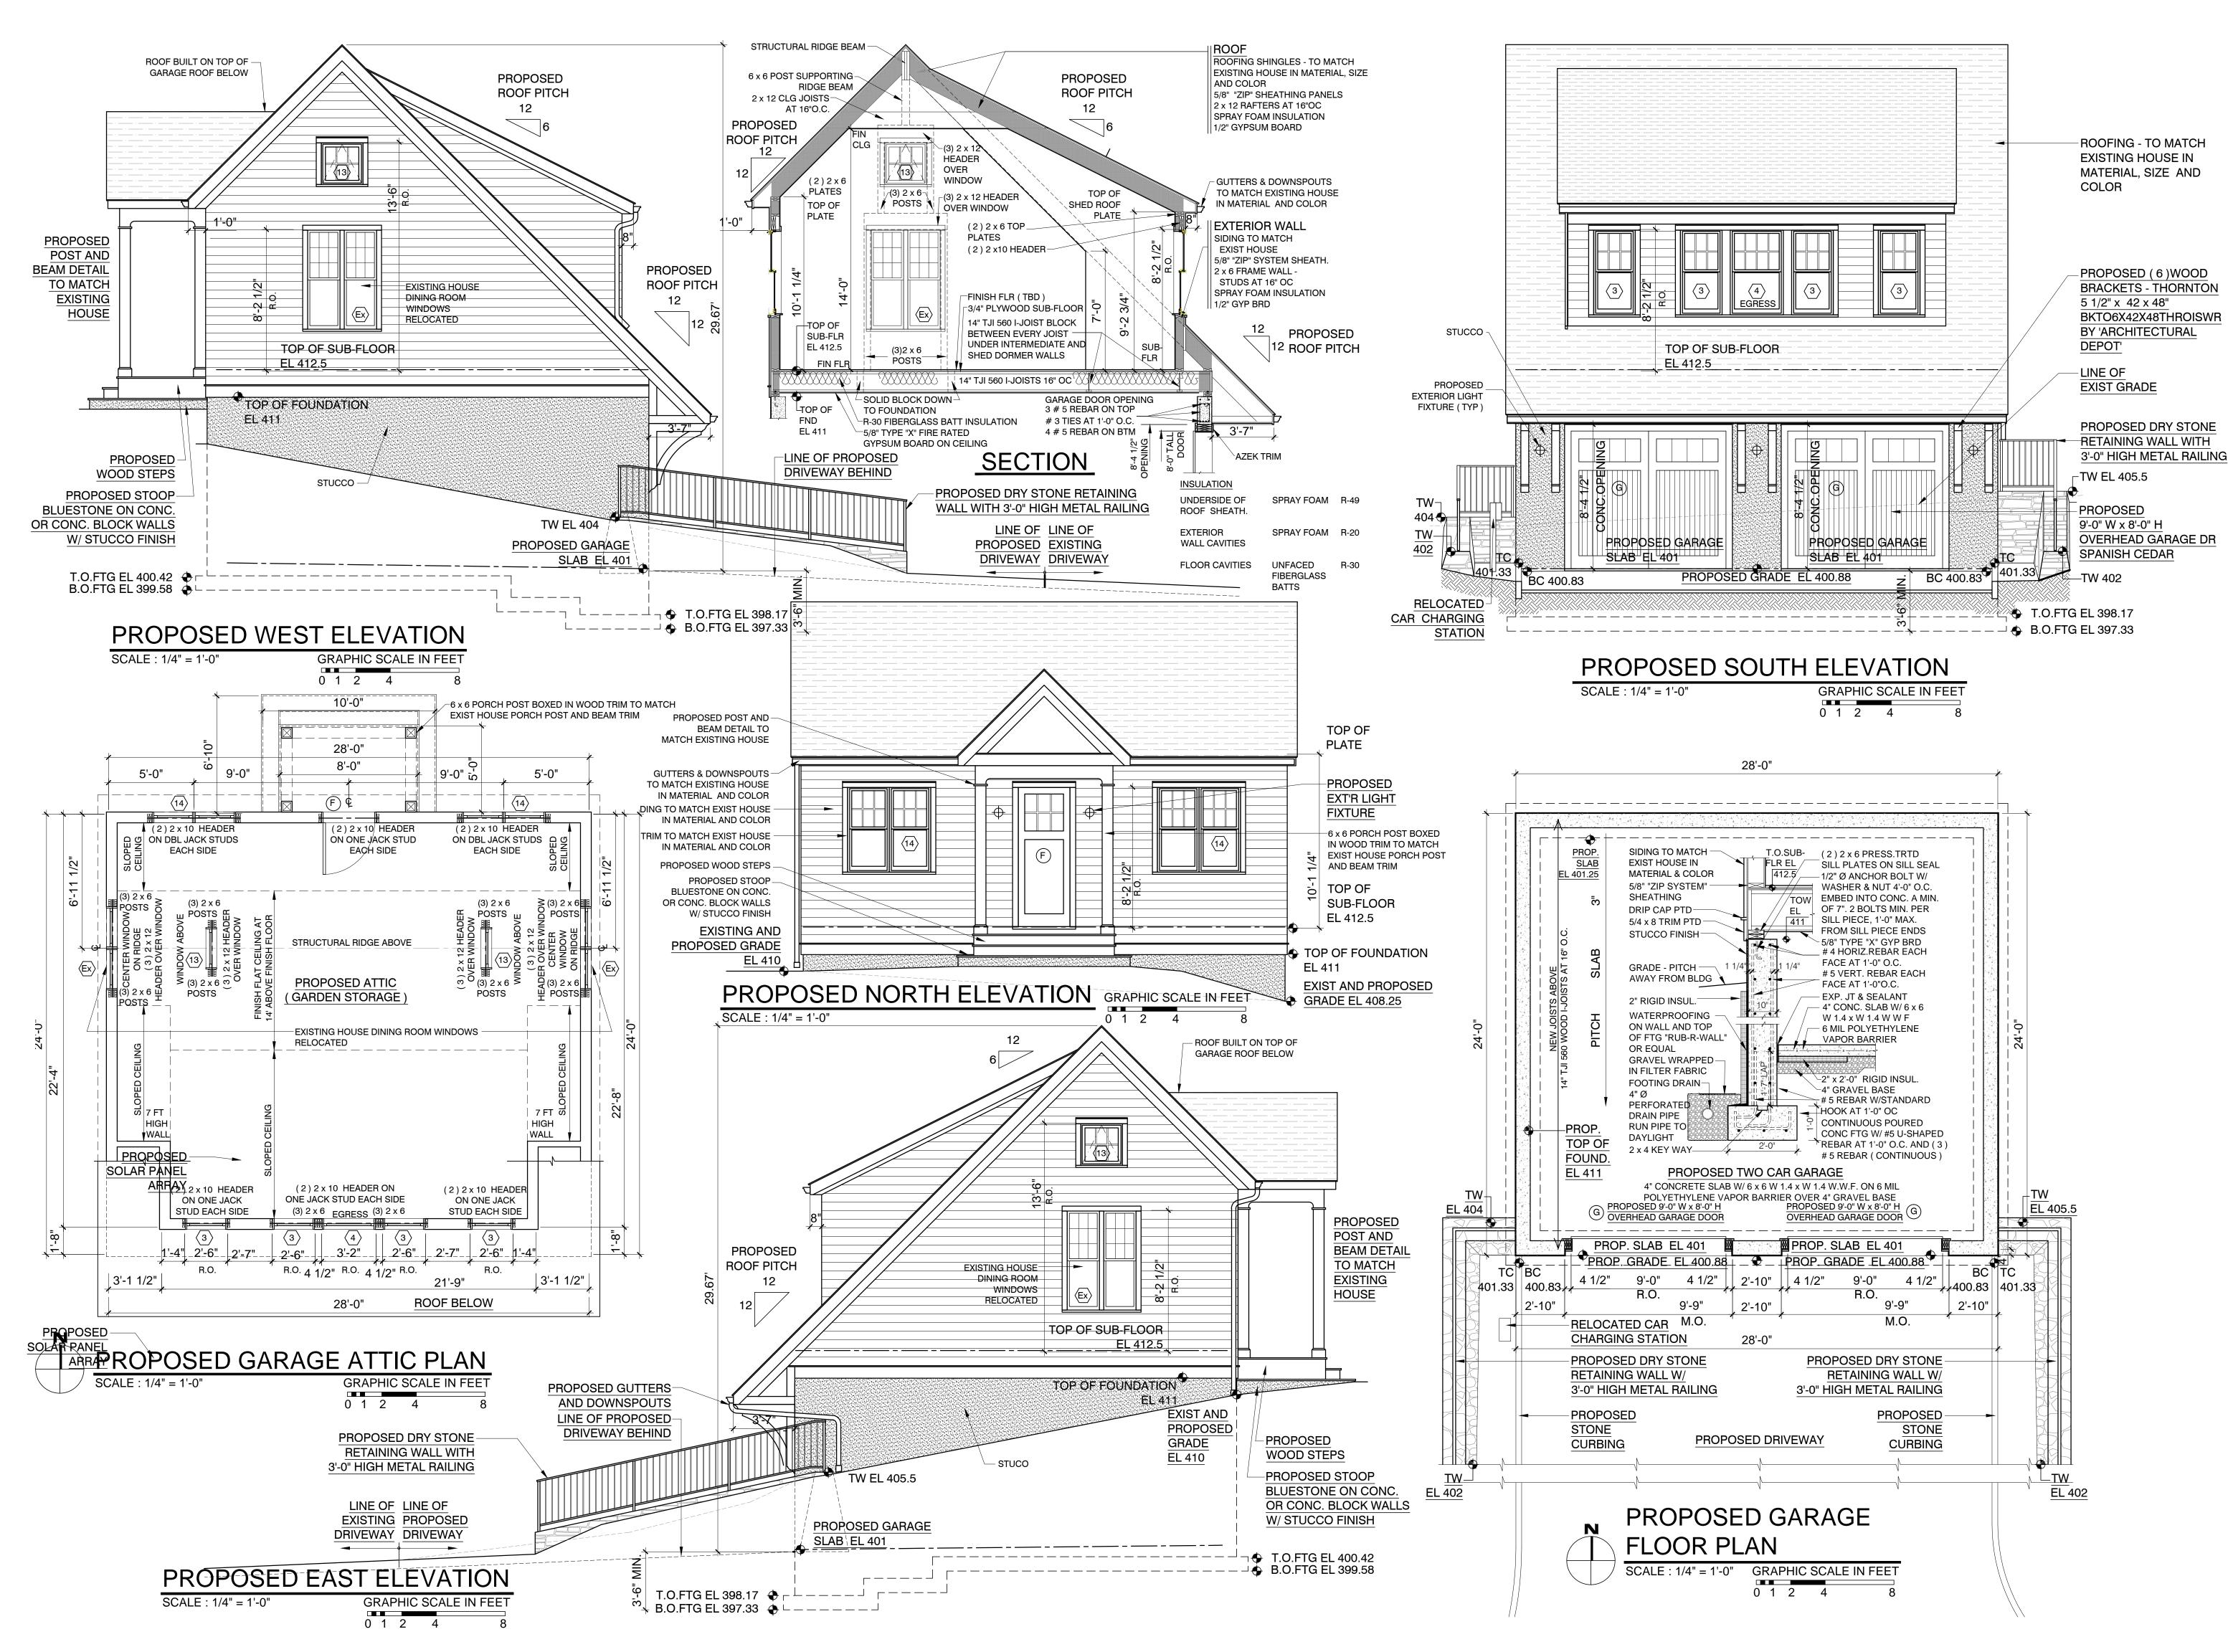

TO THE BEST OF MY KNOWLEDGE, BELIEF, AND PROFESSIONAL JUDGEMENT OF THE UNDERSIGNED, THE PLANS AND SPECIFICATIONS DEPICTED ON THESE DRAWINGS ARE IN COMPLIANCE WITH THE APPLICABLE PROVISION OF THE NEW YORK STATE UNIFORM FIRE PREVENTION AND BUILDING CODE AND THE NEW YORK STATE ENERGY CONSERVATION CONSTRUCTION CODE CURRENTLY IN EFFECT

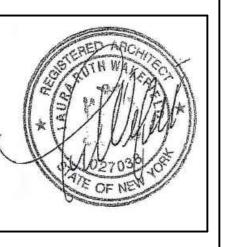

ARCHITECT
329 BROADWAY
DOBBS FERRY, NY 10522

TEL: 914 693 6165

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HARLOTTE AND DANIEL BINNS
HERITAGE HILL ROAD

VINGTON, NEW YORK 10533

## GOTHAM DESIGN

AND COMMUNITY
DEVELOPMENT LTD

329 Broadway
Dobbs Ferry, N.Y. 10522
Phone: ( 914 ) 693-5093
Fax: ( 914 ) 693-5390
email: arch329@gmail.com

REVISED 02-28-2020
GARAGE ELEVATIONS
(GARAGE RELOCATED ON SITE)
REVISED 03-18-2020
PROPOSED GARAGE LOCATION
REVISED GRADING
ADDED METAL RAILINGS
ADDED EXT'R LIGHT FIXTURES
ADDED GUTTERS, DOWNSPOUTS
REVISED 04-21-2020
RAISED PLATE HEIGHT 2 FEET
RAISED WINDOW /DOOR HEIGHT
REVISED 07-06-2020
ADDED DR & WINDOW SYMBOLS
EXTERIOR FINISH LABELS
REVISED 10-15-2020
REVISED 10-15-2020

ISSUED FOR / REVISIONS:


FOUNDATION AND FOOTING
REINFORCEMENT STEEL
STEEL ANGLE LINTEL
REVISED 07-06-202
CHANGED GARAGE WIDTH
FROM 26'-4" TO 28' AND GARAGE
DEPTH FROM 25'-8" TO 24'
CHANGED WINDOWS FROM
CASEMENT TO DOUBLE HUNG
CHANGED FIXED WINDOW IN
GABLES TO OPERABLE AWNING

CASEMENT TO DOUBLE HUNG
CHANGED FIXED WINDOW IN
GABLES TO OPERABLE AWNING
ELIMINATED STONE ON GARAGE
ADDED SHED ROOF DORMER
ADDED ROOF ABOVE BACK STOOF
INCREASED ROOF FRONT OVERHANG & ADDED WOOD BRACKETS

SHEET TITLE:
PROPOSED GARAGE
PLAN AND ELEVATIONS

DATE: DRAWN BY:
01-22-2020 MB

SCALE: CHECKED BY:
AS NOTED PRS

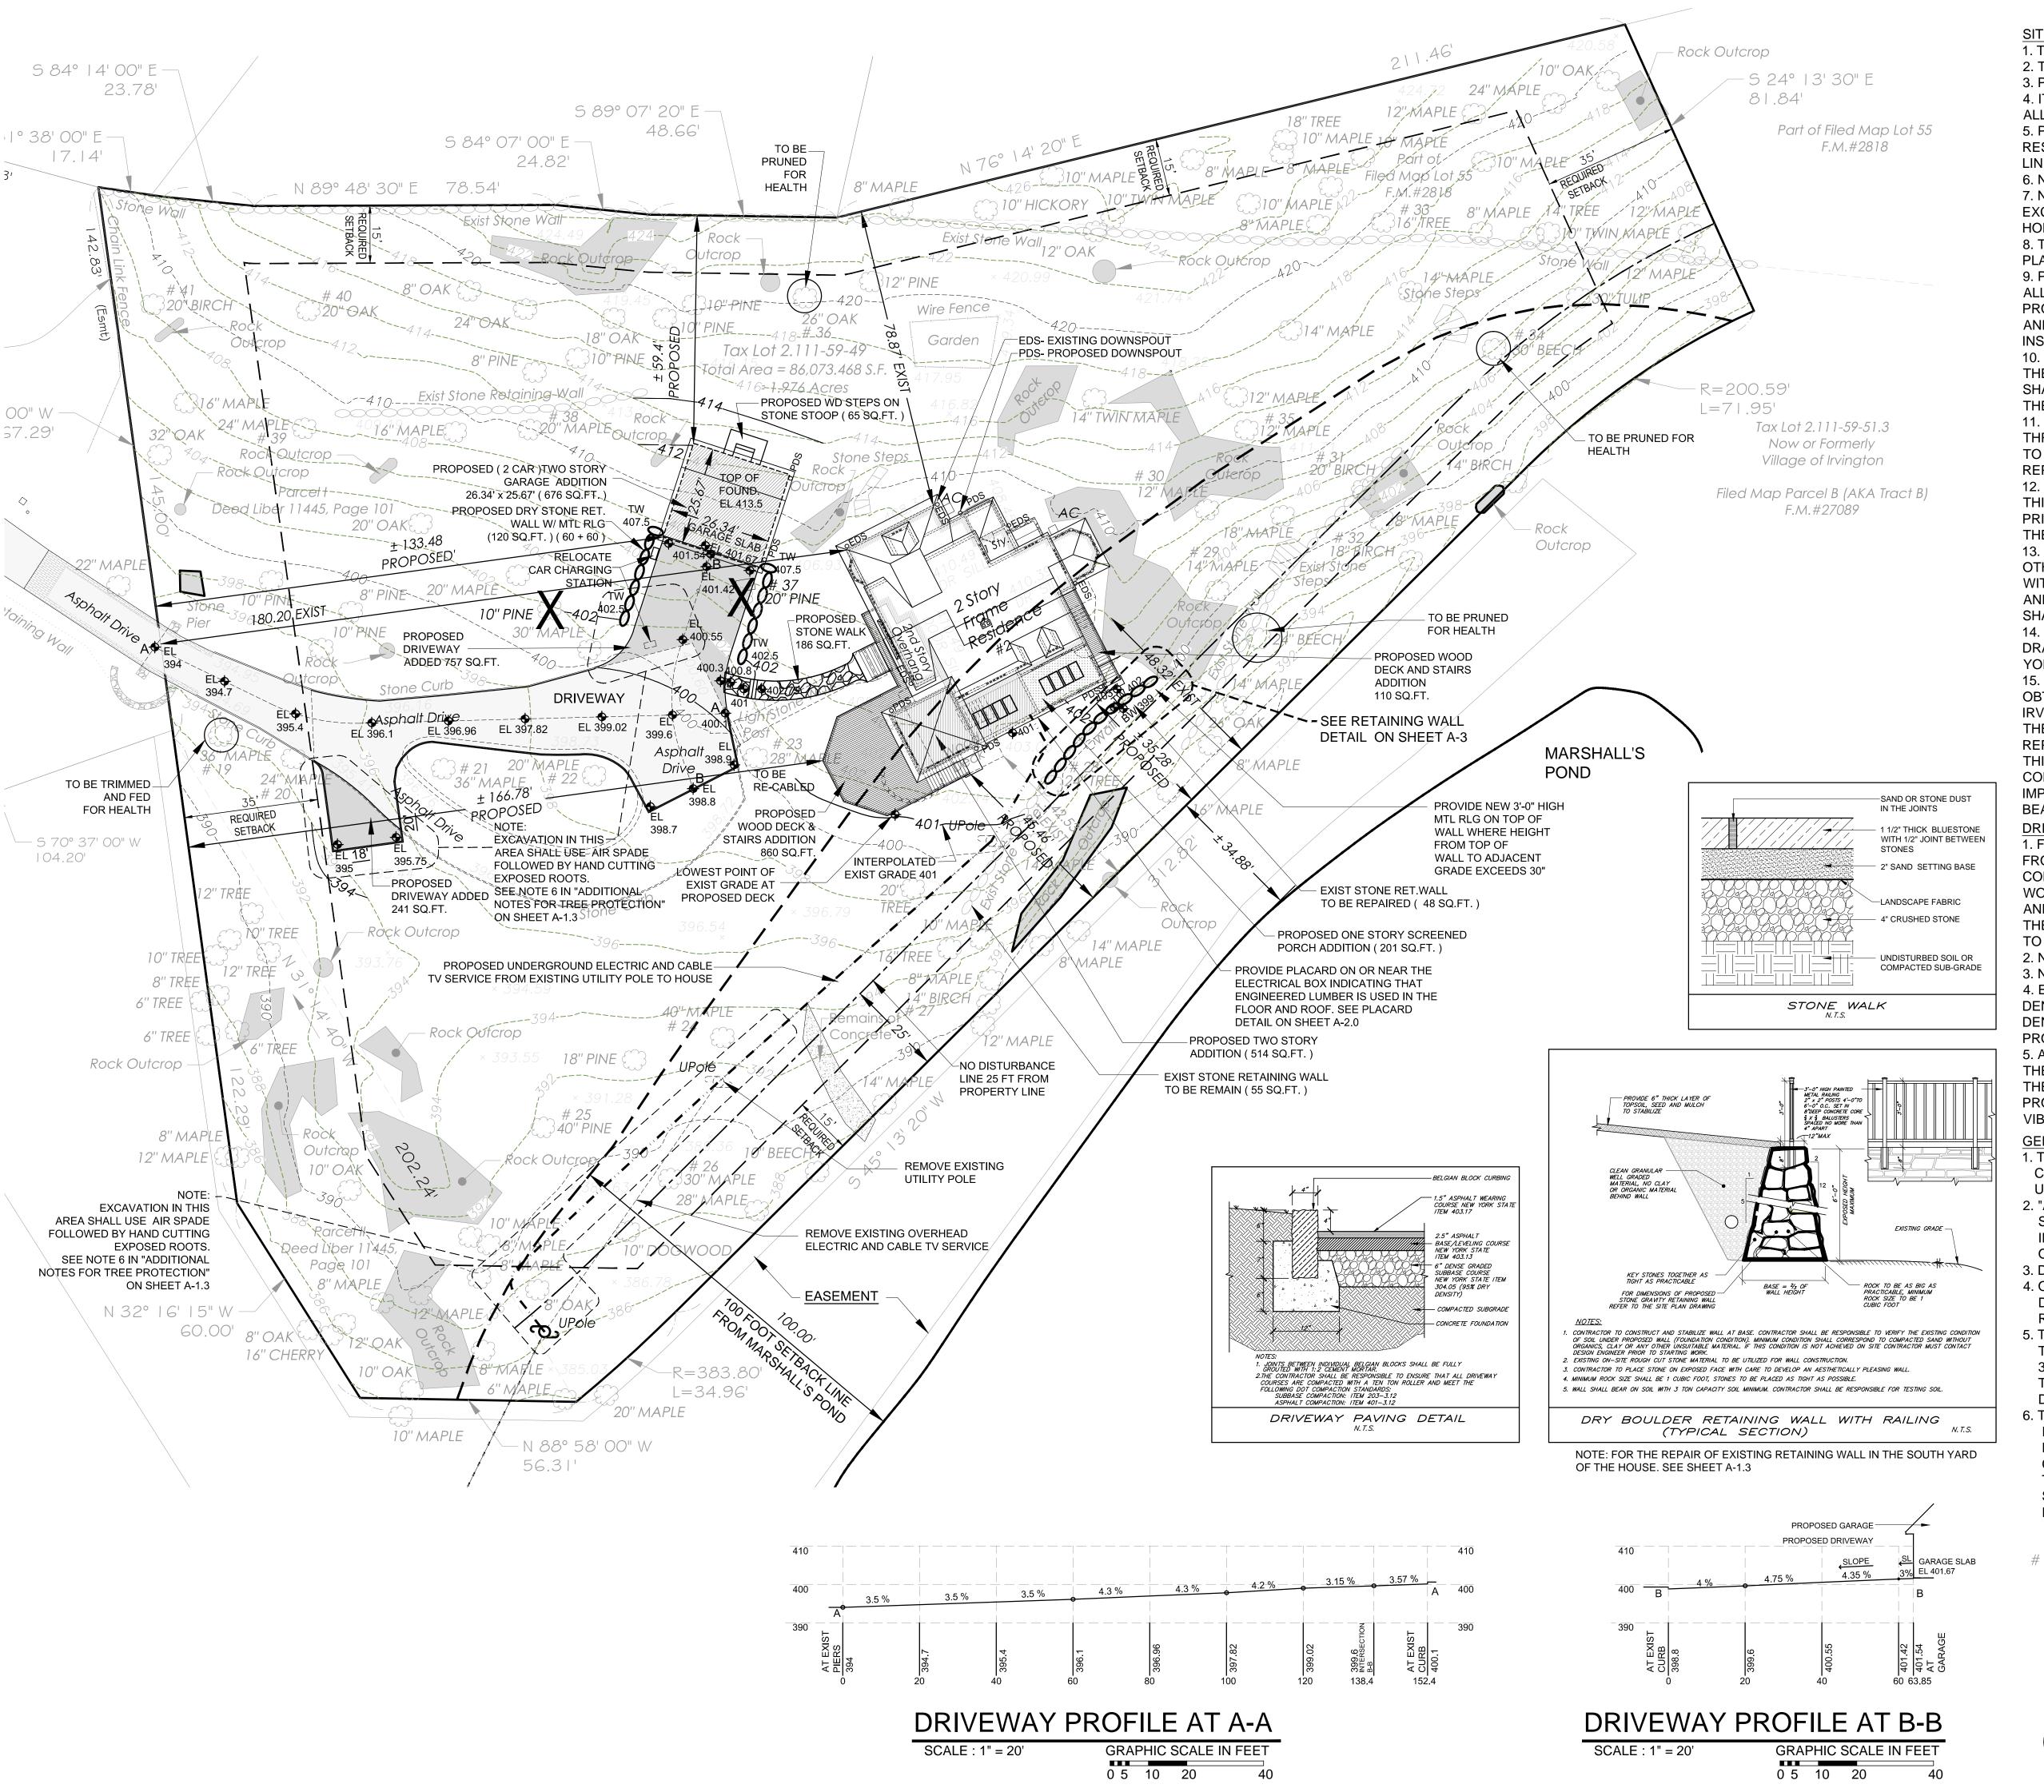

SITE DEVELOPMENT NOTES:

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6. NO BLASTING WILL BE USED FOR THIS PROJECT.
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14. UNAUTHORIZED ALTERATIONS OR ADDITIONS TO THIS

14. UNAUTHORIZED ALTERATIONS OR ADDITIONS TO THIS DRAWING ARE A VIOLATION OF SECTION 7209 (2) OF THE NEW YORK STATE EDUCATION LAW.

15. THIS PLAN WAS PREPARED FOR THE PURPOSE OF OBTAINING A BUILDING PERMIT FROM THE VILLAGE OF IRVINGTON TO CONSTRUCT THE ITEMS SHOWN GENERALLY IN THE LOCATIONS INDICATED ON THIS PLAN. NO REPRESENTATION TO THE SUB-SURFACE SOIL CONDITIONS ON THIS LOT ARE MADE OR IMPLIED BY THIS PLAN. IT IS THE CONTRACTOR'S RESPONSIBILITY TO INSURE THAT ALL IMPROVEMENTS ARE PLACE ON MATERIAL WITH A SUITABLE BEARING CAPACITY.

**DRIVEWAY FILL COMPACTION NOTES** 

1. FILL SHALL BE DEFINED AS SUITABLE MATERIALS OBTAINED FROM EITHER ON-SITE OR OFF-SITE SOURCES AND SHALL CONSIST OF WELL GRADED SOIL AND ROCK WHICH IS FREE OF WOOD, METAL, ORGANIC OR OTHER DELETERIOUS MATERIALS AND CONTAIN LESS THAN 30% FINES (PASSING NO.200 SIEVE). THE MAXIMUM ROCK SIZE IN ANY DIMENSION SHALL BE EQUAL TO THE MAXIMUM THICKNESS.

2. NO FILL SHALL BE PLACED IN STANDING WATER.

3. NO FILL SHALL BE PLACED ON FROZEN GROUND.

3. NO FILL SHALL BE PLACED ON FROZEN GROUND.
4. EACH LIFT OF FILL SHALL BE COMPACTED TO A MINIMUM DRY DENSITY EQUAL TO 95% OF THE MATERIAL'S MAXIMUM DRY DENSITY AS DETERMINED BY ASTM D 1557-78 (MODIFIED PROCTOR TEST).

5. AFTER FILL WORK HAS BEEN COMPLETED IN PAVEMENT AREA THE AREA SHALL BE GRADED SMOOTH TO WITHIN 0.1 FEET OF THE SUBGRADE ELEVATIONS SHOWN ON THE DRAWINGS AND PROOF ROLLED BY 6 PASSES OF THE 5 TON STATIC WEIGHT VIBRATOR ROLLER.

GENERAL NOTES:

1. THE VILLAGE ENGINEER MAY REQUIRE ADDITIONAL EROSION CONTROL MEASURES IF DEEMED APPROPRIATE TO MITIGATE UNFORESEEN SILTATION AND EROSION OF DISTURBED SOILS.

2. "AS-BUILT" DRAWINGS OF THE SITE IMPROVEMENTS SHALL BE

SUBMITTED TO THE VILLAGE ENGINEER AND BUILDING INSPECTOR FOR REVIEW PRIOR TO OBTAINING CERTIFICATE OF OCCUPANCY.

3. DEMOLITION MATERIAL SHALL NOT BURIED ON SITE.

4. ONCE DISTURBED AREAS ARE FULLY STABILIZED AND DRAINAGE SYSTEM IS FREE OF DEBRIS AND SEDIMENT, REMOVE EROSION AND SEDIMENT CONTROLS.

5. THIS SITE PLAN IS BASED ON A SURVEY PREPARED BY:

TC MERRITTS LAND SURVEYORS
394 BEDFORD ROAD PLEASANTVILLE, NY 10570
TEL 914 769-8003 203 622-8822
DATED AS REVISED SEPTEMBER 17, 2019

6. THE LOCATION OF MARSHALL'S POND AND WETLANDS IN THE IRVINGTON CONSERVATION AREA ARE AS SHOWN ON SHEET DS-3.2 STORM WATER POST DEVELOPMENT PREPARED BY CRONIN ENGINEERING P.E. P.C. DATED 02-20-2002. THE SETBACK OF 25 FEET FOR THE FOR THE BUFFER IS


SHOWN MEASURED FROM THE PROPERTY LINE OF THE BINN PARCEL, NOT FROM THE EDGE OF THE POND.

LIST OF TREE
# TREE

---- 10" PINE IMPROVE HEALTH OF ADJACENT TREES

# 37 20" NORWAY IN DECLINE, THREATENS EXIST HOUSE, CONFLICTS WITH GARAGE


# - NUMBERS ARE FROM A. WAYNE CAHILLY TREE EVALUATION FROM OCTOBER 24, 2019

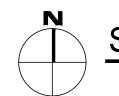

SITE PLAN

SCALE : 1" = 20' GRAPHIC SCALE IN FEET
0 5 10 20 40

TO THE BEST OF MY KNOWLEDGE, BELIEF, AND PROFESSIONAL JUDGEMENT OF THE UNDERSIGNED, THE PLANS AND SPECIFICATIONS DEPICTED ON THESE DRAWINGS ARE IN COMPLIANCE WITH THE APPLICABLE PROVISION OF THE NEW YORK STATE UNIFORM FIRE PREVENTION AND BUILDING CODE AND THE NEW YORK STATE ENERGY CONSERVATION CONSTRUCTION CODE CURPENTLY IN SESECT.

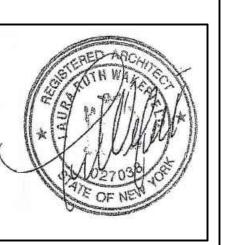

ARCHITECT
329 BROADWAY

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ON THESE DRAWINGS IN ANY WAY

No. 27038

ANIEL BINNS
OAD
K 10533

HERITAGE HILL R

RVINGTON, NEW YOR

GOTHAM DESIGN

AND COMMUNITY

DEVELOPMENT LTD.

329 Broadway
Dobbs Ferry, N.Y. 10522
Phone: ( 914 ) 693-5093
Fax: ( 914 ) 693-5390
email: arch329@gmail.com

ISSUED FOR / REVISIONS:
REVISED 02-19-2020
REVISED 02-28-2020
GRADING BETWEEN PROPOSED
TERRACE AND PROPERTY LINE
(ELIMINATED RET'G WALL)
PROPOSED GARAGE LOCATION
AND DRIVEWAY
ADDED DRIVEWAY PROFILE

REVISED 03-18-2020
PROPOSED GARAGE LOCATION
PROPOSED DRIVEWAY GRADING
DRIVEWAY PROFILE
PROPOSED STONE WALK
PROPOSED DECK + STAIRS
PROPOSED GRADING AT SOUTH
SIDE OF HOUSE
ELIMINATED PROP. TERRACE
ADDED EXIST UTILITIES

ADDED EXIST OTILITIES
ADDED STONE WALK DETAIL
ADDED MARSHALLS POND LINE
REVISED 04-21-2020
DRIVEWAY AND PROFILES
ADDED 100 FT SETBACK LINE
FROM MARSHALL'S POND

REVISED 05-20-2020
ADDED NOTES
REVISED 12-24-2020
ELIMINATED 1 STORY ADDITION
ADDED LOCATION OF PLACARD

ELIMINATED 1 STORY ADDITION ADDED LOCATION OF PLACAR (ENGINEERED WOOD) NOTE

SHEET TITLE:

SITE PLAN

SHEET TITLE:

SITE PLAN

DATE: DRAWN BY:

01-22-2020 MB

SCALE: CHECKED BY:

AS NOTED PRS

A-1.1

#### **VOLUME CHART**

| SPACE               | EXISTING       |        | PROPOSED       |        |
|---------------------|----------------|--------|----------------|--------|
|                     | SQUARE FOOTAGE | VOLUME | SQUARE FOOTAGE | VOLUME |
| BASEMENT            | 1,927          | 12,610 | 442            | 3,978  |
| FIRST FLOOR         | 1,970          | 20,095 | 573            | 5,845  |
| <b>SECOND FLOOR</b> | 1,575          | 14,346 | 393            | 4,444  |
| ATTIC               |                | 3,938  |                | 370    |
| TOTAL               | 5,899          | 50,589 | 1,408          | 14,637 |
|                     |                |        |                |        |


14,637 / 50,589 = 28.93%


FLOOR ONLY 10,289 10,289 / 34,441 = 29.87%

**VOLUME CHART NOTES** 

**FIRST & SECOND** 

- 1. THE VOLUME OF THE BASEMENT SPACE HAS BEEN CALCULATED AS THE AREA FOR EACH SPACE WITHIN THE PERIMETER OF THE FOUNDATION BELOW HABITABLE AREA MULTIPLIED BY THE HEIGHT OF THAT SPACE FROM TOP OF SLAB TO TOP OF THE FLOOR STRUCTURE ABOVE
- 2. THE VOLUME OF THE FIRST AND SECOND FLOOR SPACE HAS BEEN CALCULATED AS THE AREA OF EACH SPACE OF HABITABLE AREA WITHIN THE PERIMETER OF THE EXTERIOR SHEATHING MULTIPLIED BY THE HEIGHT OF THAT SPACE FROM THE TOP OF FLOOR TO THE TOP OF STRUCTURE ABOVE, WHETHER FLOOR OR CEILING.
- 3. THE VOLUME OF THE ATTIC HAS BEEN CALCULATED BY MULTIPLYING THE LENGTH, WIDTH AND HEIGHT OF THE AREAS BETWEEN THE CEILING OR FLOOR OUTSIDE OF THE PERIMETER WALLS AND INSIDE THE ROOF SHEATHING. IN THE PROPOSED AREAS THIS CONSISTS OF THE VOLUME OF THE ROOF FRAMING.
- 4.THE EXISTING FOOTPRINT OF THE HOUSE WILL INCREASE FROM 1,970 SQ.FT. TO 2,543 SQ.FT. AN INCREASE OF 29.1 %. THE EXISTING FLOOR AREA IN THE HOUSE WILL INCREASE FROM 3,545 SQ.FT. TO 4,511 SQ.FT, AN INCREASE OF 27.25 %. THE VOLUME OF THE HOUSE WILL INCREASE FROM 50,589 CU. FT. TO 65,226 CU.FT. AN INCREASE OF 28.93 %.

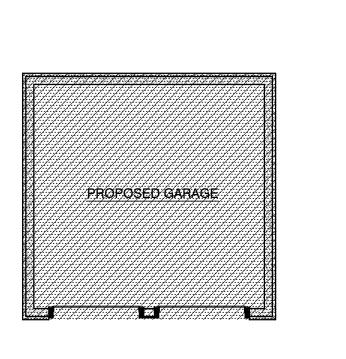

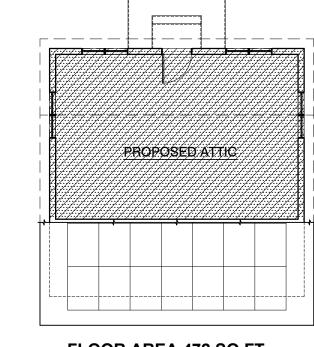

FLOOR AREA 676 SQ.FT.

FLOOR AREA 1,385 SQ.FT.

**BSMT FLOOR PLAN** 


SCALE: 1" = 15' GRAPHIC SCALE IN FEET

**PROPOSED** 

UNIPRO BSOA

FLOOR AREA 472 SQ.FT. **EXCLUDED FROM FAR CALCULATION** AS PER SECTION 224-137 D ( 1 )

# PROPOSED GARAGE AND ATTIC PLANS

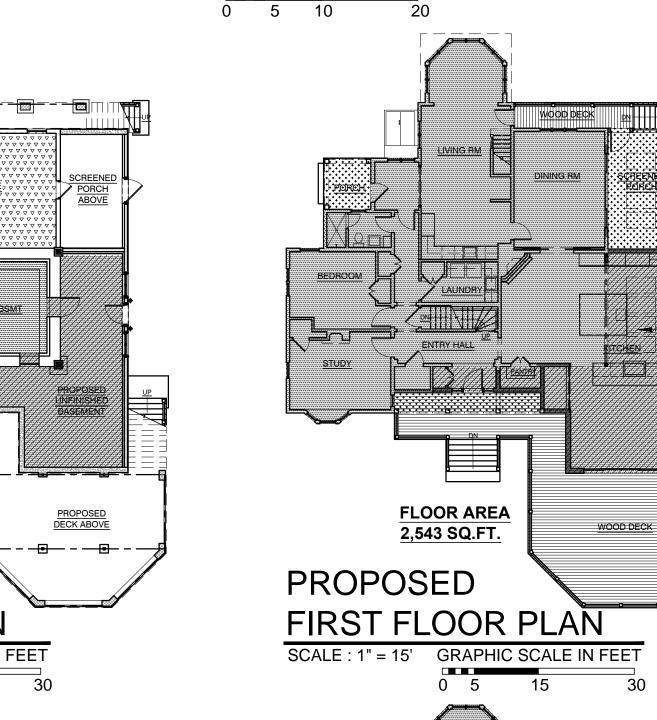

**GRAPHIC SCALE IN FEET** 

FLOOR AREA RATIO CALCULATIONS **EXISTING FLOOR AREA** BASMENT FLR 943 SQ.FT. 1,970 SQ.FT. SECOND FLR 1,575 SQ.FT. **TOTAL** 4,488 SQ.FT. 4,488 / 86,073 = 0.0521 < 0.125

> ADDITION 573 SQ.FT.

BY THE ZONING BOARD OF APPEALS

PROPOSED FLOOR AREA **BASEMENT FLR 1,385 SQ.FT** FIRST FLR 2,543 SQ.FT. SECOND FLR 1,968 SQ.FT. GARAGE **276 SQ.FT. (676 - 400 GARAGE DEDUCTION** AS PER 224-137 D (1))

TOTAL 6,172 SQ.FT. 6,172 / 86,073 = 0.0717 < 0.125 ADDITION-21 SQ.FT.

ZONING TABLE

OWNER: CHARLOTTE AND DANIEL BINNS 2 HERITAGE HILL ROAD IRVINGTON, NY 10533

REQUIRED/

ALLOWED

PLUS 6% OVER 20,000

20,000 x 16 % = 3,200

 $66,073 \times 6 \% = 3,964$ 

(7,164)

UP TO 20,000 SF

20,000

**EXISTING** 

86, 073

± 200

± 400

180.2

181.4

48.32

78.87

29.33

0.0521

4.75 ( 4,091 )

PROPOSED

UNCHANGED

UNCHANGED

UNCHANGED

6.97 (6,003)

UNCHANGED

UNCHANGED

UNCHANGED

UNCHANGED

0.0717

35.28

166.78 TO PROPOSED ADDITION

133.48 TO PROPOSED GARAGE

59.4 TO STOOP AT PROP.GARAGE

UNITS

SQ.FT.

FEET

FEET

FEET

FEET

FEET

FEET

NUMBER

FEET

NUMBER

SQ. FT.

0.125

LOT COVERAGE NOTE FOR OVERSIZED LOTS PER SECTION 224-13.B: THE SUM OF ALL AREAS COVERED BY ALL PRINCIPAL AND ACCESSORY BUILDINGS IN LOTS LOCATED IN 1F-5, 1F-10 AND 1F-20 DISTRICTS SHALL NOT EXCEED THAT WHICH WOULD BE PERMISSIBLE IF THE LOT WERE LOCATED IN THE DISTRICT HAVING THE LARGEST MINIMUM LOT SIZE SMALLER THAN THE AREA OF THE LOT. BASED ON THIS SECTION LOT COVERAGE CALCULATES AS FOLLOWS: 6.75% UP TO 80,000 SF PLUS 6% OVER 80,000 ( 80,000 X 6.75% = 5,400 PLUS 6,073 X 6% = 364 5400 + 364 = 5,764 ) NOTE: A VARIANCE HAS BEEN GRANTED

10,000 ( PER 224-136.B )

PROPERTY LOCATION: 2 HERITAGE HILL ROAD TAX ID No 2.111-59-49

ZONING DISTRICT 1 F - 20

REQUIREMENT

MINIMUM NET LOT AREA

MINIMUM LOT WIDTH

MINIMUM LOT DEPTH

MAXIMUM LOT COVERAGE

PER APPLICATION DATA SHEET

( AMENDED AS PER HAHN MEMO )

MINIMUM FRONT YARD SETBACK

MINIMUM REAR YARD SETBACK

MINIMUM SIDE YARD SETBACK 1

MINIMUM SIDE YARD SETBACK 2

OFF STREET PARKING

MAXIMUM FLOOR AREA

MAXIMUM FLOOR AREA RATIO

MAXIMUM HEIGHT (ROOF PITCH > 5 in 12)

SEE NOTE BELOW PERTAINING TO OVERSIZED LOTS

**FLOOR AREA** 1,968 SQ.FT.


### PROPOSED SECOND FLOOR PLAN


-ADDITION

<sup>∠</sup>ADDITION

352 SQ.FT.


8 SQ.FT.

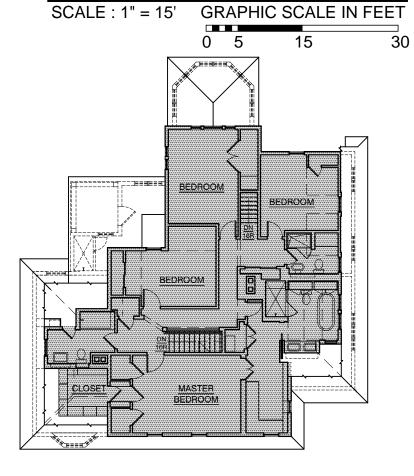

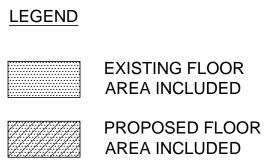






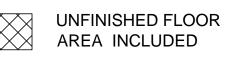


CRAWL SPACE **EXCLUDED** 

FLOOR AREA 1,575 SQ.FT.

#### EXIST SECOND FLOOR PLAN

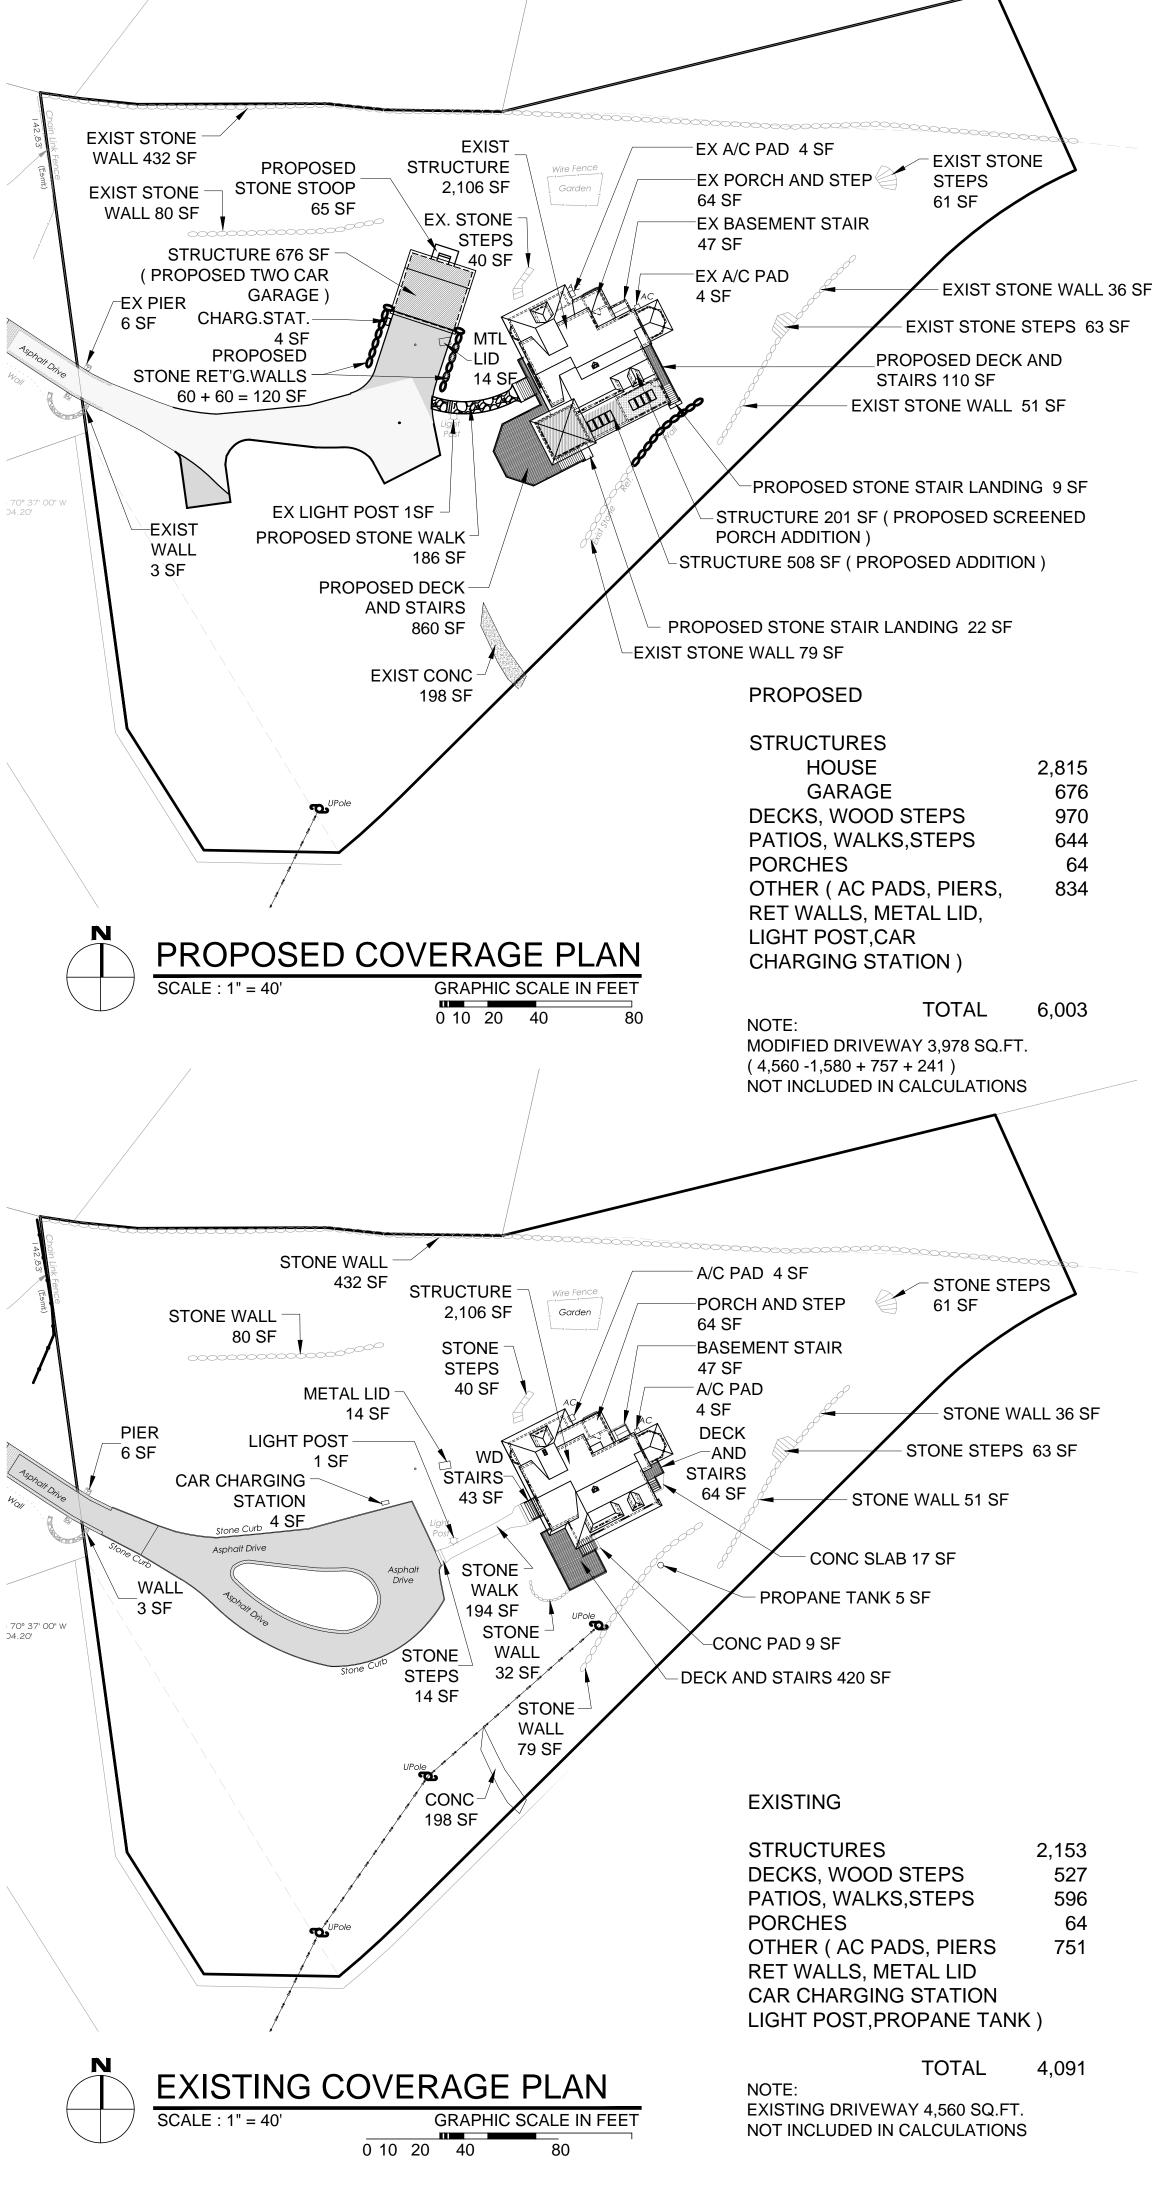

TO THE BEST OF MY KNOWLEDGE, BELIEF, AND PROFESSIONAL JUDGEMENT OF THE LINDERSIGNED THE PLANS AND SPECIFICATIONS DEPICTED ON THESE DRAWINGS ARE IN COMPLIANCE WITH THE APPLICABLE PROVISION OF THE NEW YORK STATE UNIFORM FIRE PREVENTION AND BUILDING CODE AND THE NEW YORK STATE **ENERGY CONSERVATION CONSTRUCTION** CODE CURRENTLY IN EFFECT

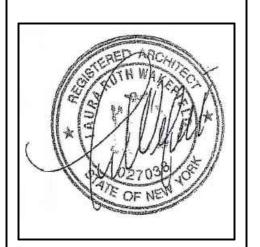

LAURA WAKEFIELD **ARCHITECT** 329 BROADWAY DOBBS FERRY, NY 10522 TEL: 914 693 6165 N.Y.S STATE LICENSE

No. 27038

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> BINN 0

## GOTHAM DESIGN

AND COMMUNITY DEVELOPMENT LTD.

329 Broadway Dobbs Ferry, N.Y. 10522 Phone: (914) 693-5093 Fax: (914) 693-5390 email: arch329@gmail.com

ISSUED FOR / REVISIONS: REVISED 02-19-2020 REVISED ZONING TABLE PROPOSED LOT COVERAGE SETBACKS TO PROP. GARAGE PROPOSED COVERAGE PLAN OTHER - TOTAL

( ELIMINATED RET.G WALL ) **ZONING TABLE** PROPOSED COVERAGE PLAN FLOOR AREA RATIO CALC'S ADDED EXISTING & PROPOSED

BASEMENT PLANS ZONING TABLE PROPOSED COVERAGE PLAN FLOOR AREA RATIO CALC'S ELIMINATED 1 STORY ADDITION CHANGED ZONING TABLE,

PROPOSED LOT COVERAGE & FLOOR AREA RATIO CALC'S ADDED VOLUME CHART & NOTES

**ZONING TABLE** SITE COVERAGE PLANS **FLOOR AREA RATIO CALCULATIONS** DRAWN BY

01-22-2020 MB CHECKED BY: AS NOTED | PRS

A-1.2

## EXIST BSMT FLOOR PLAN

SCALE: 1" = 15'

FLOOR AREA 943 SQ.FT.

**GRAPHIC SCALE IN FEET** 0 5 15

EXIST FIRST FLOOR PLAN SCALE : 1" = 15'


FLOOR AREA 1,970 SQ.FT.

**GRAPHIC SCALE IN FEET** 


WOOD DECK

SCALE: 1" = 15'

**GRAPHIC SCALE IN FEET** 

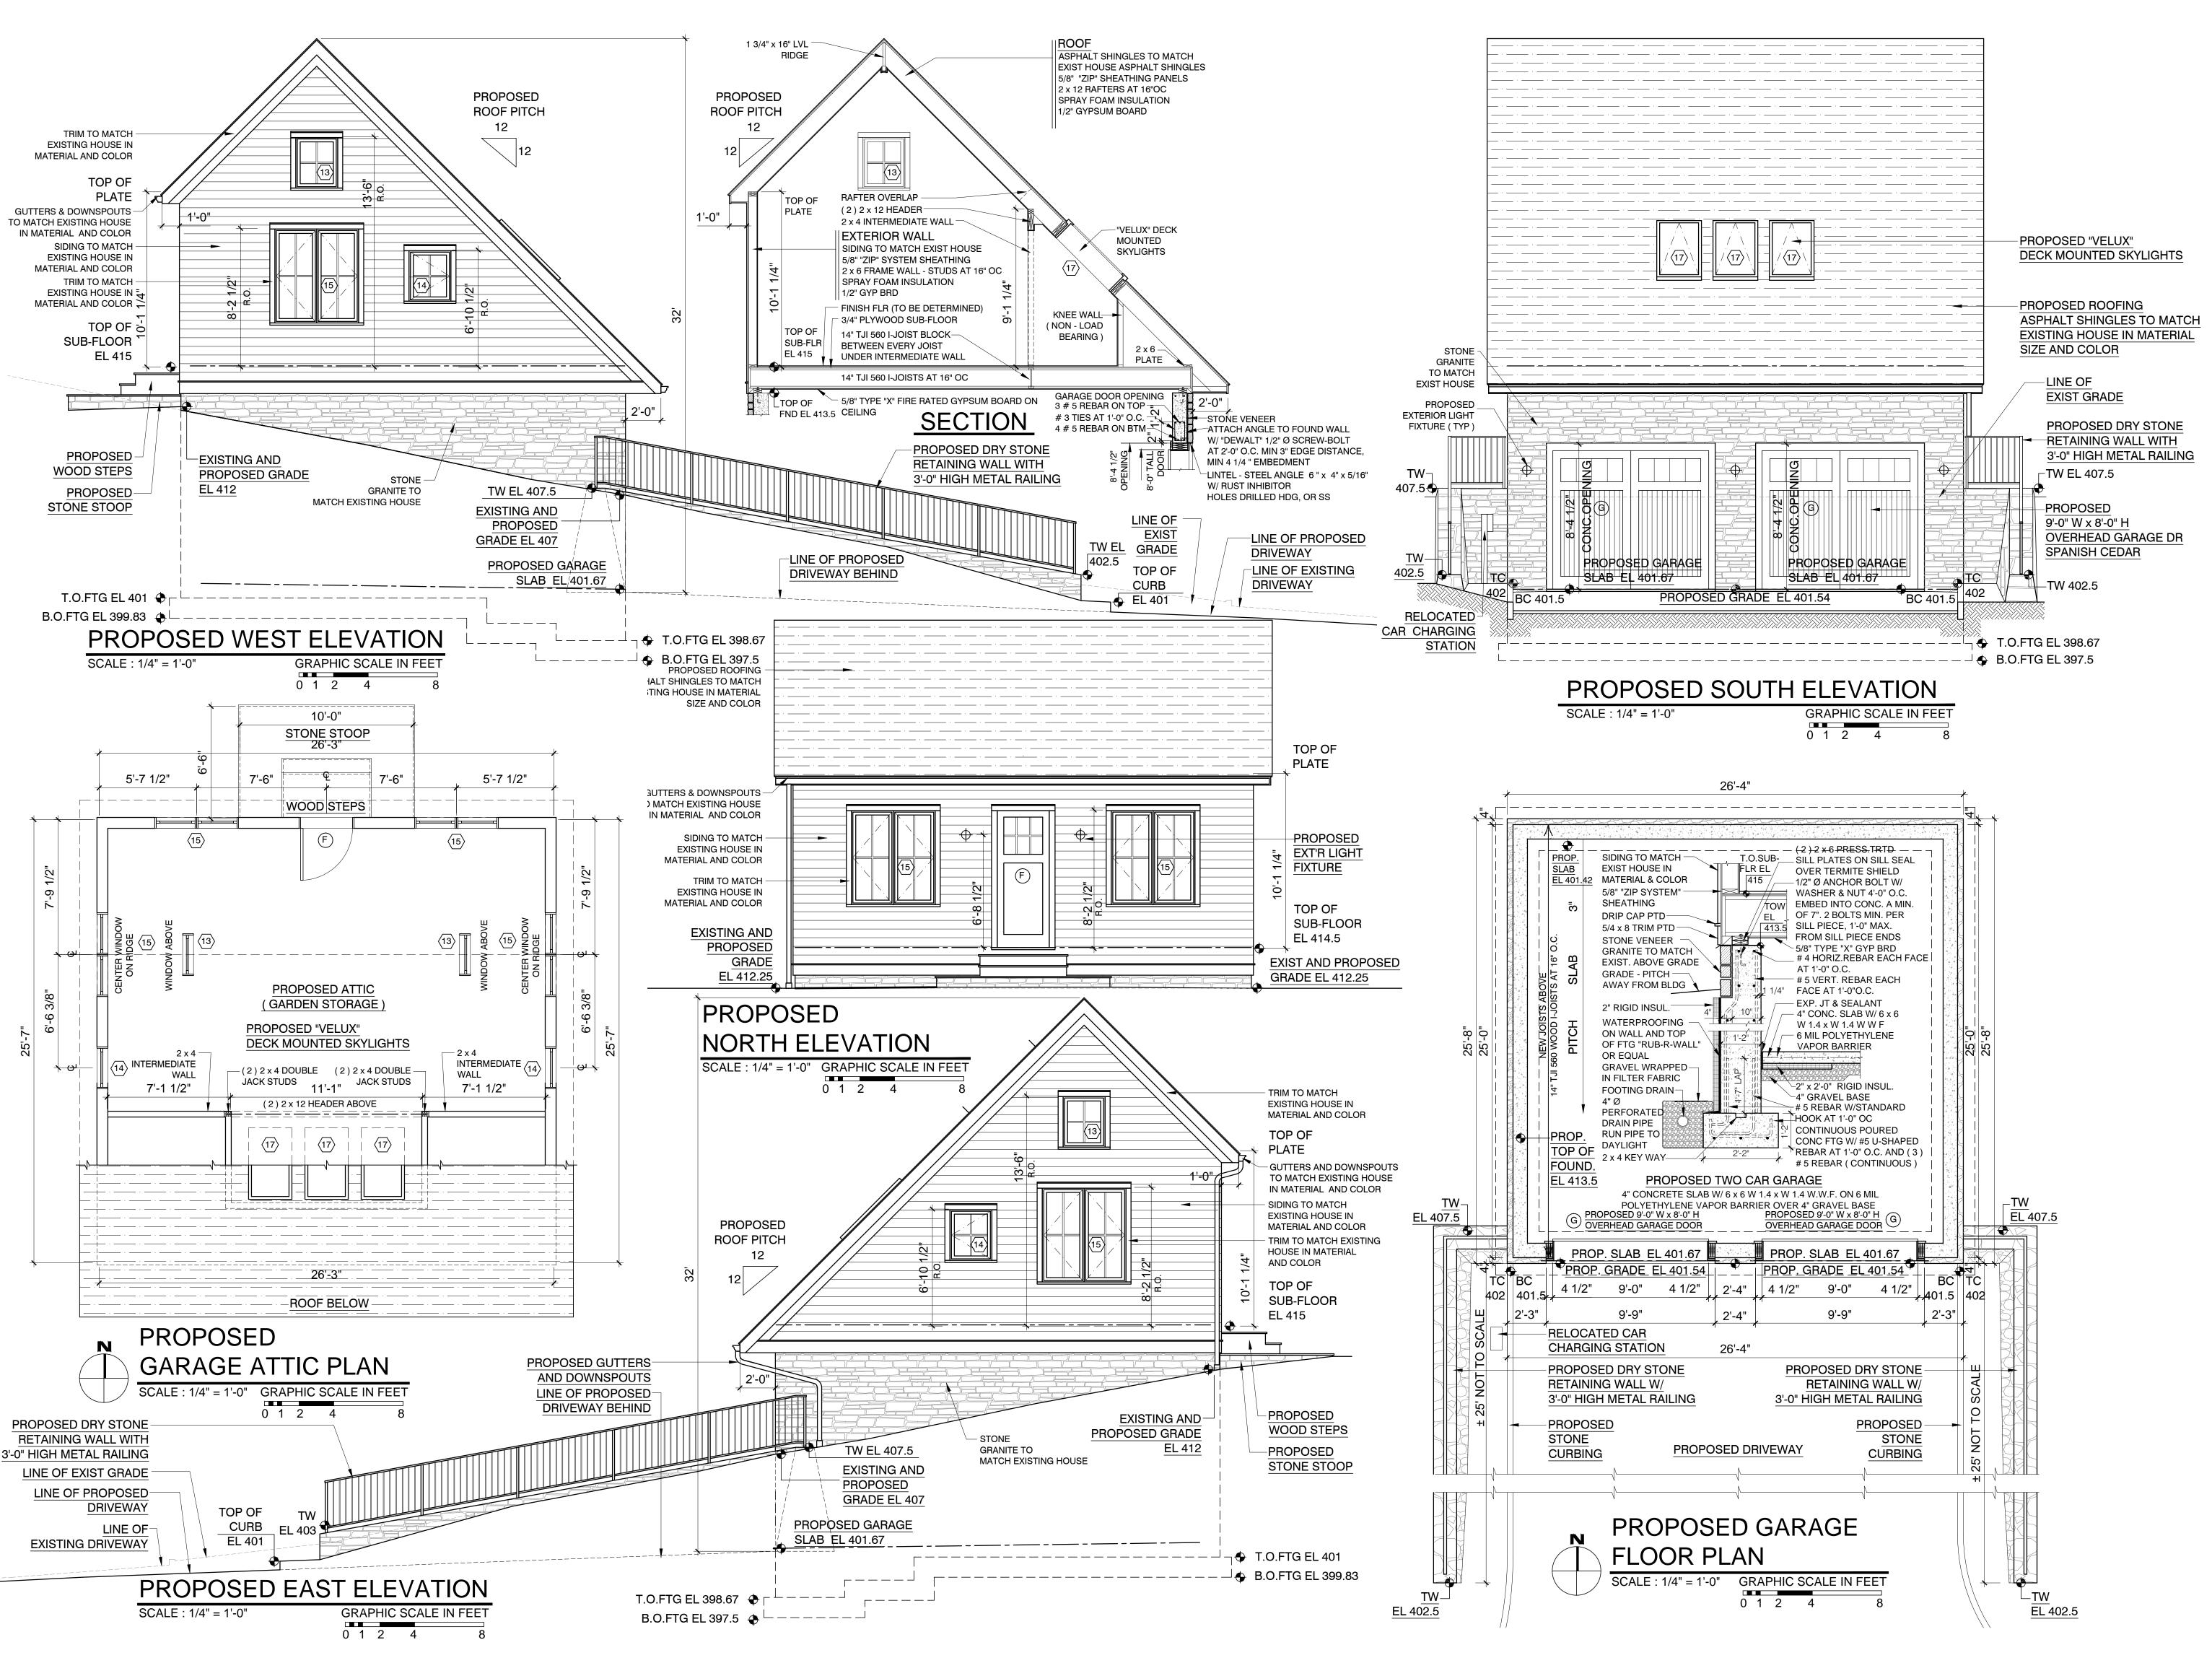

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CHARLOTTE AND DANIEL BIN HERITAGE HILL ROAD

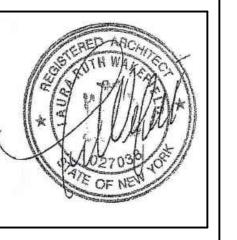RVINGTON, NEW YORK 10533

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AND COMMUNITY
DEVELOPMENT LTD

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email: arch329@gmail.com

ISSUED FOR / REVISIONS:

REVISED 02-28-2020
GARAGE ELEVATIONS
(GARAGE RELOCATED ON SITE)

REVISED 03-18-2020
PROPOSED GARAGE LOCATION

PROPOSED GARAGE LOCATION
REVISED GRADING
ADDED METAL RAILINGS
ADDED EXT'R LIGHT FIXTURES
ADDED GUTTERS, DOWNSPOUTS
REVISED 04-21-2020
RAISED PLATE HEIGHT 2 FEET
RAISED WINDOW /DOOR HEIGHT

REVISED 07-06-2020
ADDED DR & WINDOW SYMBOLS
EXTERIOR FINISH LABELS
REVISED 10-15-2020
REVISED 12-24-2020
FOUNDATION AND FOOTING
REINFORCEMENT STEEL

REINFORCEMENT STEEL
STEEL ANGLE LINTEL
REVISED 02-23-2021
CHANGED FROM METAL ROOF
TO ASPHALT SHINGLE ROOFING
REMOVED SOLAR PANELS

SHEET TITLE:
PROPOSED
GARAGE PLAN
AND ELEVATIONS

DATE: DRAWN BY:
01-22-2020 MB

SCALE: CHECKED BY:
AS NOTED PRS

A-3.3