APPLICATION FOR BUILDING PERMIT

The Village of Irvington | 85 Main St | Irvington NY 10533

| Application Number: | 968 | Date: | 09/28/2021 | |
|---------------------|------------------|-----------------|--------------|--|
| Job Location: | 25 S COTTENET ST | Parcel ID: | 2.80-31-19 | |
| Property Owner: | POOR, HOOMAN | Property Class: | 1 FAMILY RES | |
| Occupancy: | One/ Two Family | Zoning: | | |
| Common Name: | | | | |

| Applicant | Contractor | |
|--|------------|--|
| Brian Crowley | | |
| BCA | | |
| 65 Birch RoadBriarcliff Manor NY 10510 | | |
| 917-301-3616 | | |

Description of Work

| Type of Work: | Addition | Applicant is: | Architect |
|----------------------|-----------|----------------------|--------------|
| Work Requested by: | The Owner | In association with: | |
| Cost of Work (Est.): | 600000.00 | Property Class: | 1 FAMILY RES |

Description of Work

- 1. Complete demolition and removal of the existing front entry portico.
- . Complete demolition and removal of the existing deck off the rear of the residence.
- . Complete demolition and removal of the existing shed roof and exterior walls off the rear of the sidence covering/enclosing an existing sunroom.
- 4. Complete demolition and removal of the existing gable roof and dormers on the second story of the sidence.
- 5. Expansion of existing front porch.
- . Construction of a single-story addition off the rear of the residence allowing for an unenclosed vered deck; a new hip roof will cover the unenclosed covered deck.
- 7. Construction of a new deck off the rear of the residence.
- 8. Construction of a new gambrel roof with front and rear shed roofs on the top floor of the residence.

Please Note: Completing the application does not constitute a permit to commence construction. To obtain your permit follow the instructions on the instruction page provided on page 3.

Job Location: 25 S COTTENET ST

Parcel Id: 2.80-31-19

| AFFID | AVIT | OF | APPI | ICANT |
|-------|------|----|------|-------|

| | Crowley being duly sworn, depose and says: That s/he does business as: BCA with offi liff Manor NY 10510 and that s/he is: | ces at: 65 Birch Road |
|------------------------------|--|---|
| | The owner of the property described herein. The of the New York Corporation | _ with offices at: |
| | duly authorized by resolution of the Bo | oard of Directors, and that |
| | said corporation is duly authorized by the owner to make this application. | |
| | A general partner of with offices Partnership is duly authorized by the Owner to make this application. The Lessee of the premises, duly authorized by the owner to make this application. The Architect of Engineer duly authorized by the owner to make this application. The contractor authorized by the owner to make this application. | and that said |
| kno Un law Sw No | at the information contained in this application and on the accompanying drawings is true owledge and belief. The undersigned hereby agrees to comply with all the requirements ifform Fire Prevention and Building Code, the Village of Irvington Building Code, Zoning Coverage of September 1997. In the construction applied for, whether or not shown on plans or september 1997. In the construction applied for, whether or not shown on plans or september 1997. In the construction applied for, whether or not shown on plans or september 1997. In the construction applied for, whether or not shown on plans or september 1997. In the construction applied for, whether or not shown on plans or september 1997. In the construction applied for, whether or not shown on plans or september 1997. In the construction applied for, whether or not shown on plans or september 1997. In the construction applied for, whether or not shown on plans or september 1997. In the construction applied for, whether or not shown on plans or september 1997. In the construction applied for, whether or not shown on plans or september 1997. In the construction applied for, whether or not shown on plans or september 1997. In the construction applied for, whether or not shown on plans or september 1997. In the construction applied for, whether or not shown on plans or september 1997. In the construction applied for, whether or not shown on plans or september 1997. In the construction applied for, whether or not shown on plans or september 1997. In the construction applied for, whether or not shown on plans or september 1997. In the construction applied for, whether or not shown on plans or september 1997. In the construction applied for, whether or not shown on plans or september 1997. In the construction applied for the construct | of the New York State Ordinance and all other pecify in this application. |
| | R, HOOMAN as the owner of the subject premises and have authorized the contractor named and the subject application. | amed above to perform the |
| Ov | wher phone number £17-429-2907 Owner email address hooman poor to ensure that if the permit (if issued) receives a Final Certificate of Approval from the Entrement of the property for which this permit is being requested. Sworn to before me this and day of address hooman poor the constraint of the | ility as the property owner Building Department and |
| | Notary Public / Commission of Deeds Applicant's S | ignature |
| | MONIQUE HAMILTON NOTARY PUBLIC, STATE OF NEW YORK Registration No. 01HA6345266 Qualified in Queens County Office Commission Expires 10, 120, 120, 120, 120, 120, 120, 120, | |

VILLAGE OF IRVINGTON PLANING BOARD DECISION

WHEREAS, in June 2021, Hooman Poor applied for site development plan approval to construct an addition to his house at 25 South Cottenet Street, which is located in the View Preservation District and is a non-contributing building in the Historic District; and

WHEREAS, the proposed improvements require variances from the Zoning Board of Appeals (ZBA) for coverage, FAR, and incursion into the rear yard setback; and

WHEREAS, James J. Hahn Engineering, P.C. reviewed the plans and, in Memoranda dated June 1, July 6 and July 31, 2021, listed a number of items, most of which were addressed in subsequent submissions; and

WHEREAS, Suzanne Nolan, the Village's landscape consultant, reviewed the plans and made several recommendations, most of which were addressed in subsequent submissions; and

WHEREAS, the Planning Board held a public hearing on the application on June 2, July 6, and August 4, 2021; and

WHEREAS, the proposed improvements would not impact the view of the Hudson River from neighboring properties; and

WHEREAS, the action is a Type II action under the State Environmental Quality Review Act and, therefore, requires no environmental review; now, therefore, be it:

RESOLVED that the Planning Board grants the application for site development plan approval of the improvements reflected in the drawings entitled "Poor Residence," Sheets A-0.1, A-0.2, A-0.3, A-0.4, A-0.5, A-1.1, A-2.1, A-2.2, A-2.3 and A-3.2 (all last dated 7-19-21), and A-3.1 (last dated 6-23-21), prepared by Brian Crowley Architecture, subject to: (1) receiving variances from the ZBA for coverage, FAR and the rear yard setback; and (2) noting on the drawings that existing planting should be preserved and protected, as requested by Nolan.


Dated: August 4, 2021

Mutal 1/1

Dan McElligott

Laurie Davidowitz

NB: This approval is not a substitute for a building permit. Construction may not commence until the Building Inspector issues a building permit.

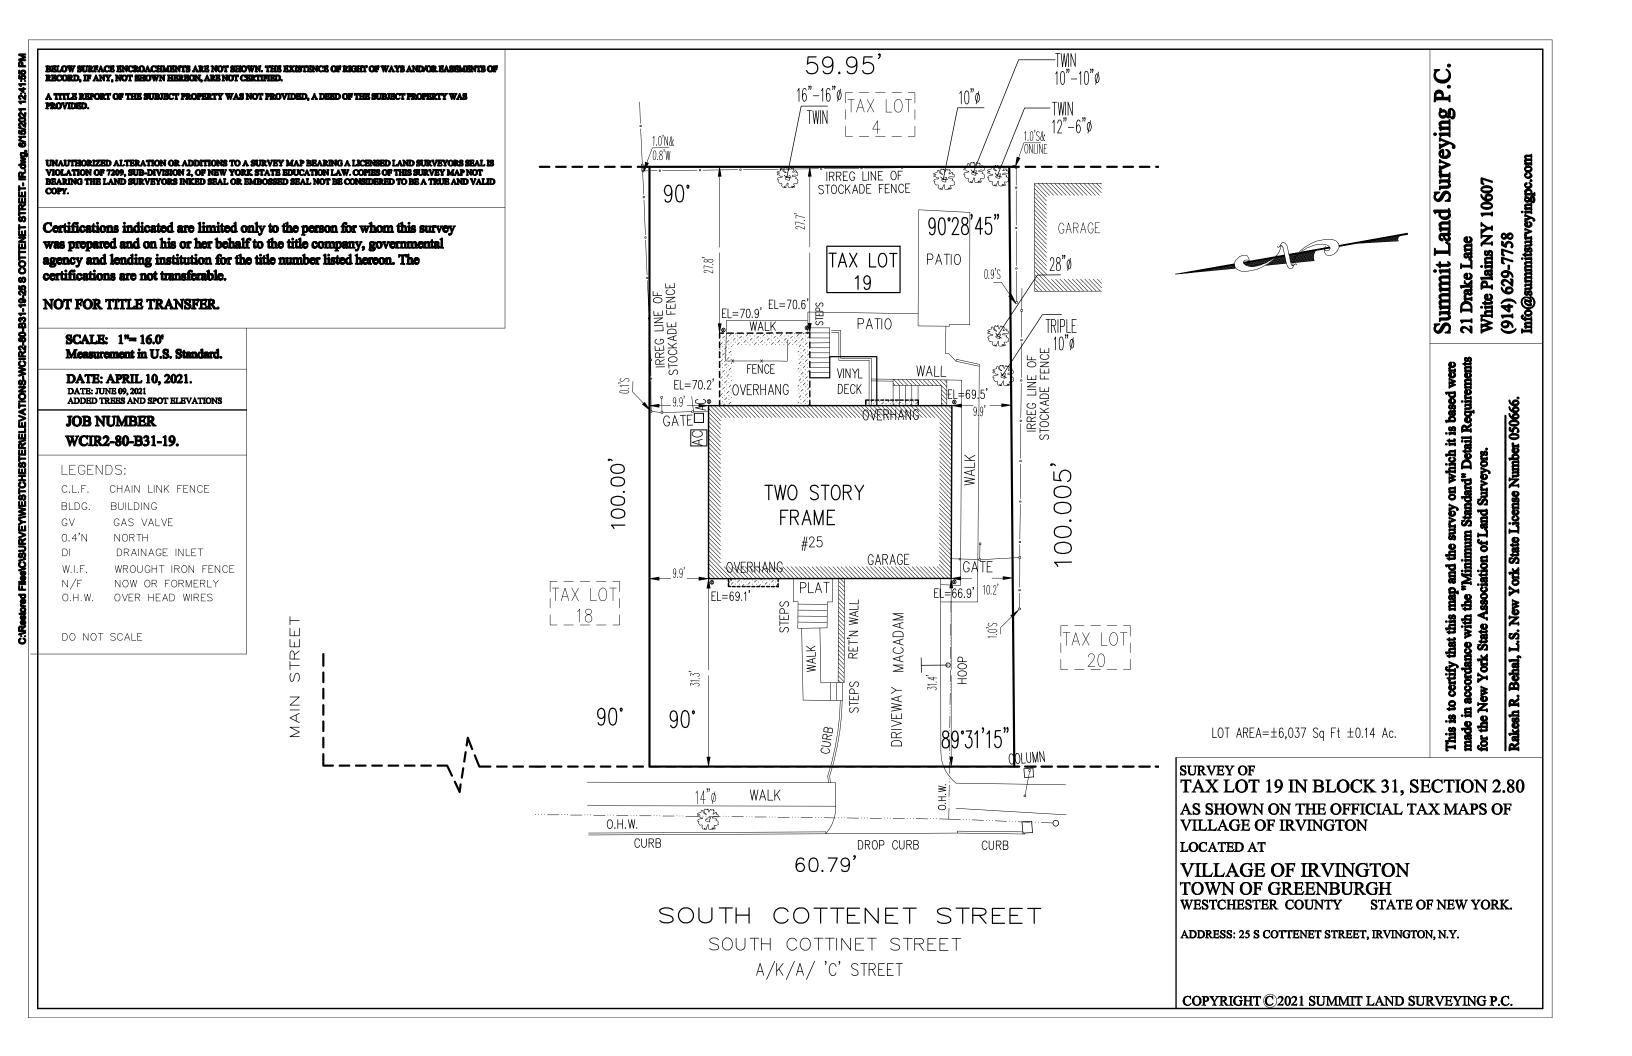

VILLAGE OF IRVINGTON

PLANNING BOARD

85 MAIN STREET IRVINGTON, NEW YORK 10533 TEL: (914) 591-8335 • FAX: (914) 591-5870



IRVINGTON PLANNING BOARD SURVEY CERTIFICATION

| I, RAKESA R. BELLAL, DO HEREBY CERTIFY to the Village of Irvington as follows: |
|--|
| 1. I am a licensed land surveyor or professional engineer (strike whichever is not applicable), licensed by the State of New York on 5 ept 28, 2007, and my license is in good standing on the date of this Certificate. My office address is: 21 DRAGE (ANE, WHITE PLAINS N |
| 2. I have examined the attached survey dated APRIL 19 7021, made by |
| SUMMIT LAND SURVEYING P.C., of the property located at 25 |
| COTTENET STREET, IRVINGTON, NY. |
| 3. [check one] The survey shows the property in its present condition. There has been no change in any of the boundary lines of the property, and no change in, addition to, or relocation or removal of any building (other than changes inside a building that do not result in any change in the location or configuration of any external wall thereof), fence, driveway, paved area, or other structure or improvement shown on the survey. |
| No buildings, fences, driveways, paved areas, or other structures or improvements have been constructed on or next to the property since the date of the survey, except the following: |
| IN WITNESS WHEREOF, I do certify this oday of Jyne, 2021. |
| [Seal] |
| |
| |


| GLOSSARY | | | |
|----------------------------|---|---------------------|--|
| ABV. A.D. ADJ ACT | ABOVE AREA DRAIN ADJACENT | MAX. MED MECH | MAXIMUM MEDICINE CABINET MECHANICAL MINIMUM |
| ACT | ACOUSTIC CEILING TILE ABOVE FINISH FLOOR | MIN. | |
| ALUM | | MTL | METAL |
| ALUM | ALUMINUM | MV | MICROWAVE |
| BLKG | BLOCKING | (N) | NEW |
| BLDG | BUILDING | N.I.C. | NOT IN CONTRACT |
| BD | BOARD | NTS | NOT TO SCALE |
| DU | BOARD | INIO | NOT TO SCALE |
| Œ. | CENTERLINE | O.C. | ON CENTER |
| ČLR | CLEAR | 0/ | OVER |
| CONC | CONCRETE | OD | OVERFLOW DRAIN |
| CONT | CONTINUOUS | O.H. | OPPOSITE HAND |
| CPT | CARPET | 0.11. | OFFOSITE HAND |
| CT | CERAMIC TILE | PLAM | PLASTIC LAMINATE |
| Ci | CERAMIC TILL | PLY. | PLYWOOD |
| DIA | DIAMETER | PTD | PAINTED |
| DIM. | DIMENSION | PID | PAINTED |
| DIMS. | DIMENSIONS | RAD | RADICAL |
| DIMS. | | | |
| | DOWN | REF | REFRIGERATOR |
| DWG | DRAWING | REQ. | REQUIRED |
| | | RB | RUBBER BASE |
| (E), EX. | EXISTING | RM | ROOM |
| EA. | EACH | RO | ROUGH OPENING |
| EJ | EXPANSION JOINT | RDWD | REDWOOD |
| ELEC | ELECTRIC | | |
| EL., ELEV. | ELEVATION | SC | SOLID CORE |
| EMB. | EMBEDDED | SHTG | SHEETING |
| EQ | EQUAL | SHT | SHEET |
| EXT | EXTERIOR | SIM | SIMILAR |
| | | SQ | SQUARE |
| FA | FIRE ALARM | S.S.D. | SEE STRUCTURAL DWGS |
| FD | FLOOR DRAIN | STL | STEEL |
| FF | FINISH FLOOR | ST. STL | STAINLESS STEEL |
| FLR | FLOOR | STOR | STORAGE |
| F.O.S. | FACE OF STUD | STRL | STRUCTURAL |
| F.O.M. | FACE OF MASONRY | STV | SHEET VINYL |
| | | | |
| GA | GAUGE | T&G | TONGUE AND GROOVE |
| GALV | GALVANIZED | T.C. | TOP OF CURB |
| GL | GLASS | TEL | TELEPHONE |
| GND | GROUND | T.O.S. | TOP OF STEEL |
| GSM | GALVANIZED SHEET METAL | T.O.W. | TOP OF WALL |
| GYP. BD. | GYPSUM BOARD | TYP. | TYPICAL |
| GWB | GYPSUM WALLBOARD | | |
| | | U.O.N. | UNLESS OTHERWISE NOTED |
| HB | HOSE BIB | | |
| HC | HANDICAPPED | VCT | VINYL COMPOSITION TILE |
| HM | HOLLOW METAL | VERT. | VERTICAL |
| H.P. | HOUSE PANEL | V.I.F. | VERIFY IN FIELD |
| HT | HEIGHT | ····· | |
| | | WD | WOOD |
| INS. | INSULATION | W/D | WASHER AND DRYER |
| INSUL. | INSULATION | W/ | WITH |
| INT | INTERIOR | WC | WATER CLOSET |
| | IIIILIIOK | WH | WATER CLOSET WATER HEATER |
| JAN | JANITOR CLOSET | WP | WATERPROOF |
| J-11 | JAMES CLOSE I | *** | |

WALL TYPES

| | NEW |
|-------------------|---|
| 1 HOUR RATED WALL | |
| 2 HOUR RATED WALL | //// |
| 3 HOUR RATED WALL | |
| 4 HOUR RATED WALL | 111111111111111111111111111111111111111 |
| | |

KITCHEN


NOTE: REFER TO A-8.1 FOR WALL AND FLOOR ASSEMBLY DETAILS

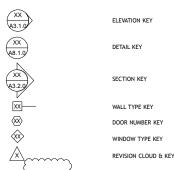

POOR RESIDENCE

SINGLE FAMILY REMODEL & ADDITION

25 SOUTH COTTENET STREET, IRVINGTON, NY 10533

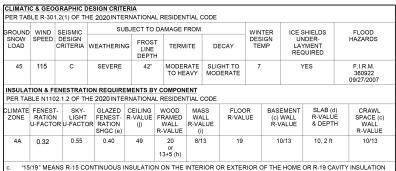

13+5 (h)

"15/19" MEANS R-15 CONTINUOUS INSULATION ON THE INTERIOR OR EXTERIOR OF THE HOME OR R-19 CAVITY INSULATION ON THE INTERIOR OF THE BASEMENT WALL. "15/19" SHALL BE PERMITTED TO BE MET WITH R-13 CAVITY INSULATION ON THE INTERIOR OF THE BASEMENT WALL. "15/19" SHALL BE PERMITTED TO BE MET WITH R-13 CAVITY INSULATION ON THE INTERIOR OF EXTERIOR OF THE OF THE HOME OR R-13 CAVITY INSULATION AT THE INTERIOR OF THE BASEMENT WALL.
R-5 SHALL BE ADDED TO THE REQUIRED SLAB EDGE R-VALUES FOR HEATED SLABS. INSULATION DEPTH SHALL BE THE DEPTH OF THE FOOTING OR 2 FEET, WHICHEVER IS LESS IN ZONE THROUGH 3 FOR HEATED SLABS.
THERE ARE NO SHGC REQUIREMENTS IN THE MARINE ZONE.
THE FIRST VALUE IS CAVITY INSULATION. THE SECOND VALUE IS CONTINUOUS INSULATION, SO "13+5" MEANS R-13 CAVITY INSULATION PLUS R-S CONTINUOUS INSULATION.
THE SECOND R-VALUE APPLIES WHEN MORE THAN HALF THE INSULATION IS ON THE INTERIOR OF THE MASS WALL.
R402.2.1 CEILINGS WITH ATTIC SPACES - INSTALLING R-38 OVER 100% OF THE CEILING AREA REQUIRING INSULATION SHALL BE DEEMED TO SATISFY THE REQUIREMENT FOR R-91 INSULATION WHEREVER THE FULL HEIGHT OF UNCOMPRESSED R-38 INSULATION EXTENDS OVER THE WALL TOP PLATE AT EAVES.

| EXTERIOR DESIGN CONDITIONS - NEW YORK STATE | | | | | |
|---|---------------------------------------|---------------------------------------|---|---------------------------|------|
| COUNTY | WINTER DESIGN DRY-BULB TEMP. | SUMMER DESIGN DRY-BULB TEMP. | COINCIDENT DESIGN WET-BULB TEMP. | HEATING DEGREE DAYS | ZONE |
| WESTCHESTER | 7 | 84 | 73 | 5750 | 4 |

(E) SITE SURVEY (FOR REFERENCE ONLY)

AREA MAP



59.95 BELOW SURFACE ENCROACHMENTS ARE NOT SHOWN. THE E RECORD. IF ANY, NOT SHOWN HERBON, ARE NOT CERTIFIED. 16"-16"0 TAX LOT. TWIN Certifications indicated are limited only to the person for whom this survey was prepared and on his or her behalf to the title company, governmental agency and lending institution for the title number listed hereon. The certifications are not transferrable. 90'28'45 TAX LOT 28°ø 19 OT FOR TITLE TRANSFER PATIO SCALE: 1"= 16.0' Measurement in U.S. Standar FENCE ■ VINYL DECK DATE: APRIL 10, 2021. DATE: JUNE 09, 2021 OVERHANG WCIR2-80-B31-19. TWO STORY BUILDING GAS VALVE NORTH DRAINAGE INLET FRAME #25 GARAGE __18__ TAX LOT DO NOT SCALE 90° 90° 89'31'15' LOT AREA=±6,037 Sq Ft ±0.14 Ac. TAX LOT 19 IN BLOCK 31, SECTION 2.80 WALK AS SHOWN ON THE OFFICIAL TAX MAPS OF 0.H.W. VILLAGE OF IRVINGTON LOCATED AT 60.79 VILLAGE OF IRVINGTON TOWN OF GREENBURGH WESTCHESTER COUNTY STATE OF NEW YORK. SOUTH COTTENET STREET ADDRESS: 25 S COTTENET STREET, IRVINGTON, N.Y. SOUTH COTTINET STREET A/K/A/ 'C' STREET COPYRIGHT © 2021 SUMMIT LAND SURVEYING P.C

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CODE COMPLIANCE STATEMENT

ALL PLANS HAVE BEEN DESIGNED IN COMPLIANCE OF ALL APPLICABLE BUILDING CODES.

COVED CHEET & CHEVEN

ENERGY COMPLIANCE STATEMENT

ALL PLANS HAVE BEEN DESIGNED IN COMPLIANCE OF THE PRESCRIPTIVE ENERGY REQUIREMENTS OF THE 2020 ENERGY CONSERVATION CONSTRUCTION CODE OF NEW YORK STATE.

GENERAL NOTES

- All work shall be in accordance with the 2020 New York State Building Code
- Contractor shall obtain all permits as required prior to start of work and schedule inspections with the building inspector and other regulating authority at appropriate stages of the work as required by code and by the local building inspector. Inspection personnel shall be notified a minimum of five days prior to proposed date of inspections. Work shall not be closed or covered until it has been inspected and
- All work, including plumbing and electrical work, shall be performed by licensed
- All work with engineered lumber and/ or truss construction must be placarded as per NYSDOS.
- The contractor shall maintain a current and complete set of construction drawings and specifications at the construction site during all phases of construction for use of trades, architect and Building Dept. personnel.
- Contractor shall verify all field conditions and dimensions and be responsible for field fit
- Contractor shall notify the architect of any discrepancies in drawings, specifications and field conditions before commencing the work and notify architect immediately if any portion of work cannot be performed as specified.
- The contractor shall not scale drawings for purposes of construction and shall verify any dimensions needing clarification with architect prior to construction
- Construction work shall be done on regular work hours except as directed by owner. All local ordinances regarding noise and nuisance shall be respected.
- Contractor shall exercise strict control over safety and security of the site.
- The contractor(s) shall strictly adhere to requirements of all jurisdictional agencies for The contractor(s) small strictly adnere to requirements of all jurisacional agencies for the protection of all persons from hazards during demolition and construction and during removal of any lead paint, asbestos, pcb's etc. Which might exist on the site. Test all paint and suspected hazardous materials to be removed prior to commencement of work. Notify owner if abatement and mitigation is required. Follow DEP, NY state DOL ICR 56 and US. EPA certification programs for containment, removal, and disposal of waste. Materials used for construction, flabrication or finishes shall be approved per mistigning related an approvise for the respective or process. minimum standard appropriate for the respective purpose
- Contractors shall provide on site first aid facilities and protective gear required by Osha Standards to prevent injury to all workers and persons visiting the site
- The entire areas and the job site shall be maintained in a neat and orderly condition and kept free from waste and rubbish during the entire construction period. Remove materials or trash from the site at the end of each working day.
- All exits, and ways of approach thereto shall be continuously maintained free from all obstructions or impediments to full instant use in the case of fire or other emerging
- Contractor's personnel will be admitted to the property upon permission of the owner. No alcohol nor drug use shall be permitted.
- Contractor will be responsible for repairing any damages or replacing any items Contractor will be responsible to repaining any damages or repaining any items destroyed in the process of the work. Contractor will be responsible for property and materials of any kind on the premises, and shall provide all necessary protection for the work until turned over to the owner.



P. 917.301.3616



POOR RESIDENCE Cottenet Street, NY 10533 & ADDITION REMODEL 25 South (Irvington, I

| over Sheet & |
|----------------|
| xisting Survey |

date

21.05 project KJC drawn by: checked by: 03/02/21 AS NOTED

STRUCTURAL LUMBER / FRAMING NOTES

- INTERIOR DIMENSIONS ARE PROVIDED FROM FINISHED SURFACE TO FINISHED SURFACE, U.N.O.
- PRIOR TO INSTALLATION OF ANY NEW SUBSTRATE & FRAMING, ANY AND ALL, EXPOSED, EXISTING STRUCTURE SHALL BE DOCUMENTED BY ARCHITECT and/or ENGINEER FOR AS-BUILT RECORDS. CONTRACTOR SHALL BE RESPONSIBLE TO SCHEDULE SITE VISIT WITH

ARCHITECT/ENGINEER PRIOR TO COMMENCEMENT OF NEW WORK.

- ALL WOOD FRAMING IN DIRECT CONTACT WITH SOIL, CONCRETE. MASONRY OR WEATHER SHALL BE PRESSURE TREATED (AWPA STANDARD C2, C3).
- ALL FRAMING BELOW THE REQUIRED FLOOD ELEVATION AS SET FORTH BY FEMA AND
- LOCAL BUILDING OFFICIALS SHALL BE PRESSURE TREATED SECURE ALL TEMPORARY RAILINGS WITH GUARDS TO BE INSTALLED
- AROUND ALL FLOOR OPENINGS AND OPEN DOOR OPENINGS. PROVIDE TEMPORARY RAMPS AND/OR STAIRS TO BE INSTALLED AT ALL LEVELS
- ALL FRAMING SHALL BE DONE IN ACCORDANCE WITH THE LATEST EDITION OF "NATIONAL DESIGN SPECIFICATIONS FOR STRESS GRADED LUMBER AND ITS FASTENERS" AS PUBLISHED BY THE NATIONAL LUMBER MANUFACTURERS ASSOCIATION.
- ALL WORKMANSHIP INCLUDING MINIMUM NAILING, BLOCKING, BRIDGING, ETC. SHALL CONFORM THE NEW YORK STATE BUILDING CODE
- ALL LUMBER MATERIALS USED IN CONSTRUCTION SHALL BE NEW, SOUND AND DRY MATERIALS, FREE FROM ROT, LARGE AND LOOSE KNOTS, SHAKES AND OTHER IMPERFECTIONS WHEREBY STRENGTH MAY BE IMPAIRED. SIZES SHALL BE AS INDICATED ON THE DRAWINGS.
- 10. PROVIDE SPECIAL HEAVY-DUTY METAL HANGERS AND/OR STEEL FABRICATIONS WHERE SHOWN AND AS MAY BE REQUIRED TO TRANSFER
- CONTRACTOR SHALL SUPPLY ALL TEMPORARY BRACING OF THE STRUCTURE, AS REQUIRED, UNTIL. ALL EXTERIOR SHEATHING HAS BEEN INSPECTED.
- 12. ALL FRAMING TO BE NO. 1 & NO. 2 DOUGLAS FUR LARCH (NORTH) **DESIGN VALUES:**
 - FB SINGLE MEMBER 825 PSI
 - FB REPETITIVE MEMBER = 1150 PSI
 - FV 75 PSI
 - FC 405 PSI PERPENDICULAR TO GRAIN
 - FC 2400 PSI PARALLEL TO GRAIN
 - E 1,400,000 PSI
- 13. ALL LVL'S TO BE LAMINATED VENEER LUMBER AS MANUFACTURED BY TRUSJOIST, TYPE 2800 F-2.0 OR EQUAL, WITH DESIGN VALUES: FB - 2600 PSI
- FV 285 PSI FC - 750 PSI PERPENDICULAR TO GRAIN
- FC 2510 PSI PARALLEL TO GRAIN
- E 0- 1.9 X10 (6) PSI
- 14. ALL FRAMING INDICATED "LVL" ON PLANS SHALL BE LAMINATED VENEER LUMBER EQUAL TO TRUSJOIST LVL AS MANUFACTURER BY TRUSJOIST, A WEYERHAEUSER BUSINESS (1-800-678-8787) OR APPROVED EQUAL. ALL TJI'S AND PARALLAM PSL'S SHALL BE BY TRUSJOIST OR APPROVED
- 15. FOR DIMENSIONS SEE ARCHITECTURAL PLANS
- 16. ALL JOISTS OR BEAMS FRAMING INTO (NOT BEARING OVER) BEAMS, HEADERS AND GIRDERS SHALL BE SUPPORTED WITH GALVANIZED STEEL JOIST OR BEAM HANGERS BY SIMPSON STRONG-TIE CO. (914-279-2037) OR APPROVED EQUAL. END NAILING OF JOISTS IS NOT PERMITTED. ALL POST TO BEAM, BEAM TO POST AND POST TO FOOTING CONNECTIONS TO BE MADE WITH SIMPSON POST OR COLUMN CAP AND BASE CONNECTORS AS DETAILED. USE NAILING AS RECOMMENDED BY MANUFACTURER.
- 17. BLOCK SOLID BETWEEN JOISTS AND RAFTERS AT BEARING WALLS OR GIRDERS. PROVIDE BRIDGING AT 8'-0" O.C. MAXIMUM.
- 18. ALL PLYWOOD SHEATHING SHALL BE 5/8" EXTERIOR GRADE, C-D SPECIES GROUP 1 OR 2. INSTALL ROOF, FLOOR, WALL SHEATHING WITH FACE GRAIN PERPENDICULAR TO SUPPORTS. STAGGER JOINTS.
- 19. NEW EXTERIOR WALL CONSTRUCTION SHALL BE 2x6 WOOD FRAMING, U.N.O.
- 20. NEW INTERIOR WALL CONSTRUCTION SHALL BE 2x4 WOOD FRAMING, U.N.O.
- 21. NEW ATTIC FLOOR JOISTS & ROOF WOOD RAFTERS SHALL BE 2x10
- MINIMUM, U.N.O. (TO ACCOMMODATE MIN, R-38 INSULATION). 22. ALL FRAMING SHALL BE FRAMED AT 16-INCHES O.C. UNLESS NOTED OTHERWISE
- 23. FOR ALL CONVENTIONAL FLOOR FRAMING PROVIDE A MINIMUM OF ONE ROW OF 5/4" x 3"CROSS BREEDING FOR ALL JOISTS WITH SPANS OVER 12'0", 8' MAX. SPACING OR AS NOTED OTHERWISE ON PLANS.
- 24. FIRE BLOCKING SHALL BE PROVIDED TO CUT OFF ALL CONCEALED DRAFT OPENINGS, VERTICALLY & HORIZONTALLY AND TO FORM AN EFFECTIVE BARRIER BETWEEN STORIES
- AND BETWEEN A TOP STORY AND THE ROOF SPACE. FIRE BLOCKING SHALL BE PROVIDED IN THE FOLLOWING LOCATIONS. A. IN CONCEALED SPACES OF STUD WALLS AND PARTITIONS, INCLUDING FURRED SPACES, AT CEILING & FLOOR LEVELS. CONCEALED HORIZ. FURRED SPACES SHALL ALSO
- BE FIRE BLOCKED AT INTERVALS NOT EXCEEDING 10 FEET B. AT ALL INTERCONNECTIONS BETWEEN CONCEALED VERT. & HORIZ. SPACES SUCH AS
- OCCUR AT SOFFITS, DROPPED CEILINGS AND COVE CEILINGS. C. IN CONCEALED SPACES BET. STAIR STRINGERS AT TOP AND BOTTOM OF THE RUN.
- ENCLOSED SPACES UNDER STAIRS SHALL COMPLY w/ SECTION R311.2.2. D. AT OPENINGS AROUND VENTS, PIPES AND DUCTS AT CEILING AND FLOOR LEVEL, w/ AN APPROVED MATERIAL TO RESIST THE FREE PASSAGE OF FLAME AND PRODUCTS OF COMBUSTION.
- E. FOR THE FIRE BLOCKING OF CHIMNEYS AND FIREPLACES, SEE **SECTION R1001.16.**
- F. FIRE BLOCKING OF CORNICES OF 2-FAMILY DWELLING SEPARATION IS
- 25. PROVIDE DOUBLE FLOOR JOISTS UNDER ALL WALLS PARALLEL TO FRAMING, MAJOR APPLIANCES, BATH FIXTURES, AND AT ALL
- CANTILEVERS, UNLESS NOTED OTHERWISE. 26. PROVIDE A MINIMUM OF DOUBLE JOISTS AT OPENINGS IN FLOORS, CEILINGS. AND ROOFS.

- 27. PROVIDE A MINIMUM OF DOUBLE WALL STUDS AROUND ALL WALL OPENINGS, JACK STUDS UNDER ALL HEADERS, DOUBLE STUDS UNDER ALL HEADERS GREATER THAN 5'-0", TRIPLE STUDS AT ALL CORNERS.
- 28. PROVIDE POSTS AT ALL RIDGE, HIP AND VALLEY INTERSECTIONS DOWN TO A MIN. OF TRIPLE 2x8 CEILING JOISTS.
- 29. PROVIDE LEDGERS, BLOCKING, NAILERS AND ROUGH FRAMING HARDWARE AS REQUIRED.
- 30. SET ALL FRAMING WITH NATURAL CROWN UP.
- 31. FRAME WITH DOUBLE HEADERS AND TRIMMERS AROUND OPENINGS LARGER THAN SPACING BETWEEN JOISTS. STUDS OR RAFTERS. UNLESS LARDER IS SHOWN ON PLANS.
- 32. SOLID BLOCKING SHALL BE PROVIDED UNDER ALL POSTS THAT DO NOT REST DIRECTLY ON JOISTS, CONTINUOUS TO BEARING STRUCTURE OR FOUNDATIONS.
- ALL WOOD POSTS SHALL BE SOLID STUDS, AND TO BE A MINIMUM OF THE WIDTH OF THE BEAM SUPPORTING IT AND PROVIDED WITH MINIMUM ONE KING STUD AT EITHER SIDE.
- 34. BRACE ALL WALLS DURING CONSTRUCTION.
- 35. ALL WALL FRAMING OF 9'0" AND GREATER SHALL HAVE SOLID BLOCKING AT MID HEIGHT OF ALL WALLS
- 36. ALL DOORS, WINDOWS AND OPENINGS SHALL HAVE A MINIMUM HEADER TO BE AS FOLLOWS U.N.O. IN PLANS:
- A. UP TO 5'0"USE (2)2x10 B. UP TO 8'0"USE (3)2x10 OR (2)2x12
- C. OPENINGS GREATER THAN 8'-0", SEE PLANS FOR HEADER SIZES OR AS SPECIFIED BY P.E.
- ALL HEADERS AND BEAMS SHALL BE GLUED AND NAILED AT 6" O.C. AT TOP AND BOTTOM.
- PROVIDE FASTNER NAILS AS FOLLOWS: 10p AT ALL GENERAL FRAMING AND 8p AT ALL PLYWOOD, 4-FT SPACING MAX. - TABLES R602.3(1) THROUGH R602.3(4).
- ALL WOOD FRAMING SUPPORTED BY OTHER WOOD FRAMING MEMBERS AT THE SAME
- ELEVATION (FLUSH) SHALL BE FASTENED BY MEANS OF METAL JOIST HANGERS OF APPROPRIATE SIZE AND LOADING CAPABILITIES. ALL HANGERS, ANCHORS AND CONNECTORS SHALL BE SIMPSON
- STRONG TIE OR EQUAL HURRICANE TIES SHALL BE INSTALLED FROM WALL TO ROOF FRAMING,
- 41. ALL PLYWOOD SUB FLOORING SHALL BE GLUED AND NAILED TO TOP OF
- JOISTS. 42. ROOFING, SIDING, TRIM AND OTHER MATERIALS SHALL BE INSTALLED IN STRICT ACCORDANCE WITH THEIR RESPECTIVE MANUFACTURERS
- SPECIFICATIONS AND INDUSTRY STANDARDS REPLACE EXISTING ROOFING MATERIALS & SHEATHING WHERE
- **COMPROMISED** 44. ALL SKYLIGHTS, METAL FLUES, VENTS, STACKS OR ANY OTHER ROOF ACCESSORIES THAT REQUIRE FLASHING SHALL BE INSTALLED AS PER THE MANUFACTURERS SPECIFICATIONS.
- PROVIDE ADDITIONAL ALUMINUM BLIND FLASHING WHERE REQUIRED TO INSURE WATER TIGHT CONDITIONS.
- INSTALL FLASHING AT ALL ENTRANCE SLABS ADJACENT TO WALL CONSTRUCTION.
- 47. PROVIDE ADEQUATE AIR SPACE BEHIND BRICK, STONE AND OTHER SIDING AS REQUIRED
- 48. ALL FRAMING TO BE ERECTED PLUMB, LEVEL AND TRUE BUILT-UP GIRDERS AND HEADERS SHALL BE FASTENED TOGETHER AS FOLLOWS: FOR UP TO THREE PLIES, USE TWO ROWS OF NAILS STAGGERED
 - AT 12" CENTERS; USE 10D NAILS ON 1 1/2" MEMBERS AND 16D NAILS ON 1 3/4" MEMBERS. b.FOR MORE THAN THREE PLIES, USE TWO ROWS OF 1/2" DIAMETER
- THROUGH BOLTS AT 12" CENTERS STAGGERED. 50. CEILING JOISTS MUST BE LAPPED AGAINST AND ATTACHED DIRECTLY TO RAFTERS WITH THREE 16D COMMON NAILS. DO NOT USE BLOCKING.
- 51. TOE NAIL ALL JOISTS AND RAFTERS TO TOP PLATE OF STUD BEARING WALLS OR PARTITIONS WITH A MINIMUM OF THREE 16D COMMON NAILS. 52. PRECAUTIONS SHALL BE TAKEN TO MINIMIZE AIR BORNE SAW DUST CREATED FROM CUTTING CCA TREATED MEMBERS. DUST MASKS SHALL
- MEMBER ARE BEING CUT. PROVIDE MINIMUM 3 1/2" DEEP BEARING FULL WIDTH OF HEADERS AND **GIRDERS**

BE WORN BY ANYONE IN THE IMMEDIATE AREA WHERE TREATED

- 54. NOTCHING OF MEMBER ARE NOT PERMITTED. THIS APPLIES TO ALL FRAMING MEMBERS, TRUSSES AND STRUCTURAL LUMBER.
- 55. CEILING JOISTS SHALL BE CONNECTED TO EACH OTHER TO CREATE CONTINUOUS MEMBERS TO TIE OPPOSITE ROOF RAFTERS TOGETHER. 56. COLLAR TIES SHALL BE ONE CONTINUOUS MEMBERS TO TIE OPPOSITE
- ROOF RAFTERS TOGETHER. 57. INSTALL ALL COLLAR TIES AND CEILING JOISTS SIMULTANEOUSLY WITH ROOF RAFTERS.

DOOR & WINDOW NOTES:

- ALL WINDOWS & EXTERIOR DOORS SHALL COMPLY WITH THE NEW YORK STATE ENERGY CONSERVATION CONSTRUCTION CODE.
- ALL DOORS SHALL CONFORM TO THE STATE CODE SIZE REQUIREMENTS WHERE PROVIDED WINDOW SCHEDULE IS FOR DESIGN INTENT ONLY. THE CONTRACTOR SHALL VERIFY WITH OWNER ALL WINDOWS, DOOR, AND ADDITIONAL OPTIONS SUCH AS COLOR AND HARDWARE PRIOR TO
- REFER TO WINDOW AND DOOR SCHEDULES, WHERE PROVIDED. WHERE WINDOWS AND DOOR SIZES ARE SPECIFIED IN PLAN. REFER TO CONSTRUCTION LEGEND FOR ADDITIONAL DATA
- PER NYS RESIDENTIAL CODE R703.8 FLASHING, CORROSION-RESISTANT FLASHING SHALL BE PROVIDED AT THE FOLLOWING LOCATIONS: A. EXTERIOR WINDOW AND DOOR OPENINGS, THRESHOLD/SILL & HEADER, B. AT THE ROOF & SIDING INTERSECTIONS
- C. UNDER AND AT THE ENDS OF MASONRY, WOOD OR METAL COPINGS & SILLS AND
- D. CONTINUOUSLY ABOVE ALL PROJECTING WOOD TRIM. WINDOW & DOOR FLASHING SHALL BE DUPONT STRAIGHT & FLEX-WRAP & INSTALLED PER MANUFACTURER'S SPECIFICATIONS & AS INDICATED
- HEREIN A. INSTALL CONTINUOUS FLEX-WRAP SILL FLASHING OVER HOUSE WRAP,
- B. INSTALL CONTINUOUS JAMB STRAIGHT FLASH OVER WINDOW FLANGES or OVER JAMB FOR REPLACEMENT WINDOWS & DOORS; EXTEND MINIMUM 2" ABOVE HEAD FLANGE & TO BELOW SILL FLASHING C. INSTALL HEADER FLASHING BELOW WEATHER BARRIER, DIRECTLY
- ADHERED TO SHEATHING D. LAP WEATHER BARRIER OVER HEAD FLASHING, SKIP TAPE OVER
- FLASHING, FULLY TAPE DIAGONAL CUTS ALL WINDOWS AND DOORS SHALL BE INSTALLED IN STRICT ACCORDANCE WITH THEIR PARTICULAR MANUFACTURER'S SPECIFICATIONS.
- CONTRACTOR SHALL VERIFY ALL WINDOW AND DOOR ROUGH OPENINGS WITH THE MANUFACTURER
- ALL WINDOWS IN HABITABLE SPACES SHALL COMPLY WITH THE NYS RESIDENTIAL CODE EGRESS REQUIREMENTS, INCLUDING
 - -CLEAR OPENABLE AREA OF 5.7 SF FOR ROOMS ABOVE GRADE -CLEAR OPENABLE AREA OF 5.0 SF FOR ROOMS AT GRADE -CLEAR OPEN WIDTH OF 20"
 - -CLEAR OPEN HEIGHT OF 24" -SILL HEIGHT 44" MAX. A.F.F.

DRYWALL NOTES:

COMPANY.

WALLS, U.N.O.

CLEANING:

OPERATIONS.

OCCUPANCY.

APPROVED MANUFACTURER.

BELOW OCCUPIED RESIDENCE.

RESISTANT MATERIALS.

- ALL EGRESS BASEMENT WINDOWS THAT ARE BELOW THE FINISHED GRADE SHALL BE PROVIDED WITH AN APPROVED WINDOW WELL AND DRAINAGE AS PER NYS AND LOCAL BUILDING CODES.
- ALL GLAZING LESS THAN 18" ABOVE THE FINISHED FLOOR/SURFACE AND ALL GLASS TUB AND/OR SHOWER ENCLOSURES SHALL BE TEMPERED. 12. ALL FIXED GLASS SHALL BE IN FRAMES TO MATCH THE MANUFACTURER
- OF OPERABLE WINDOWS. ALL WINDOWS SHALL BE MANUFACTURED BY ANDERSEN OR EQUAL UNLESS SHOWN OTHERWISE. ALL EXTERIOR SWING DOORS SHALL BE
- MANUFACTURED BY THURMA-TRU OR EQUAL, U.N.O. 14. ALL WINDOW AND DOOR JAMBS TO BE FOAM SEALED & WEATHER-STRIPPED ON EXTERIOR PER THE 2016 NEW YORK STATE ENERGY
- CONSERVATION CONSTRUCTION CODE (C103.2.2). ALL DOOR HARDWARE TO MATCH EXISTING; GC TO PURCHASE HARDWARE AS APPROVED BY HOMEOWNER

BUTT JOINTS IN WALL SHALL BE PERMITTED.

- CLOSET HARDWARE TO BE MAGNETIC CLOSURE. MATCH EXIST./NEW HARDWARE AS APPLICABLE, U.N.O. DOORS TO MECHANICAL CLOSET/ROOM & DOORS SEPARATING GARAGE
- 18. ATTIC SCUTTLE/STAIR OPENINGS TO BE INSTALLED, WEATHER-STRIPPED AND INSULATED EQUAL TO THE R-VALUE OF INSULATION INSTALLED IN THE SURROUNDING FRAMING.

ALL CORNERS AND JOINTS SHALL RECEIVE TWO COATS OF JOINT

COMPOUND FEATHERED SMOOTH AND ALL DIMPLES CREATED BY

ALL GYPSUM BOARD SHALL BE IN ACCORDANCE WITH THE GYPSUM

FROM DWELLING UNIT SHALL BE 3/4-HOUR FIRE RATED. SELF-CLOSING

ALL GYPSUM BOARD CUT JOINTS SHALL BE ADJACENT TO CORNERS. NO

FASTENERS SHALL RECEIVE 3 COATS OF JOINT COMPOUND FEATHERED

CONSTRUCTION HANDBOOK, PUBLISHED BY THE UNITED STATES GYPSUM

ALL MATERIALS SHALL BE FURNISHED BY THE UNITED STATES GYPSUM

COMPANY, NATIONAL GYPSUM COMPANY, CELOTEX CORP., OR OTHER

ALL BEADS, STOPS AND TRIM SHALL BE MANUFACTURED FROM RUST

INSTALL MINIMUM 1/2" GYPSUM BOARD NAILED AND SCREWED AT ALL

INSTALL MINIMUM 5/8" NAILED AND SCREWED AT ALL CEILINGS, U.N.O.

INSTALL WATERPROOF GYPSUM BOARD OR CEMENTITIOUS BACKER

OTHER BATHROOM, KITCHEN, LAUNDRY AND MUDD ROOM WALLS &

INCLUDING SUBSTRATE FOR KITCHEN BACKSPLASH.

BE 5/8" TYPE 'X' GYPSUM BOARD, TAPED & SPACKLED.

MAINTAIN PREMISES AND PUBLIC PROPERTIES FREE FROM

ACCUMULATIONS OF WASTE, DEBRIS AND RUBBISH CAUSED Y

BOARD AT ALL TUBS, SHOWER SURROUNDS AND OTHER WET LOCATIONS,

INSTALL MOLD, MILDEW & MOISTURE RESISTANT GYPSUM BOARD AT ALL

INSTALL 5/8" TYPE 'X' GYPSUM BOARD AT BOTH SIDES OF GARAGE BEARING

WALLS, WALLS ADJACENT TO OCCUPIED RESIDENCE & GARAGE CEILING

INSTALL 5/8" TYPE 'X' GYPSUM BOARD AT CEILING ABOVE GAS-FIRED &

FOOTPRINT OF EQUIPMENT LOCATION. WHERE GAS-FIRED MECHANICAL

EQUIPMENT IS ENCLOSED, ALL INTERIOR WALL & CEILING FINISHES SHALL

AT COMPLETION OF WORK, REMOVE WASTE MATERIALS, RUBBISH, TOOLS,

EQUIPMENT, MACHINERY AND SURPLUS MATERIALS, AND CLEAN ALL SIGHT EXPOSED SURFACES; LEAVE PROJECT CLEAN AND READY FOR

COMBUSTION EQUIPMENT FOR MINIMUM OF 36" DIAMETER BEYOND

- ALL STAIRS AND RAILINGS SHALL COMPLY WITH THE NYS RESIDENTIAL CODE ALL STAIRWAYS SHALL NOT BE LESS THAN 36-INCH CLEAR WIDTH AT ALL POINTS ABOVE
- THE PERMITTED HANDRAIL HEIGHT AND BELOW THE REQUIRED HEADROOM HEIGHT. ONE (1) CONTINUOUS HANDRAIL SHALL BE INSTALLED AT ALL STAIRWAYS WITH TWO (2) STEPS OR MORE.
- HANDRAILS SHALL NOT PROJECT INTO THE STAIRWAY MORE THAN 4-INCHES, ALLOWING FOR A MIN. CLEAR WIDTH OF 27-INCHES WHERE TWO HANDRAILS ARE INSTALLED AND 31-INCHES WHERE ONE HANDRAIL IS INSTALLED. MAINTAIN MINIMUM CLEARANCE OF 1-
- 1/2" BETWEEN ALL HANDRAILS & PARALLEL WALL SURFACE. THE MINIMUM HEADROOM IN ALL PARTS OF STAIRWAYS SHALL NOT BE LESS THAN 6'-8 MEASURED VERTICALLY FROM THE SLOPED PLANE ADJOINING THE TREAD NOSINGS OR FROM THE FLOOR SURFACE OF THE LANDING OR PLATFORM
- ENCLOSED ACCESSIBLE SPACE UNDER STAIRS SHALL HAVE WALLS, UNDER STAIR SURFACE AND SOFFITS PROTECTED ON THE ENCLOSED SIDE WITH MIN. 1/2" GYPSUM BOARD.
- THE MAXIMUM RISER HEIGHT IS 8.25" THE GREATEST RISER HEIGHT SHALL NOT EXCEED THE SMALLEST BY MORE THAN 3/8"
- THE MINIMUM TREAD DEPTH IS 9". THE GREATEST TREAD DEPTH SHALL NOT EXCEED TH
- E SMALLEST BY MORE THAN 3/8".
- A NOSING NOT LESS THAN 3/4" AND NOT GREATER THAN 1" SHALL BE PROVIDED ON STAIRWAYS WITH SOLID
- RISERS. THE GREATEST NOSING PROJECTION SHALL NOT EXCEED THE SMALLEST BY MORE THAN 1/4".
- OPEN RISERS ARE PERMITTED, PROVIDED THAT THE OPENING BETWEEN TREADS DOES NOT PERMIT THE PASSAGE OF A 4" DIAMETER SPHERE.
- HANDRAIL HEIGHT SHALL BE A MINIMUM OF 34" AND MAXIMUM OF 38" ABOVE THE SURFA 12. GUARDS SHALL BE PROVIDED WHERE THE HEIGHT OF A SURFACE IS GREATER THAN 30"
- ABOVE AN ADJACENT SURFACE. GUARDS SHALL BE A MINIMUM HEIGHT OF 36" ABOVE THE SURFACE BELOW. IF DECK OR PLATFORMS ARE 8'0" OR GREATER ABOVE THE ADJ. FINISHED GRADE OR SURFACE THAN THE GUARD
- S SHALL BE 42" IN HEIGHT.
- 13. OPENINGS IN RAILINGS AND GUARDS SHALL BE LESS THAN 4".

CLOSET & CABINET NOTES

STAIRS & RAILING NOTES:

- ALL CLOSETS SHALL HAVE AS A MINIMUM OF ONE (1), WHITE, MDF SHELF AND ONE (1) WOOD ROD FOR HANGING CLOTHING. PROVIDE FIVE (5), WHITE, MDF SHELVES IN LINEN CLOSETS.
- THE CONTRACTOR SHALL DOUBLE CHECK AND VERIFY ALL AS BUIL1 DIMENSIONS AND CONDITIONS PRIOR OF ORDERING CABINETS, COUNTER
- TOPS AND VANITIES ALL EXPOSED BASE CABINET SIDES SHALL HAVE TOE KICK SPACE, U.N.O.

PAINTING NOTES:

- DISTURBED/NEW WALLS SHALL BE TAPED, SPACKLED & PRIMED BY GC
- ALL INTERIOR GYPSUM BOARDS, WALLS AND CEILINGS, SHALL RECEIVE ONE COAT PRIMER AND TWO COATS OF PAINT
- ALL PAINT SHALL BE BENJAMIN MOORE, OR APPROVED EQUAL. WALLS AND CEILINGS OF BATHROOMS, KITCHEN (*) AND LAUNDRY ROOMS SHALL
- SHALL PROVIDE PAINT SPECIFICATIONS FOR ALL SURFACES. ALL DOORS & TRIM SHALL BE PAINTED SEMI-GLOSS, U.N.O.
- ALL OTHER WALLS SHALL BE PAINTED EGGSHELL, U.N.O. ALL INTERIOR WOOD. TRIM. SHELVING AND OAK FLOORS SHALL BE FINISHED AS SCHEDULED OR AS DIRECTED BY GENERAL CONTRACTOR & APPROVED BY

BE PAINTED SEMI-GLOSS.(*) WHERE OPEN KITCHEN PLANS APPLY, ARCHITECT

- ARCHITECT & HOMEOWNER.
- ALL INTERIOR DOORS, TRIM AND EXPOSED WOOD SHALL BE SANDED COMPLETELY SMOOTH PRIOR TO APPLYING FINISH.
- ALL EXPOSED FERROUS METAL SHALL BE PAINTED WITH A RUST INHIBITOR AND

TWO COATS OF ENAMEL

DEMOLITION NOTES:

- EXTREME CAUTION SHALL BE TAKEN DURING DEMOLITION OF EXISTING BUILDINGS. THE CONTRACTOR SHALL OBSERVE ANY VARIATIONS AND/OR ANY UNFORESEEN DISCREPANCIES WITH THE PLANS, AND SHOULD REPORT IMMEDIATELY TO THE ARCHITECT.
- THE CONTRACTOR SHALL BE RESPONSIBLE FOR ALL SHORING, BRACING AND ALL TEMPORARY SUPPORTS PRIOR OF REMOVING THE EXISTING WALLS, CEILINGS, FLOORS AND ROOFS AS PER ALL LOCAL AND OSHA REGULATIONS. THE CONTRACTOR SHALL PROVIDE WEATHERPROOFING AT THE END OF EACH
- WORK DAY AS REQUIRED TO PREVENT WEATHER DAMAGE. THE ARCHITECT IS NOT RESPONSIBLE FOR FROZEN PIPES AND/OR MOLD

CONDITIONS CREATED BY THE CONTRACTORS NEGLIGENCE

- BACKFILL SHALL NOT BE PLACED UNTIL THE MAIN FLOOR SYSTEM AND BASEMENT CONCRETE INTERIOR FLOOR SLABS ARE INSTALLED, AS APPLIES TO NEW CONSTRUCTION OR ADDITIONS.
- GC TO TERMINATE OR REROUTE EXISTING HVAC, ELECTRICAL & PLUMBING SYSTEMS PER PLANS AND AS IMPACTED BY DEMOLITION AND NEW CONSTRUCTION.
- GC TO CAP ALL MECHANICAL, ELECTRICAL & PLUMBING SERVICES UPON REMOVAL OF FIXTURES.
- GC SHALL REMOVE WIRING BACK TO EXISTING ELECTRICAL PANEL WHERE SERVICES ARE TERMINATED.

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\06.23.21 PLAN. BD. COMMENT REV.


07.19.21 PLAN. BD. COMMENT REV.2


General Notes


date

21.05 project: KJC drawn by: checked by: 03/02/21


AS NOTED

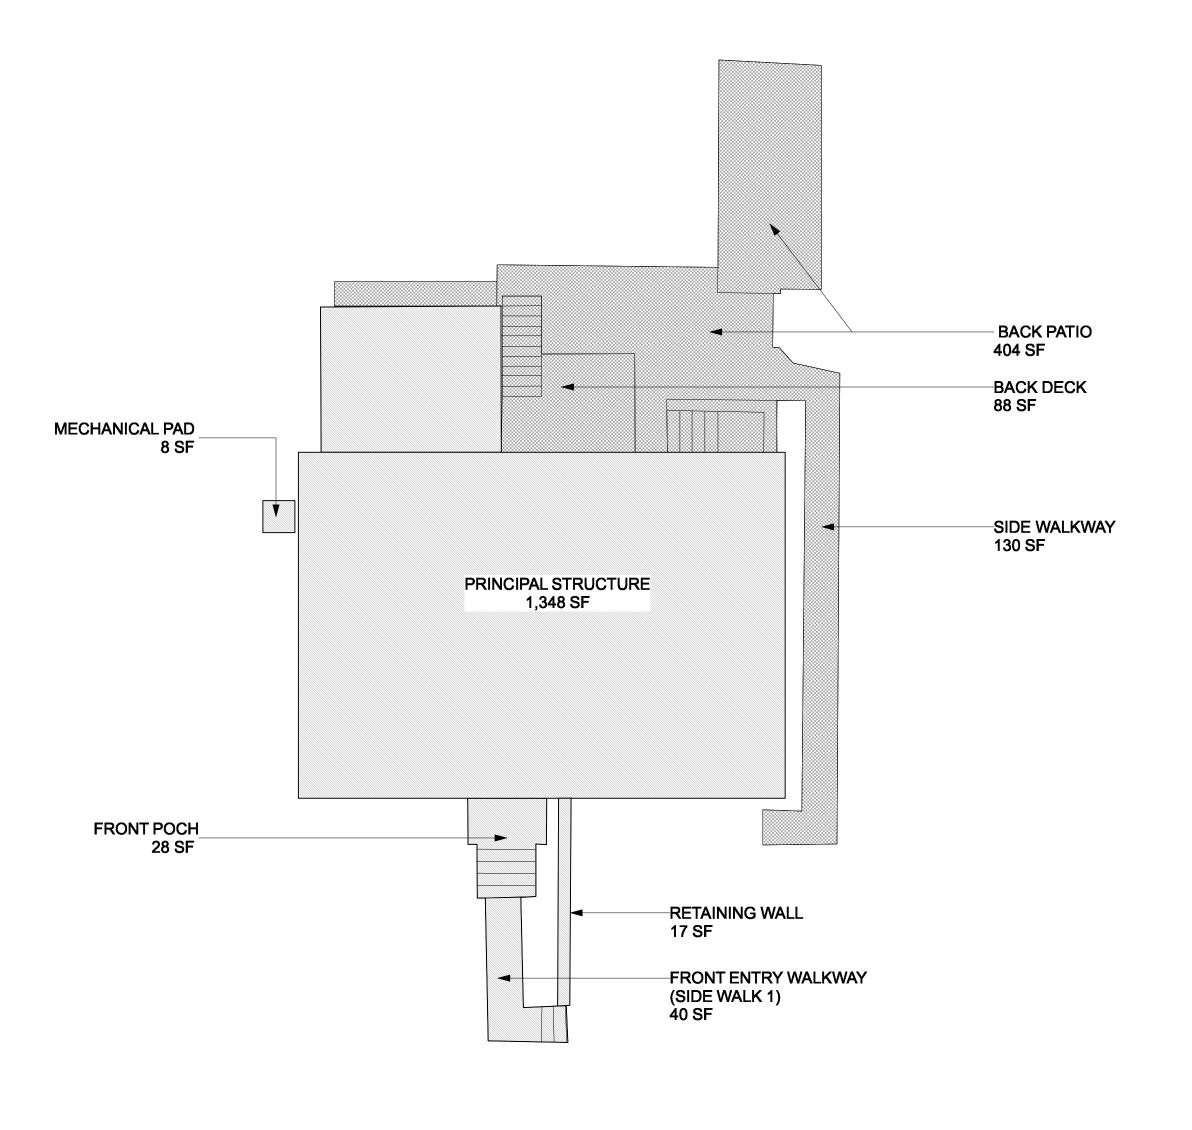

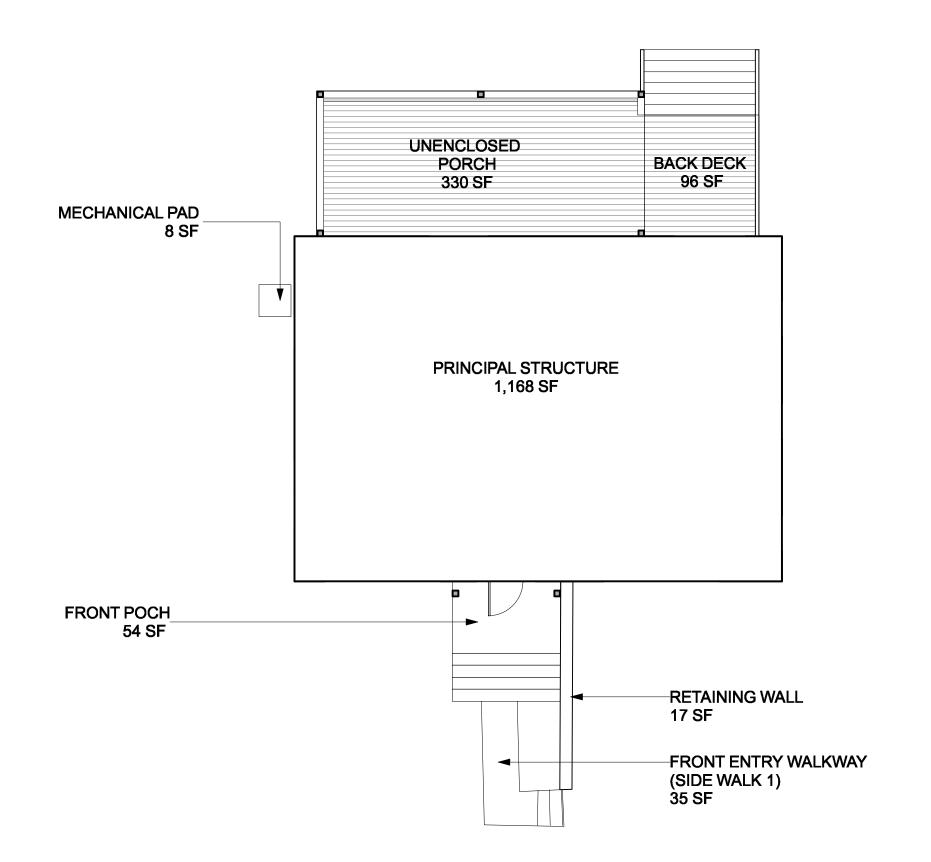

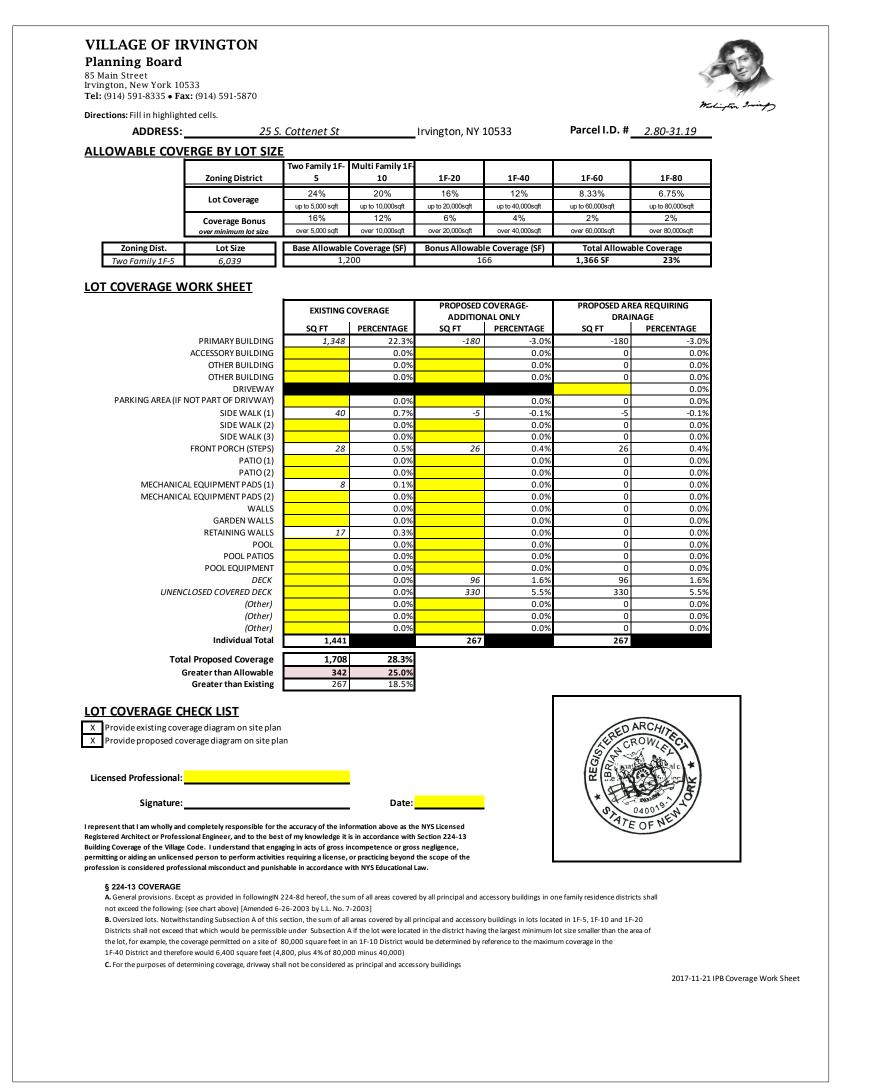


EXISTING SITE COVERAGE DIAGRAM Scale: 1/8" = 1'-0"

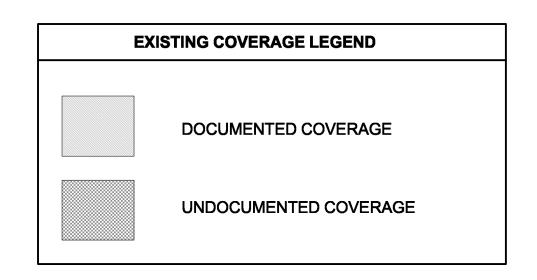

| EXISTING DOCUMENTED CO | VERAGE | EXISTING UNDOCUM | MENTED COVERAGE | PROPOSED COVERAGE | |
|-------------------------------|----------|------------------|-----------------|-----------------------|----------|
| HOUSE STRUCTURE | 1,348 SF | SIDE WALKWAY | 130 SF | HOUSE STRUCTURE | 1,168 SF |
| FRONT ENTRY WALKWAY | 40 SF | BACK PATIO | 404 SF | FRONT ENTRY WALKWAY | 35 SF |
| FRONT PORCH | 28 SF | BACK DECK | 88 SF | FRONT PORCH | 54 SF |
| MECHANICAL EQUIP. PAD | 8 SF | | | MECHANICAL EQUIP. PAD | 8 SF |
| RETAINING WALL | 17 SF | | | RETAINING WALL | 17 SF |
| TOTAL | 1 441 85 | TOTAL | 622 SF - | UNCOVERED PORCH | 330 SF |
| TOTAL | 1,441 SF | IOIAL | 022 SF | BACK DECK | 96 SF |
| | | | | TOTAL | 4 700 05 |
| | | | | TOTAL | 1,708 SF |

PROPOSED SITE COVERAGE DIAGRAM Scale: 1/8" = 1'-0"

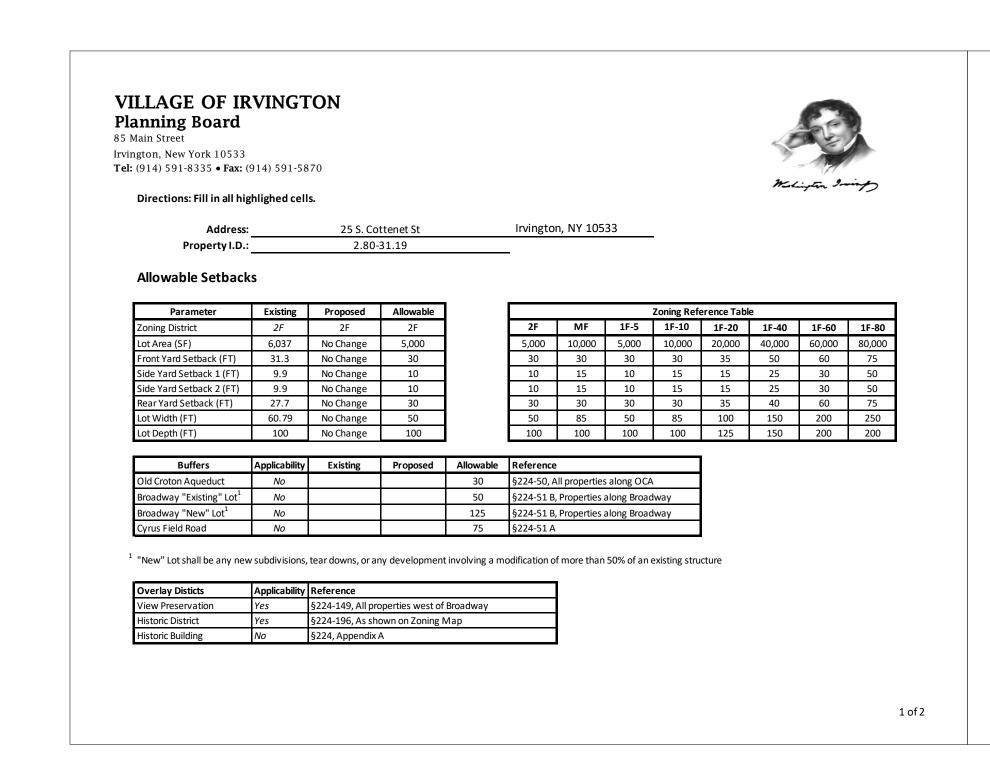

IRVINGTON ZONING WORKSHEET (CONT.) Allowable Height (8224.2)

| Allowable Heigh | t (§224-3) | | |
|------------------------------|------------|-----------|--------------------------|
| Parameter | Existing | Proposed | Allowable |
| Stories | 2 | No Change | 2.5 |
| HP Elevation ¹ | 98.65 | 99.9 | 101.9 |
| MP Elevation ² | 66.9 | 66.9 | 66.9 |
| Height (HP-MP) | 31.75 | 33 | 35 (or 40 ³) |
| Height from AFG ⁴ | N/A | N/A | 35 |

¹ HP - Highest Point of the surface of the roof, except as noted in §224-3 Height A (2).

² MP - Measuring Point, the lowest point at the foot of any portion of the building of the lower of: (a) the finished grade; and (b) the grade prior to

construction, filling or grading. §224-3 Height B (2). ³ If building envelope grade criteria are met, §224-3. Height B.(3), 40-feet may be used.

⁴ Only apply if building envelope grade criteria are met, §224-3. Height B.(3), Height from Average Existing Grade (AEG). See Below.

Average Existing Grade, §224-3.Height B.(3)

Note: Business District see 224-3 Height B. (1). Exception in accordance with 224-3 Height B (3), below.

| Parameter | Value | Unit | Notes |
|---|-------|------|--------------------------|
| Area within Building Envelope (BE) | N/A | sf | |
| Area of envelope with Steep Slopes ≥15% (SS) | N/A | sf | Provide Slope Diagram |
| Percent of SS (BE÷SS x 100) | N/A | % | Must be ≥50% |
| Is roof pitch for 80% of roof a min. of 5" on 12"? | N/A | | Provide Roof Sketch |
| Average Existing Grade (AEG) Elevation at Periphery of Building | N/A | ft | Provide AEG Calculations |
| Critaria Satisfieda | NI/A | | |

I represent that I am wholly and completely responsible for the accuracy of the information above as the NYS Licensed Registered Architect or Professional Engineer, and to the best of my knowledge it is in accordance with Section 224 of the Village Code. I understand that engaging in acts of gross incompetence or gross negligence, permitting or aiding an unlicensed person to perform activities requiring a license, or practicing

beyond the scope of the profession is considered professional misconduct and punishable in accordance with NYS Educational Law.



2 of 2

date:

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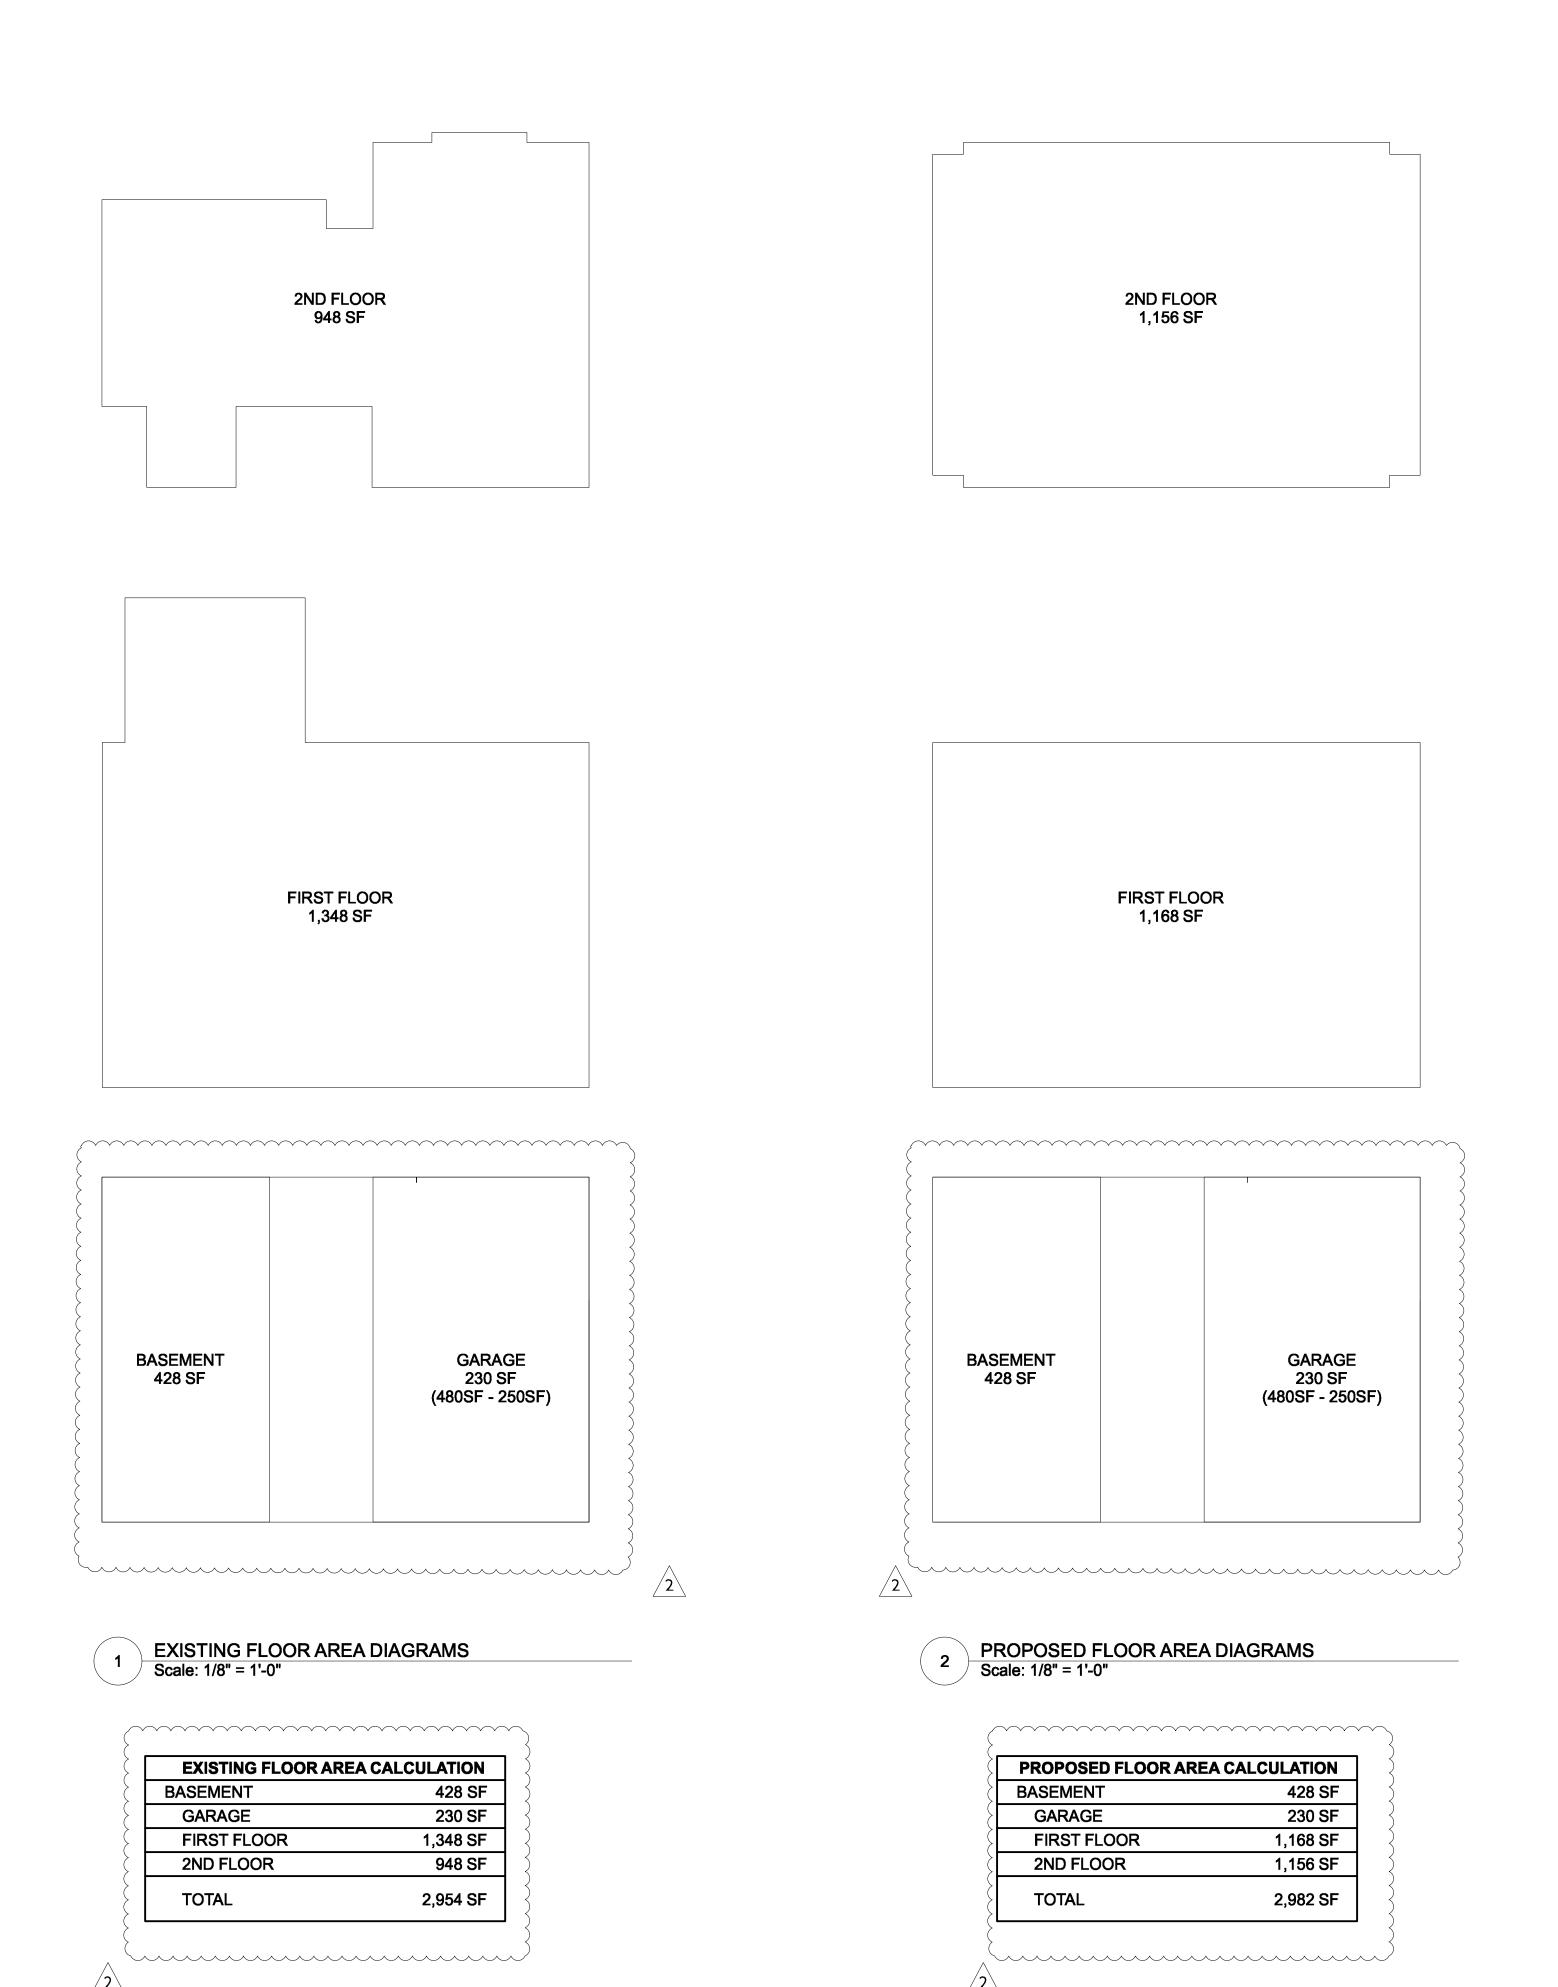
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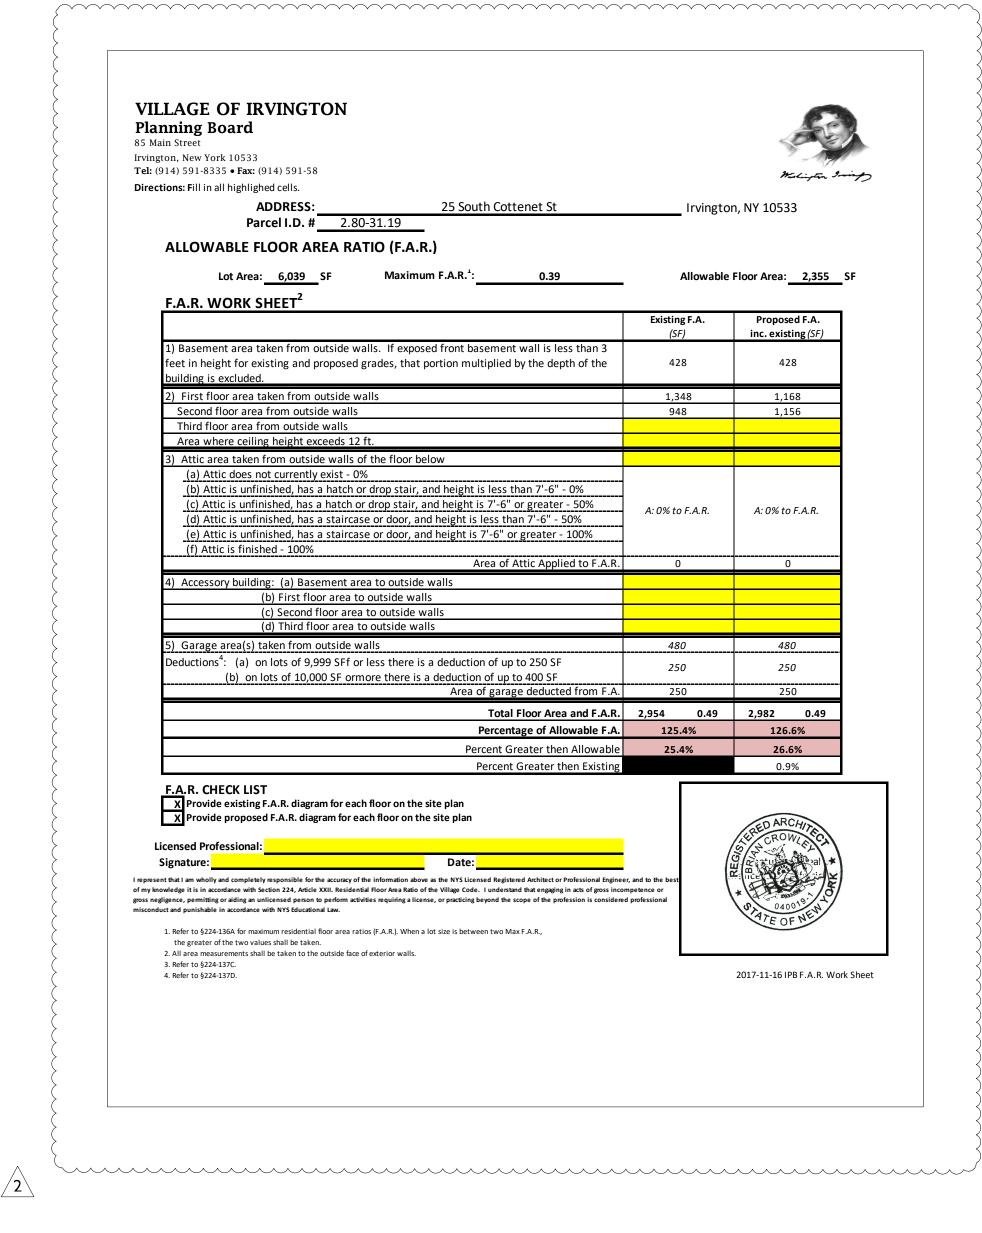
05.13.21 SITE DEVELOPMENT

| \06.23.21 PLAN. BD. COMMENT REV. 2\07.19.21 PLAN. BD. COMMENT REV.2

Site Coverage **Analysis**


21.05 KJC drawn by: checked by: 03/02/21 1/8" = 1'-0"





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REMODEL & ADDITION
POOR RESIDENCE

| # | date | issue | |
|---|------|-------|--|
| | | | |

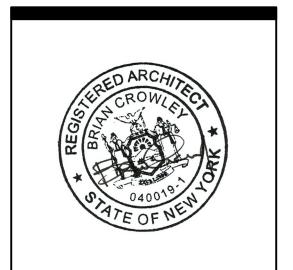06.23.21 PLAN. BD. COMMENT REV.

 $^{\prime}2$ \setminus 07.19.21 PLAN. BD. COMMENT REV.2


Floor Area

Analysis

| project: | 21.05 |
|-------------|----------|
| drawn by: | KJC |
| checked by: | |
| date: | 03/02/21 |
| scale: | AS NOTED |

Δ-04

SURROUNDING CONTEXT PHOTOGRAPHS

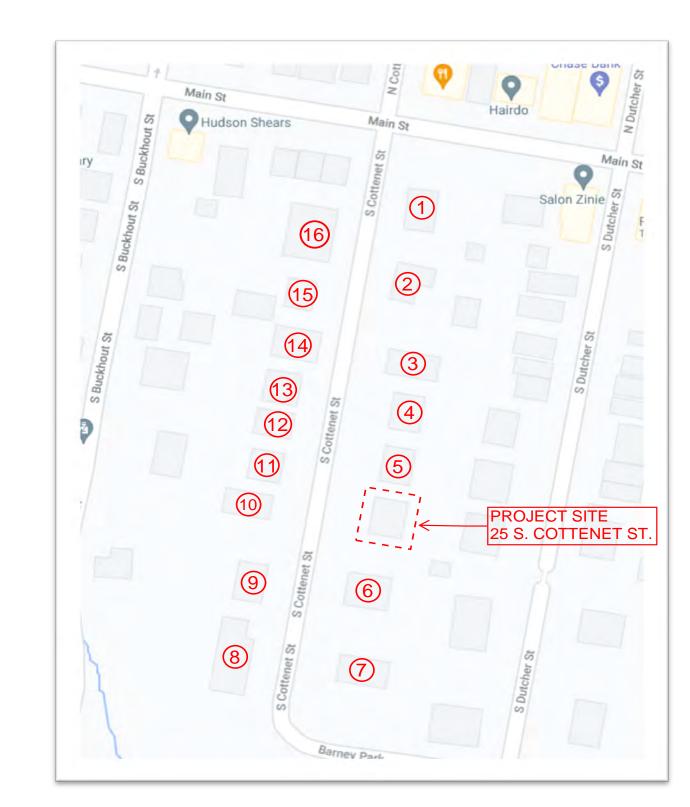

<u>Map Key</u>

Image # - refer to following pages







25 S. Cottenet Street - Rear View





<u>Image #2 - 11 South Cottenet Street</u>



Image #3 - 19 South Cottenet Street



Image #4 - 21 South Cottenet Street



<u>Image #5 - 23 South Cottenet Street</u>



<u>Image #6 - 37 South Cottenet Street</u>

| # | Zoning District | Lot Informatio | n | | FAR | | | | Coverage | | | | Stories | | |
|-----|-----------------|----------------|--------|----------------------|---------|----------|-----------|----------|----------|----------|-----------|----------|---------|----------|-----------------------------|
| | | Parcel ID | Area | Address | Allowed | Existing | % Allowed | % of Lot | Allowed | Existing | % Allowed | % of Lot | Allowed | Existing | Remarks |
| *** | 2F | 2.80-31-19 | 6,039 | 25 South Cottenet St | 2,355 | 2954 | 125% | 49% | 1,366 | 1441 | 105% | 24% | 2 1/2 | 2 | Single Family Residence |
| | | | | | | Proposed | % Allowed | % of Lot | | Proposed | % Allowed | % of Lot | | Proposed | |
| | | | | | | 2982 | 127% | 49% | | 1708 | 125% | 28% | | 2 | |
| 1 | 2F | 2.80-31-14 | 10,019 | 9 South Cottenet St | 2,805 | 2,487 | 89% | 43% | 2003 | 2323 | 116% | 23% | 2 1/2 | 2 | Two-family residence |
| 2 | 2F | 2.80-31-15 | 10,019 | 11 South Cottenet St | 2,805 | 2598 | 93% | 26% | 2003 | 1,559 | 78% | 15.50% | 2 1/2 | 2 | Single Family Residence |
| 3 | 2F | 2.80-31-16 | 3,920 | 19 South Cottenet St | 1,686 | 1600 | 95% | 41% | 1376 | 1510 | 110% | 38.50% | 2 1/2 | 2 | Single Family Residence |
| 4 | 2F | 2.80-31-17 | 6,098 | 21 South Cottenet St | 2,378 | 1736 | 73% | 28% | 1375 | 1316 | 96% | 21.50% | 2 1/2 | 1 | Single Family Residence |
| 5 | 2F | 2.80-31-18 | 6,098 | 23 South Cottenet St | 2,378 | 2296 | 97% | 38% | 1375 | 1695 | 123% | 28% | 2 1/2 | 1 | Single Family Residence |
| 6 | 1F-10 | 2.80-31-20 | 11,326 | 37 South Cottenet St | 3,086 | 3325 | 108% | 28% | 2159 | 2375 | 110% | 21% | 2 1/2 | 2 | Single Family Residence |
| 7 | 1F-10 | 2.80-31-1 | 10,019 | 20 Barney Park | 2,805 | 3221 | 115% | 32% | 2002 | 1886 | 94% | 19% | 2 1/2 | 2 1/2 | Single Family Residence |
| 8 | 1F-10 | 2.80-30-2 | 15,246 | 26 Barney Park | 3,697 | 3480 | 94% | 23% | 2629 | 2972 | 113% | 19% | 2 1/2 | 2 1/2 | Single Family Residence |
| 9 | 1F-10 | 2.80-30-3 | 16,553 | 40 South Cottenet St | 3,890 | 2560 | 66% | 15% | 2786 | 2923 | 105% | 18% | 2 1/2 | 2 1/2 | Single Family Residence |
| 10 | 2F | 2.80-30-4 | 5,227 | 34 South Cottenet St | 2,248 | 2286 | 102% | 44% | 1236 | 2445 | 198% | 43% | 2 1/2 | 2 | Single Family Residence |
| 11 | 2F | 2.80-30-5 | 4,356 | 32 South Cottenet St | 1,873 | 1409 | 75% | 32% | 1045 | 1739 | 166% | 40% | 2 1/2 | 2 | Single Family Residence |
| 12 | 2F | 2.80-30-6 | 4,356 | 30 South Cottenet St | 1,873 | 1510 | 80% | 35% | 1045 | 1057 | 101% | 24% | 2 1/2 | 2 | Single Family Residence |
| 13 | 2F | 2.80-30-7 | 4,356 | 28 South Cottenet St | 1,873 | 1945 | 104% | 45% | 1045 | 1695 | 162% | 39% | 2 1/2 | 2 | Single Family Residence |
| 14 | 2F | 2.80-30-8 | 4,792 | 18 South Cottenet St | 2,061 | 3512 | 170% | 73% | 1150 | 2448 | 195% | 51% | 2 1/2 | 2 1/2 | Single Family Residence |
| 15 | 2F | 2.80-30-9 | 5,663 | 16 South Cottenet St | 2,435 | 1500 | 62% | 26% | 1306 | 2500 | 192% | 44% | 2 1/2 | 2 | Single Family Residence |
| 16 | M | 2.80-30-10 | 8,712 | 10 South Cottenet St | 2,875 | 6741 | 234% | 77% | 1742 | 3466 | 199% | 40% | 2 1/2 | 2 1/2 | Apartments, Condos & Co-ops |

- Calculations are based on numbers collected from the Town of Greenburgh, NY GIS information system and property cards. 25% of total building footprint has been added to account for walks, retaining walls, and miscellaneous hardscapes for coveage. Floor Area Ratio (FAR) has been estimated as per section 224-136 and 224-137. 6 properties are over 100% FAR allowable, and of those 6 properties, 2 properties are over 120% of the allowable.
- 13 properties are over 100% coverage allowable, and of those 13 properties, 7 properties are over 120% of the allowable. Covergaes above for subject property only identify "documented covergaes". Please see sheet A-0.3 for additinal information as it relates to "undocumented" covergaes.



<u>Image #7 - 20 Barney Park</u>



<u>Image #8 - 26 Barney Park</u>





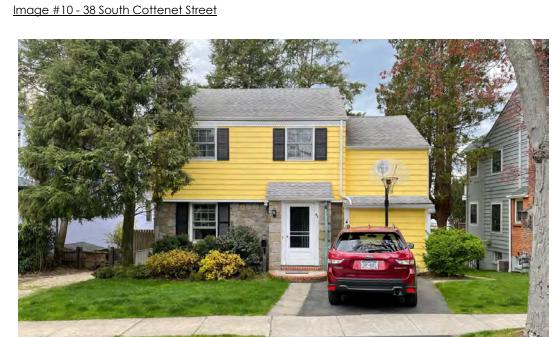


Image #11 - 32 South Cottenet Street



Image #12 - 30 South Cottenet Street



<u>Image #13 - 28 South Cottenet Street</u>




<u>Image #14 - 18 South Cottenet Street</u>





Image #16 - 10 South Cottenet Street



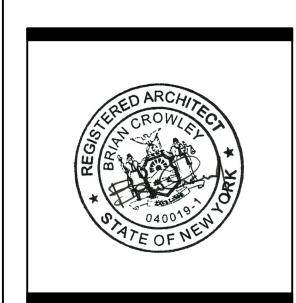


ADDITION SIDENCE

 $| \ 06.23.21$ PLAN. BD. COMMENT REV.

 $_2$ \07.19.21 PLAN. BD. COMMENT REV.2


Property Analysis

| project: | 21.05 |
|-------------|----------|
| drawn by: | KJC |
| checked by: | |
| date: | 03/02/21 |
| scale: | AS NOTED |

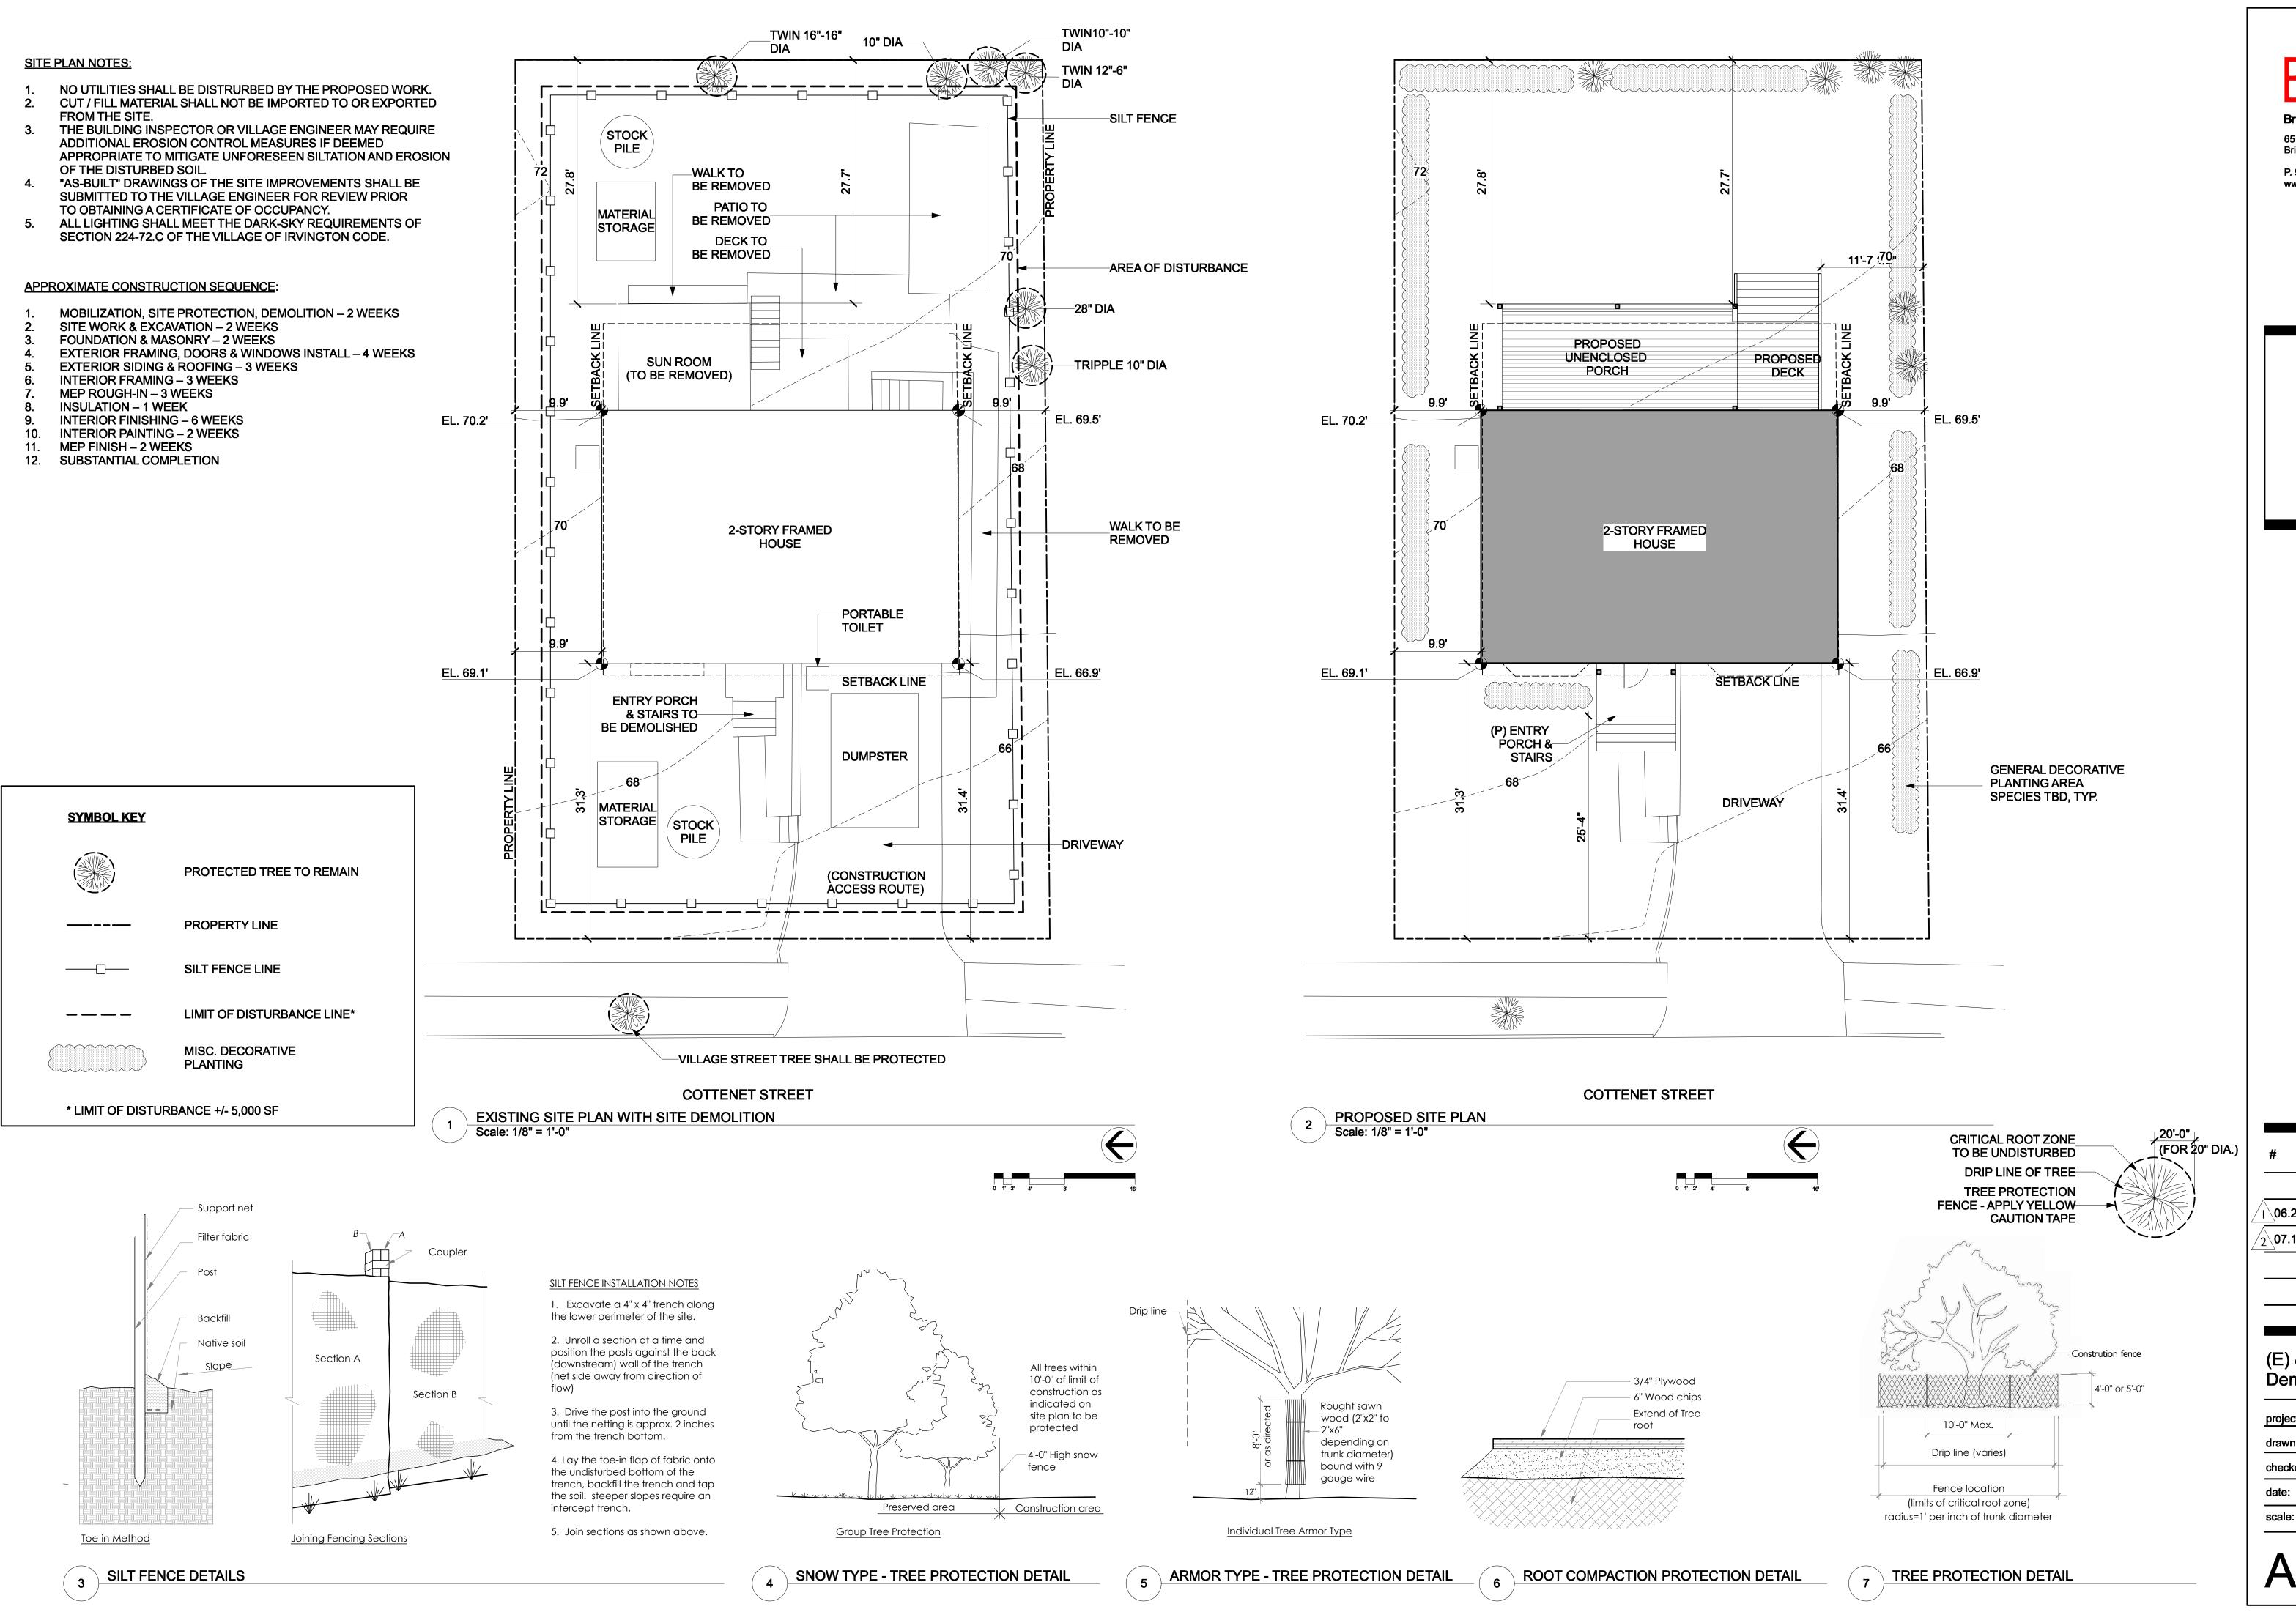

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REMODEL & ADDITION
POOR RESIDENCE

06.23.21 PLAN. BD. COMMENT REV

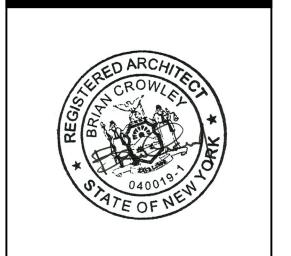207.19.21 PLAN. BD. COMMENT REV.2

(E) & (P) Site Plans /

Demo Plan & Landscape

project: 21.05


drawn by: KJC

checked by:


date: 03/02/21

1/8" = 1'-0"


A-1.1

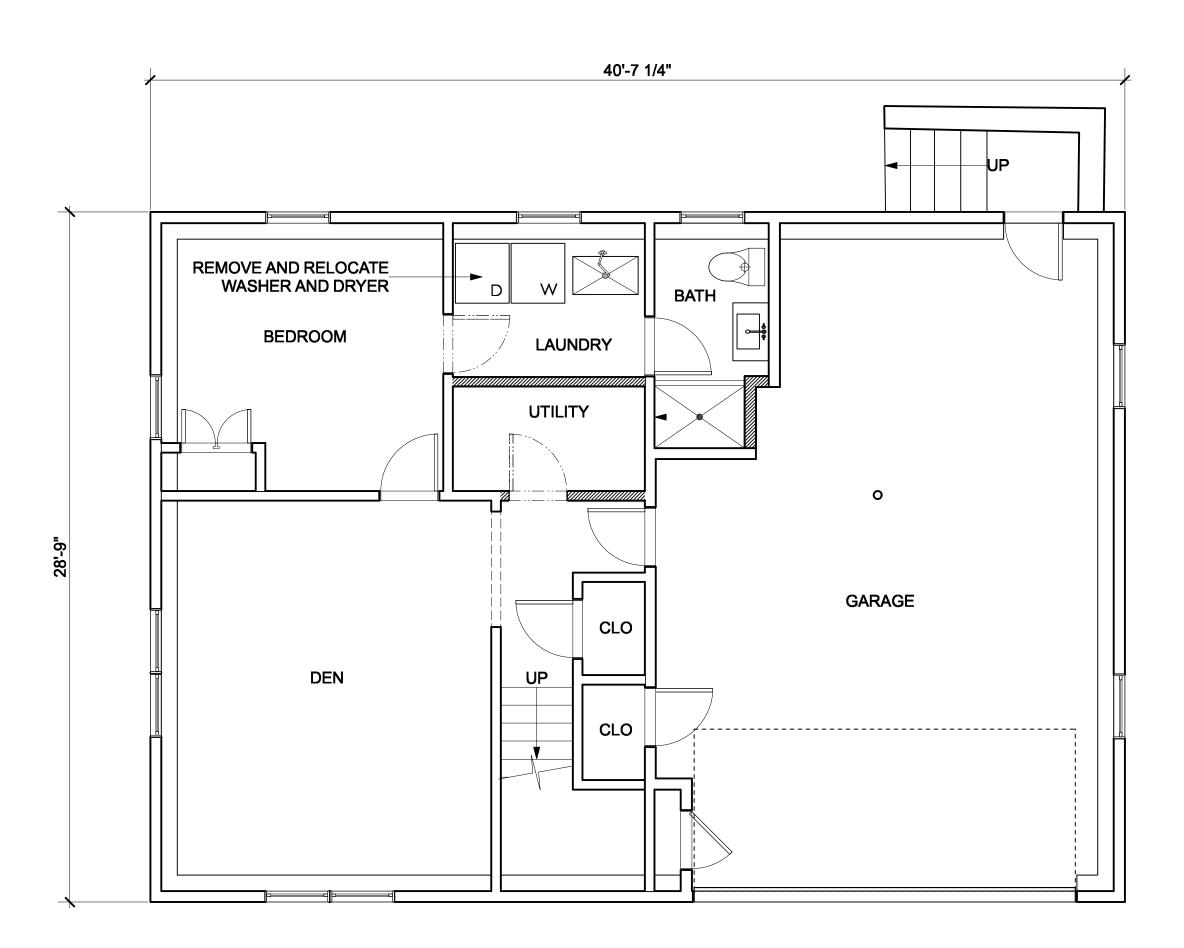

1 EXISTING BASEMENT PLAN
Scale: 1/4" = 1'-0"

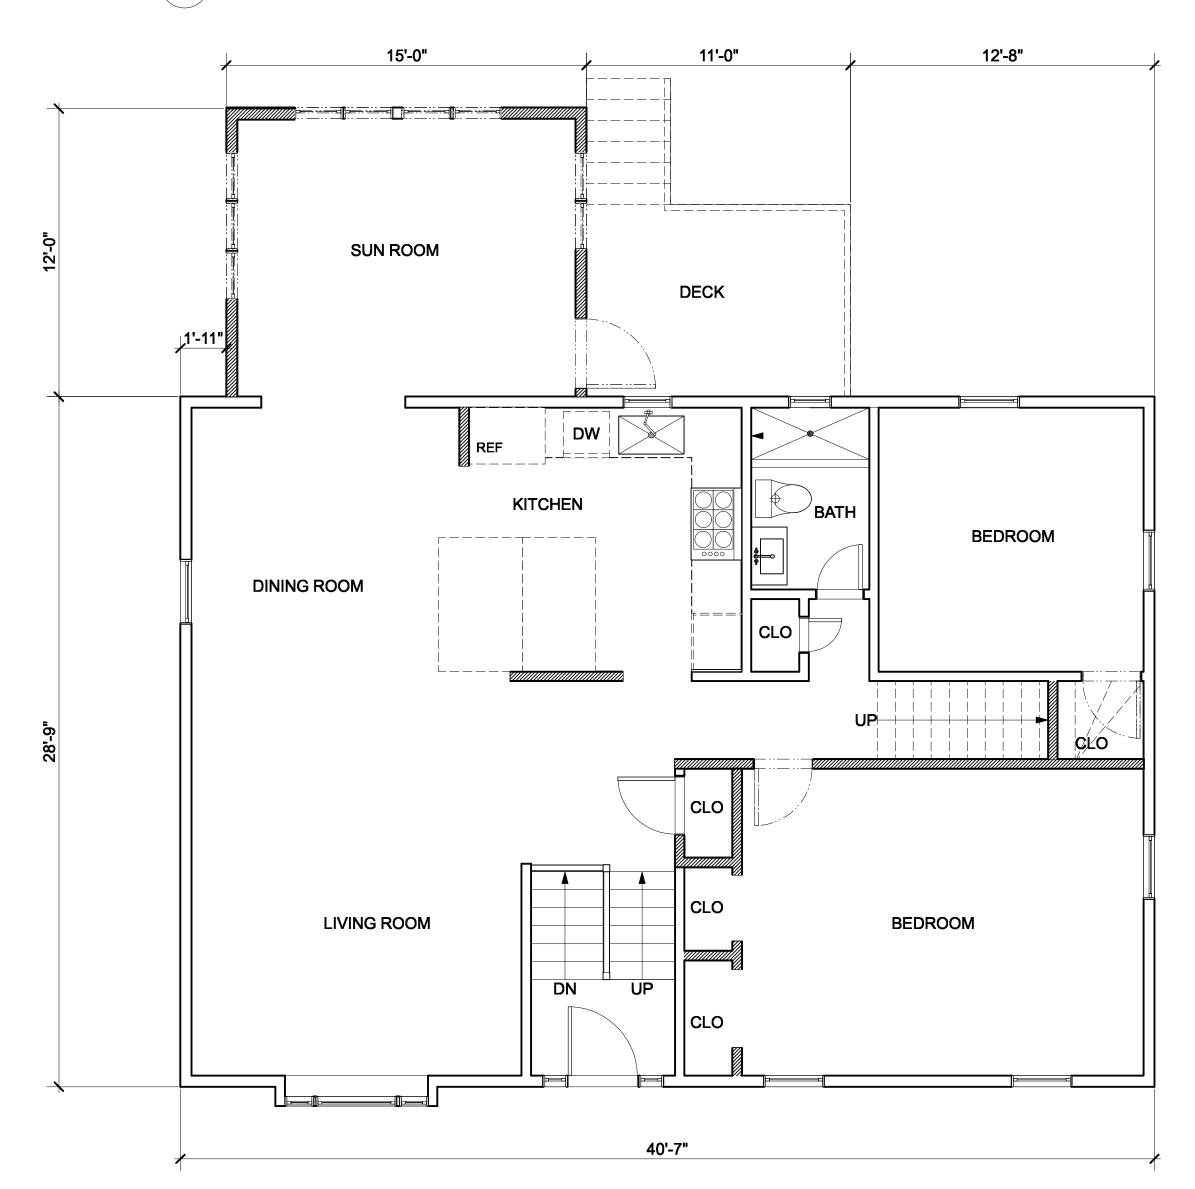


2 EXISTING 1ST FLOOR PLAN
Scale: 1/4" = 1'-0"

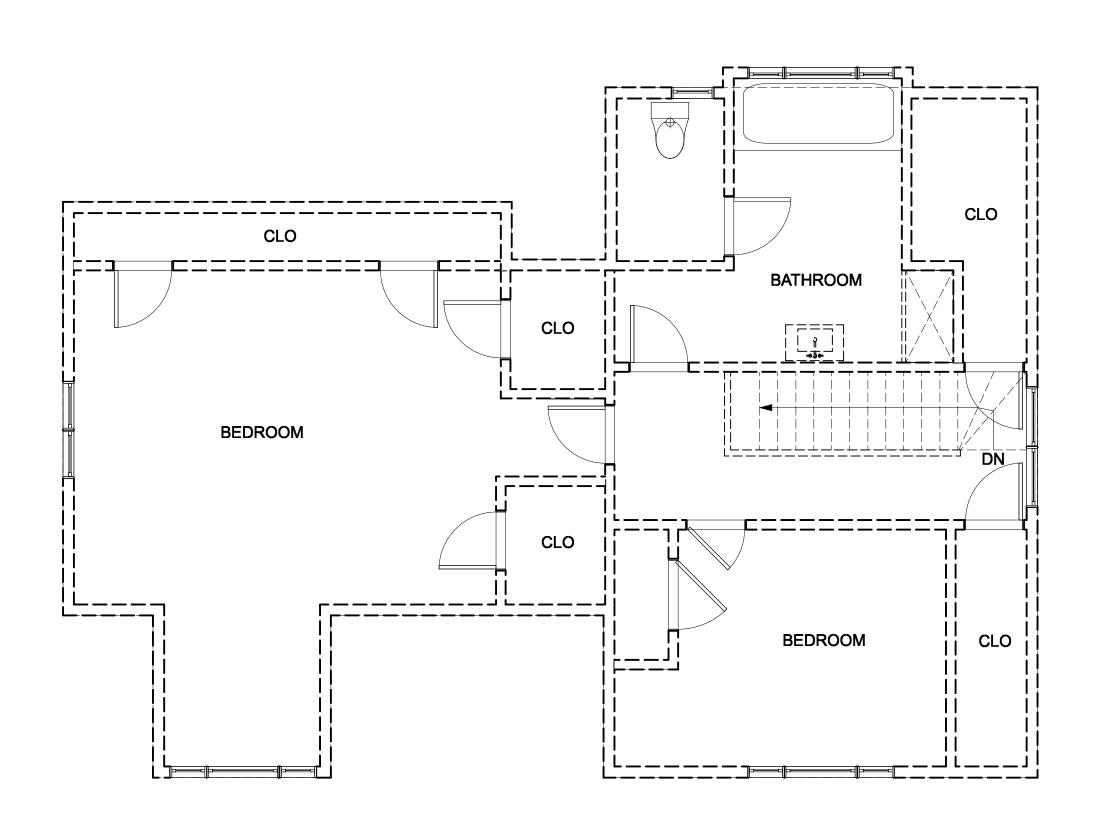

3 EXISTING 2ND FLOOR PLAN (TO BE DEMOLISHED)
Scale: 1/4" = 1'-0"



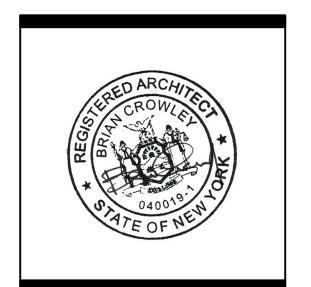

REMODEL & ADDITION
POOR RESIDENCE


date issue

05.13.21 SITE DEVELOPMENT


06.23.21 PLAN. BD. COMMENT REV.

2 07.19.21 PLAN. BD. COMMENT REV.2

Existing Basement, 1st, 2nd Floor/Demo Plans

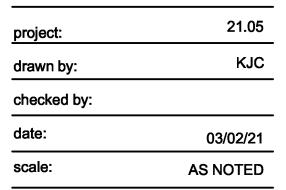

A-2.1

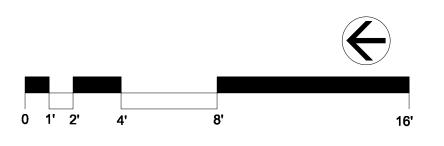


KEY

_____ (E) WALL


(N) WALL

DEMO WALL

GENERAL DEMOLITION

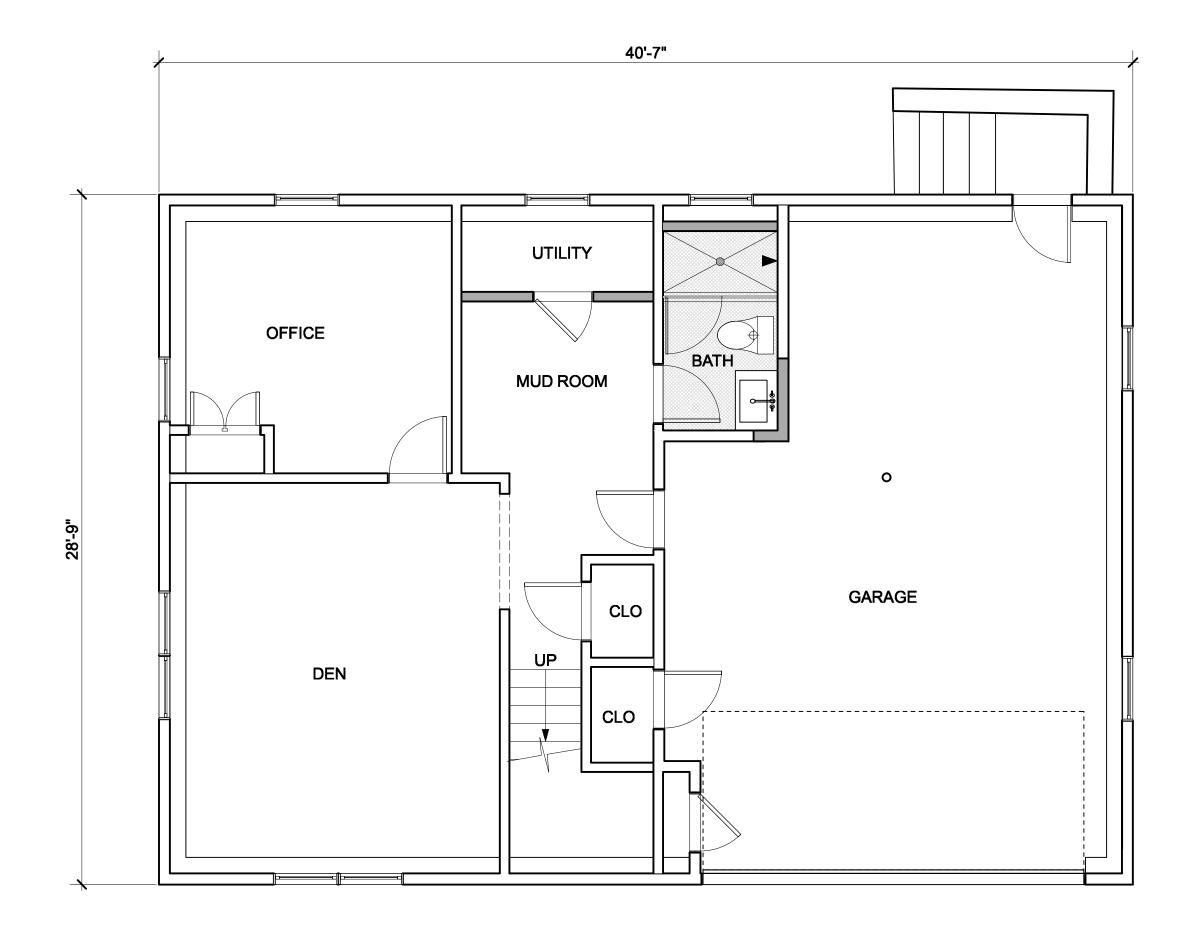


1 PROPOSED BASEMENT PLAN
Scale: 1/4" = 1'-0"

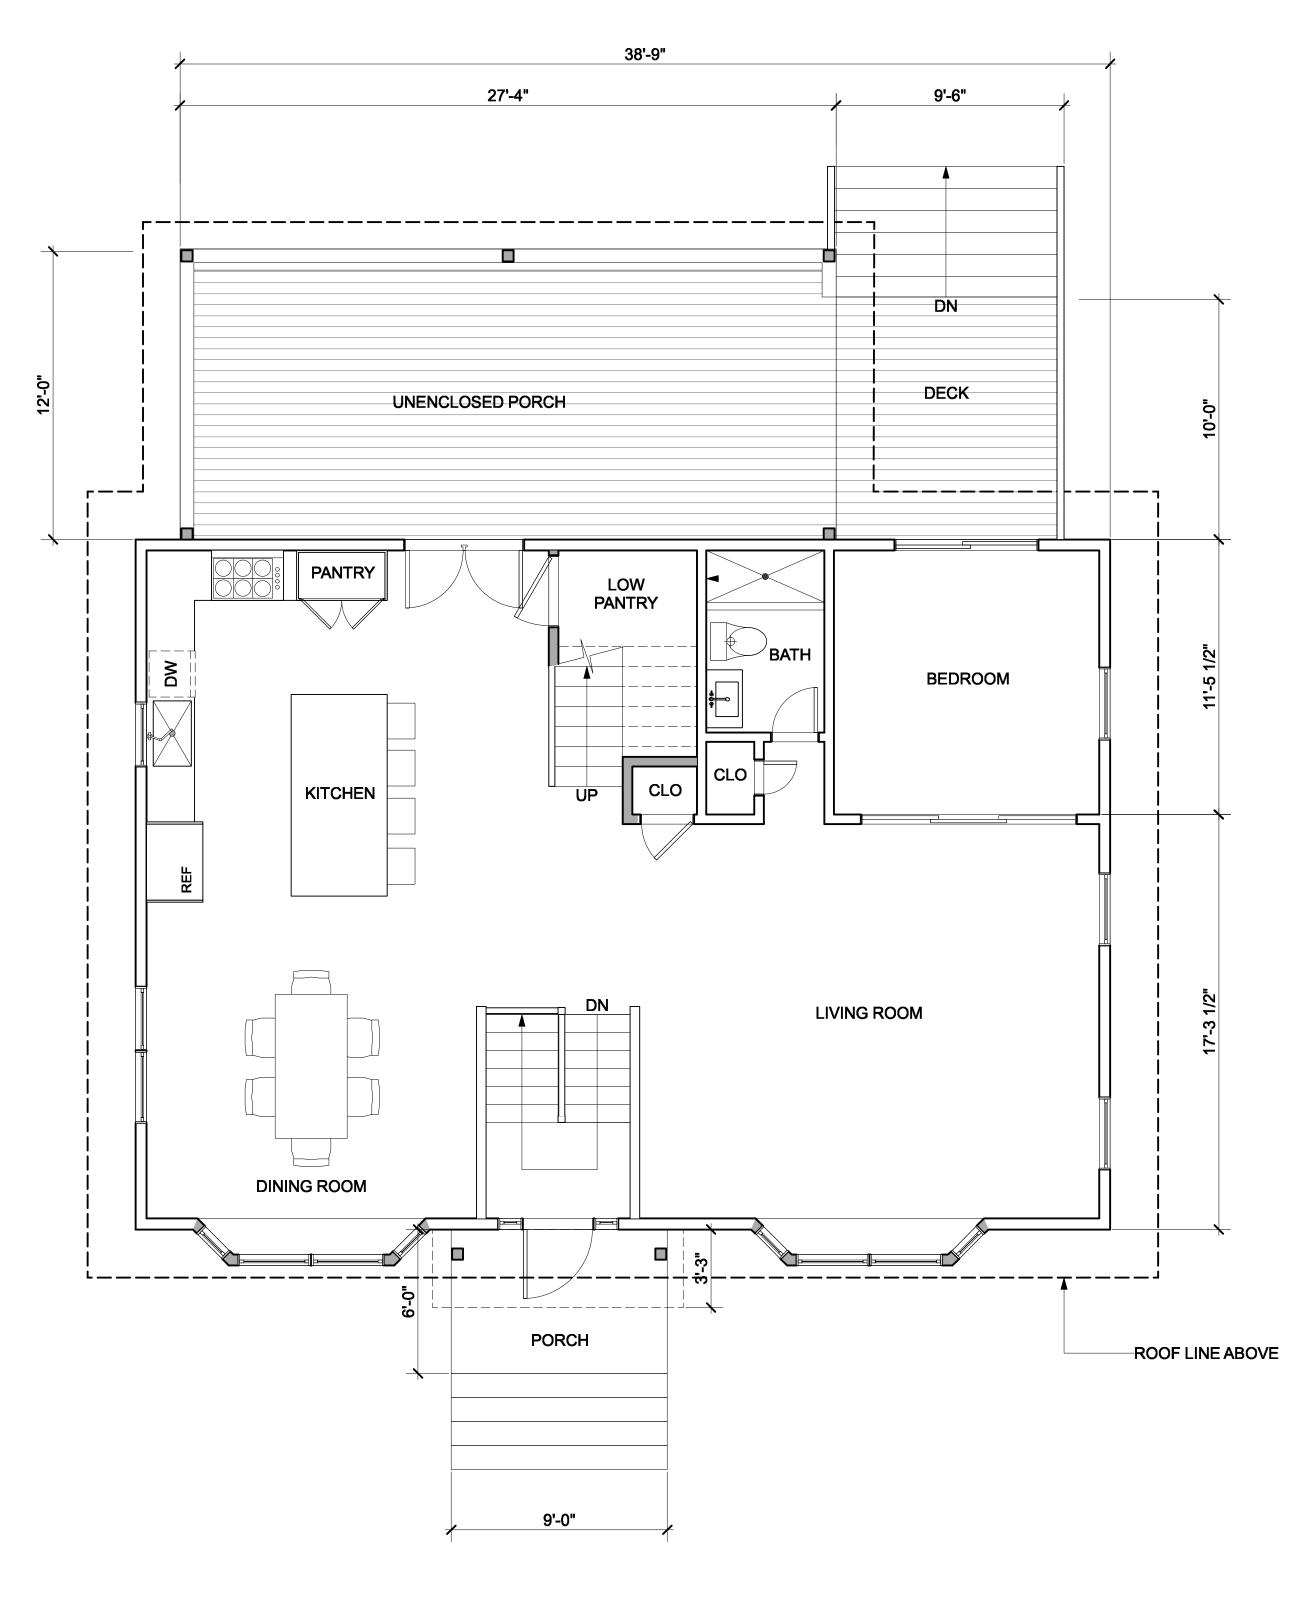


PROPOSED 1ST FLOOR PLAN
Scale: 1/4" = 1'-0"



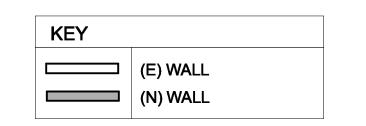



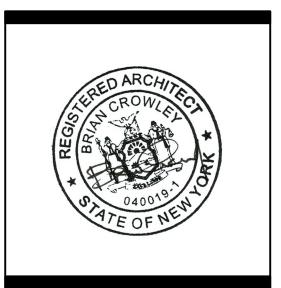

REMODEL & ADDITION
POOR RESIDENCE

date issue

05.13.21 SITE DEVELOPMENT

06.23.21 PLAN. BD. COMMENT REV.

2 07.19.21 PLAN. BD. COMMENT REV.2

Proposed Basement & 1st Floor Plans

project: 21.05


drawn by: KJC


checked by:

date: 03/02/21


scale: AS NOTED


A-22

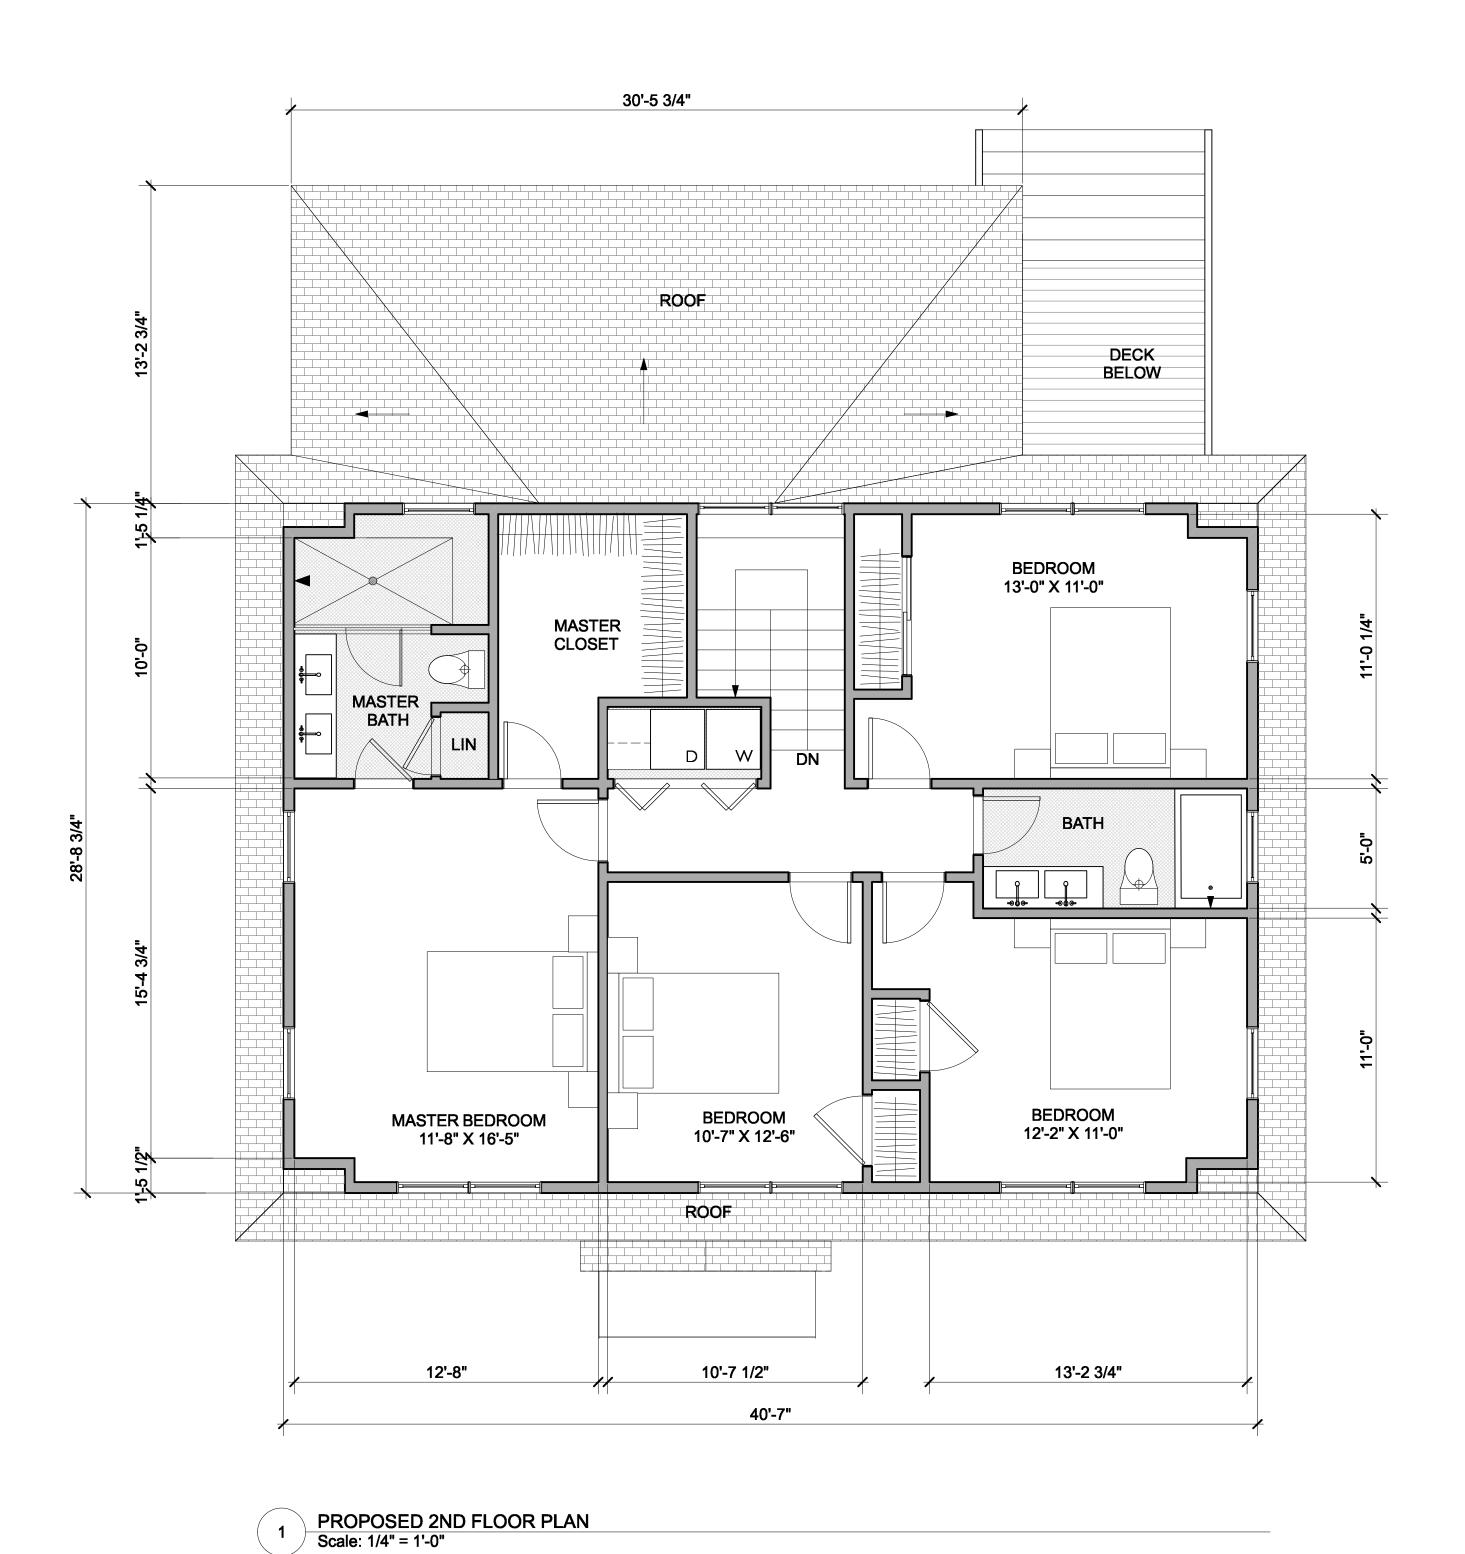

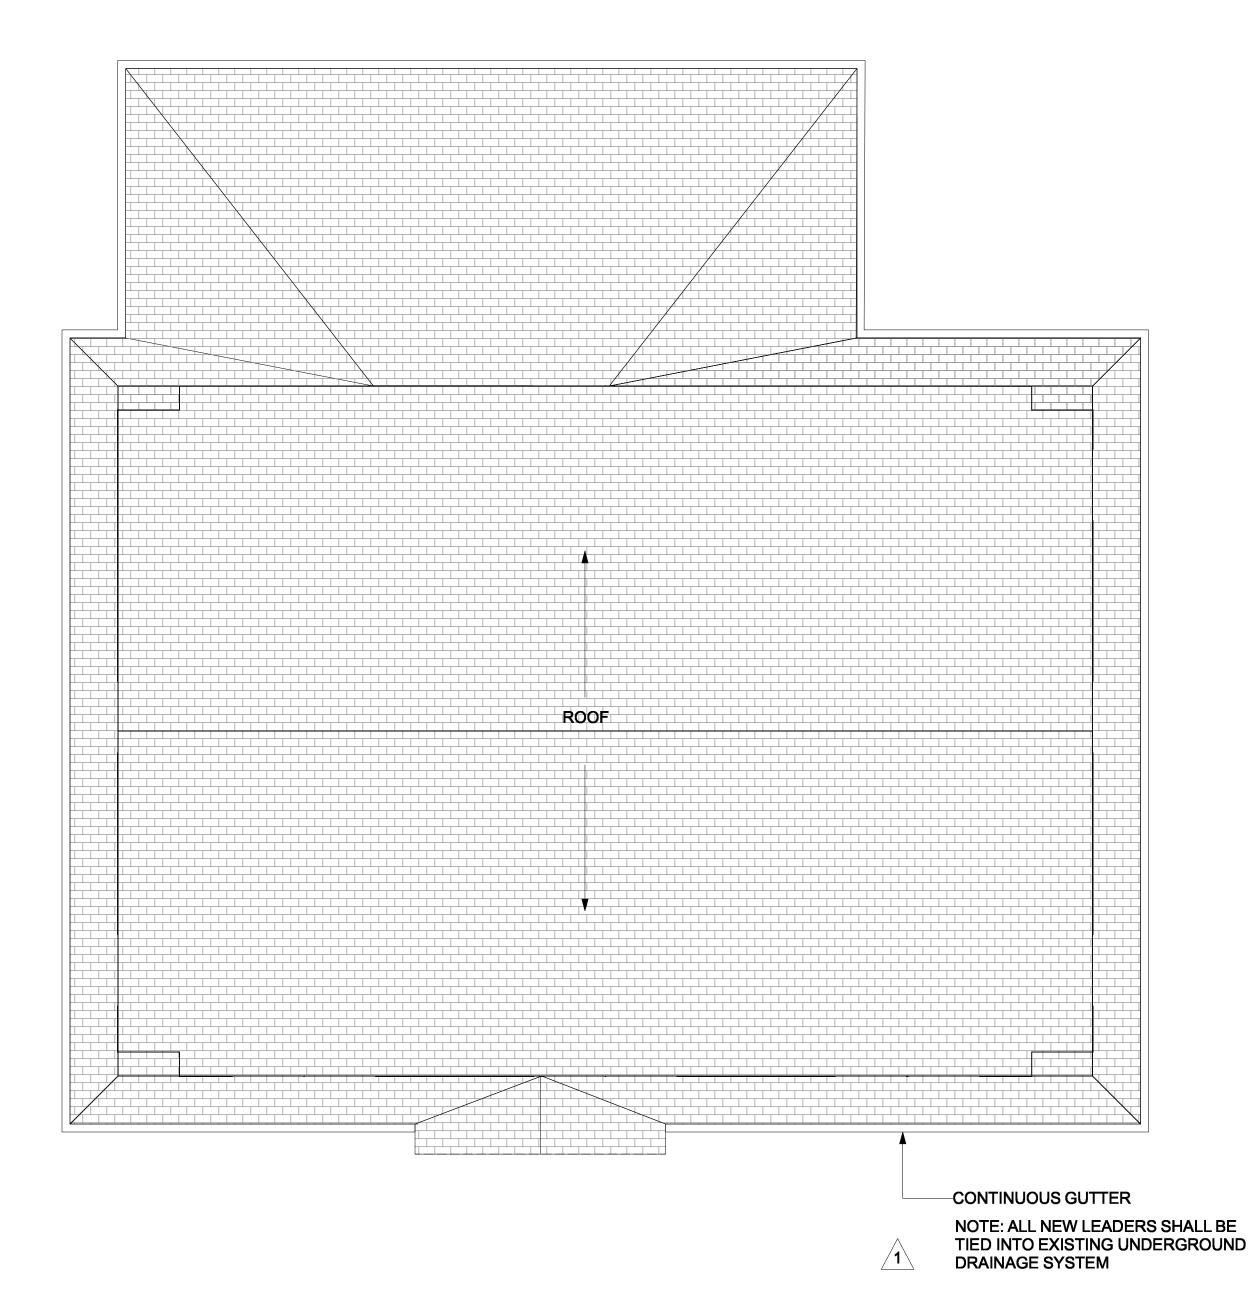


PROPOSED ROOF PLAN
Scale: 1/4" = 1'-0"

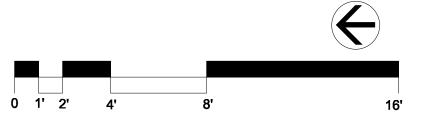

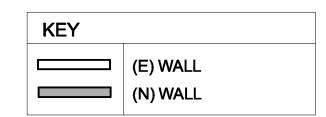



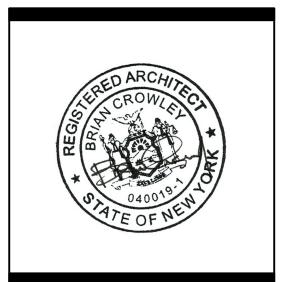


REMODEL & ADDITION POOR RESIDENCE 25 South Cottenet Street Irvington, NY 10533

| # | date | issue |) | |
|---------------------|-------------------|-------------------|--------|-------------|
| 05 | .13.21 | SITE DEV | /ELOPM | IENT |
| 106 | 5.23.21 F | PLAN. BD. C | OMMEN | NT REV. |
| $\sqrt{2}\sqrt{07}$ | '.19.21 F | PLAN. BD. C | OMMEN | NT REV.2 |
| | | | | |
| | | | | |
| | • | ed 2nd F Plans | loor | |
| <u>&</u> | • | | | 1.05 |
| & pro | Roof | | 2 | 1.05 KJC |
| pro dra | Roof | Plans | 2 | |
| pro dra | Roof ject: wn by: | Plans | 2 | KJC |

A-2.3



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REMODEL & ADDITION
POOR RESIDENCE

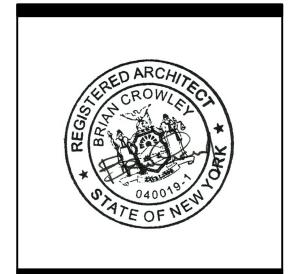06.23.21 PLAN. BD. COMMENT REV

05.13.21 SITE DEVELOPMENT

Existing Elevations

project: 21.05


drawn by: KJC

checked by:


date: 03/02/21

scale: AS NOTED

A-3.1

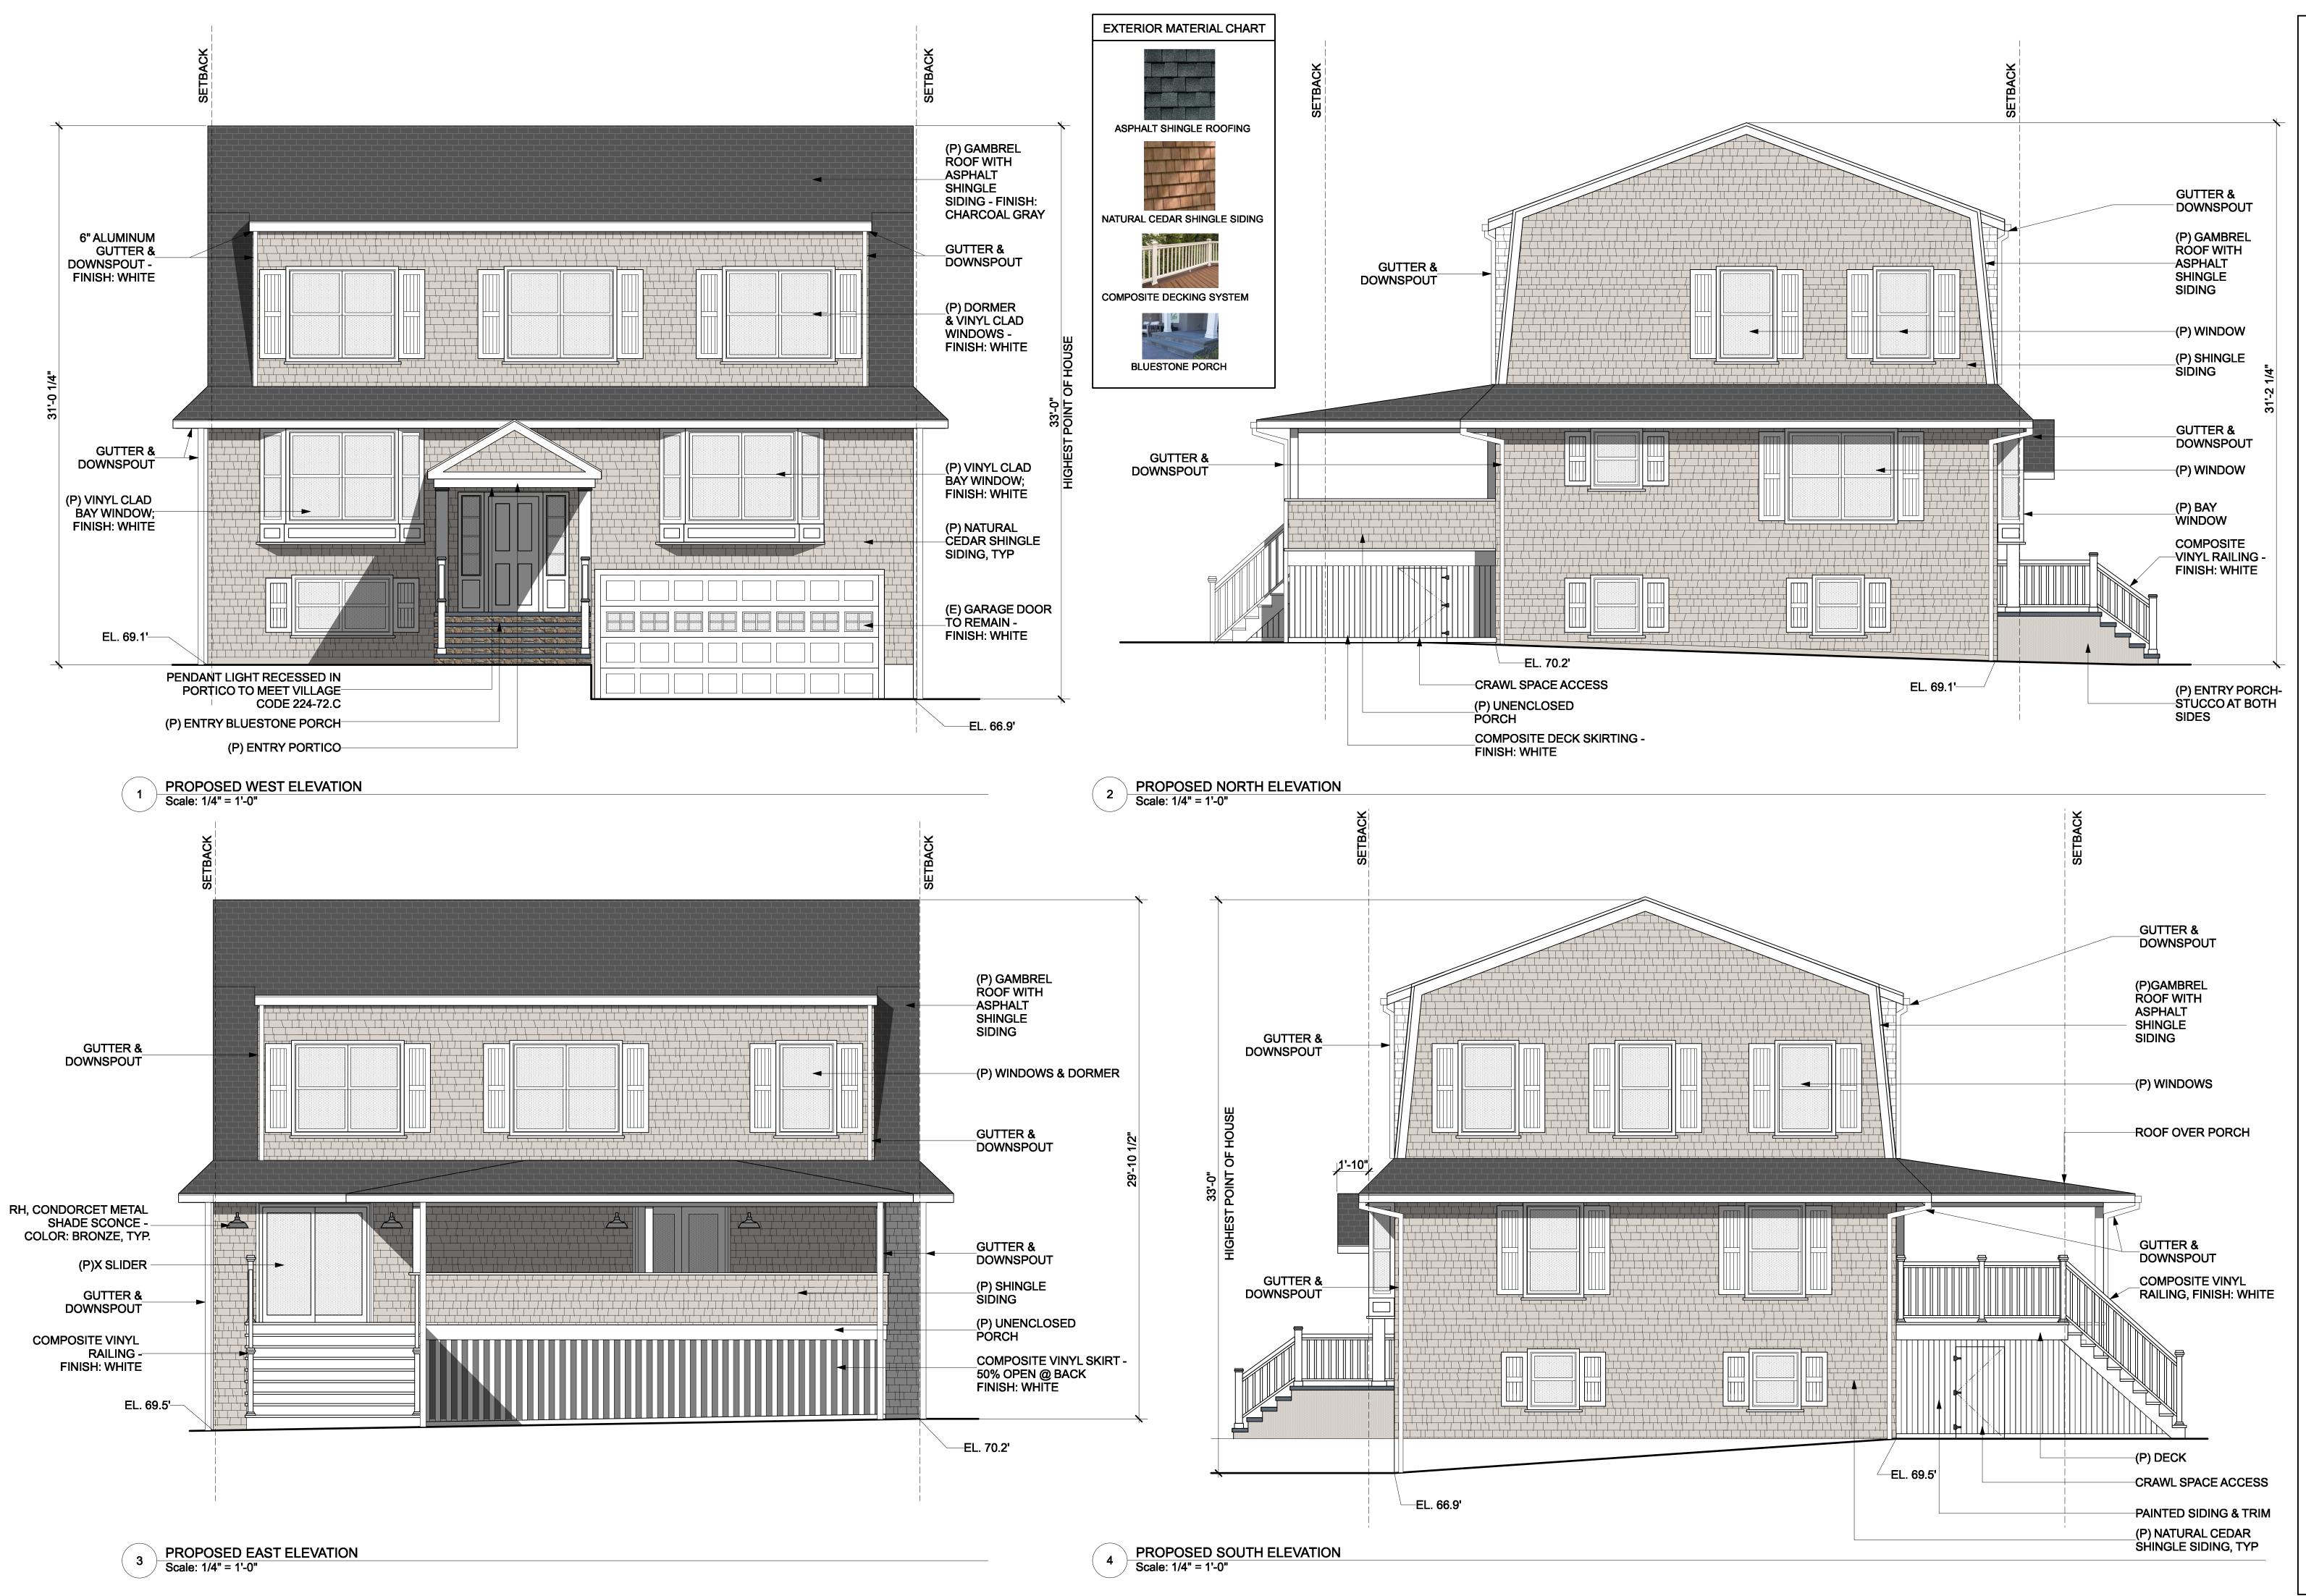

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REMODEL & ADDITION POOR RESIDENCE

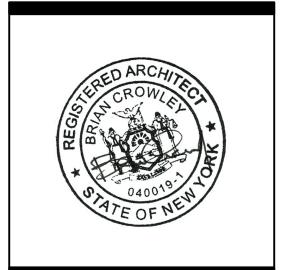Cottenet Street, NY 10533

date issue

05.13.21 SITE DEVELOPMENT

06.23.21 PLAN. BD. COMMENT REV.

07.19.21 PLAN. BD. COMMENT REV.2

Proposed Elevations

project: 21.05
drawn by: KJC
checked by:
date: 03/02/21
scale: AS NOTED

A-3.2