4 April 2022

Ed Marron Building Inspector Village of Irvington 85 Main St. Irvington, NY 10533

RE: Permit application No. 221 49 Field Terrace, Irvington, NY

Mr. Marron:

Attached please find 3 sets of drawings, filing fee check, and a thumb drive with a PDF scanned set of the drawings for the above listed property. This project includes exterior work, so will need to go in front of the Architectural Review Board. We would like to be put on the agenda for the April 25th Meeting.

The proposed exterior work involves an exterior addition and includes some window changes and a new, relocated driveway.

Best.

Douglas McClure

APPLICATION FOR BUILDING PERMIT

The Village of Irvington | 85 Main St | Irvington NY 10533

Application Number:	221	Date:	02/21/2022
Job Location:	49 FIELD TER	Parcel ID:	2.170-76-14
Property Owner:	Sumit Mohan and Subani Chandra	Property Class:	1 FAMILY RES
Occupancy:	One/ Two Family	Zoning:	
Common Name:			

Applicant	Contractor		
Douglas McClure			
McC Architecture pllc			
25 North Dutcher St.Irvington NY 10533			
917-887-0975			

Description of Work

Type of Work:	Addition	Applicant is:	Architect
Work Requested by:	The Owner	In association with:	
Cost of Work (Est.):	275000.00	Property Class:	1 FAMILY RES

Description of Work

Sunroom addition at east side of house, including revising the first floor layout to include a bedroom suite. In addition, relocating the driveway from the north side to the west side of the property.

Please Note: Completing the application does not constitute a permit to commence construction. To obtain your permit follow the instructions on the instruction page provided on page 3.

Job Location: 49 FIELD TER Parcel Id: 2.170-76-14 AFFIDAVIT OF APPLICANT I Douglas McClure being duly sworn, depose and says: That s/he does business as: McC | Architecture pllc with offices at: 25 North Dutcher St. Irvington NY 10533 and that s/he is: The owner of the property described herein. of the New York Corporation with offices at: duly authorized by resolution of the Board of Directors, and that said corporation is duly authorized by the owner to make this application. A general partner of with offices and that said Partnership is duly authorized by the Owner to make this application. The Lessee of the premises, duly authorized by the owner to make this application. The Architect of Engineer duly authorized by the owner to make this application. The contractor authorized by the owner to make this application. That the information contained in this application and on the accompanying drawings is true to the best of his knowledge and belief. The undersigned hereby agrees to comply with all the requirements of the New York State Uniform Fire Prevention and Building Code, the Village of Irvington Building Code, Zoning Ordinance and all other laws pertaining to same, in the construction applied for, whether or not shown on plans or specify in this application. n to before me this GENINE LOCKWOOD Notary Public / Commission of Deeds NOTARY PUBLIC, STATE OF NEW YORK Registration No. 01L06210592 Applicant's Signature Qualified in Westchester County Commission Expires **OWNER'S AUTHORIZATION** I Sumit Mohan and Subani Chandra as the owner of the subject premises and have authorized the contractor named above to perform the work under the subject application.

Owner phone number 917-450-0834 Owner email address mohan. Sumit agmail. com

I hereby acknowledge that it is my responsibility as the property owner to ensure that if the permit (if issued) receives a Final Certificate of Approval from the Building Department and further that if a Final Certificate of Approval is not obtained upon completion of the construction, a property violation may be placed on the property for which this permit is being requested.

Sworn to before me this _______ day of ______ of _______

Notary Public / Commission of Deeds

Applicant's Signature

LIM KIM A.

Notary Public, State of New York

No. 01L16144154

Qualified in Westchester County

Commission Expires Apr. 24, 20

INSTRUCTIONS

REQUIREMENTS FOR OBTAINING A PERMIT:

The following items must be submitted in order to obtain a Building Permit:

- 1. One (1) Building Permit application signed by the owner or a notarized Agent Letter.
- 2. One (1) property survey (signed and sealed), reflecting existing conditions.
- 3. Two (2) sets of construction drawings and specifications, including existing and proposed conditions, state design criteria, structural and architectural details, plans, and cross sections, mechanical, electrical, and plumbing drawings (signed and sealed by a likened professional).
- 4. One USB with all plans (with Licensed Professionals certification/stamp) and specifications in PDF (file size must be less than 25MB).
- 5. Copy of approved site plan from the Irvington Planning Board when applicable (required on all increases of FAR, footprint, coverage, driveways and increases of cubic content under a roof).
- 6. Approval by the Architectural Review Board (ARB) when applicable. An additional five (5) sets of construction drawings and specifications (please see ARB requirements (available on the village web site www.irvingtonny.gov) prior to submission).
- 7. Visit the Village of Irvington website www.irvingtonny.gov
 for additional check list for solar panels, generators, underground propane tanks, signs and awnings(found in forms and documents in the Building & Planning General Information folder).
- 8. Village Zoning Code is available on the Village website: www.irvingtonny.gov.
- 9. Provide evidence that the application meets the NYS Energy code as described by www.dos.state.ny.us/code/energycode/overview.htm

Contractor Requirements in order to obtain a Building Permit:

- 10. Contractor's Certificate of Liability listing the Village of Irvington as the Certificate Holder with no disclaimer in the description other than certificate holder is named additional insured (any additional comments will not be accepted).
- 11. Contractor's Workers Compensation C-105 form (or equivalent) listing the Village of Irvington as Certificate Holder.
- 12. Copy of Contractor's Westchester County Home Improvement License.
- **13.** All information above uploaded into permit application with the contractor's contact information, including mailing address, phone number, and email address.
- 14. Contractor's signature on Affidavit of Contractor (required prior to issuance of the permit).

Please Note:

-State Law requires that the contractor submits a copy of Workman's Compensation as required by the New York State
Disability Insurance naming the Department of Buildings, Village of Irvington as certificate holder and showing coverage for general contacting and the locations covered by such insurance. If structure is to be demolished a copy of Liability Insurance must also be submitted.

- Please be advised under State and Municipal Laws, the Workman's Compensation and Disability benefits insurance must be submitted on separate state approved forms. The "Acord Form" is no longer acceptable as proof of Workman's Compensation coverage. Further information or questions may be answered by calling the NYS Bureau of Compliance at (518) 486-6307 or by visiting their website or by contacting your insurance provider.

FEES ASSOCIATED WITH BUILDING PERMIT APPLICATION (All fees must be paid at time of application):

Fee schedule

Building Permit (Non-Refundable)

* Application fee \$85

* Permit fee \$17 per thousand dollars (\$1000) of estimated cost of construction, or fraction thereof

Inspection Fees (as applicable)

Insulation: \$50

• Solid Fuel: \$50

Foundation and footing drain: \$50

- Energy Code Compliance: \$50
- Sediment and erosion control: \$50

• Footing: \$50

- Preparation for concrete slabs and walls: \$50
- Footing: \$50
- Preparation for concrete slabs and walls: \$50

• Framing: \$50

- Building systems, including underground and rough-in: \$50
- Fire resistant construction and penetrations: \$50

• Final Inspection for C.O.: \$50

State and local laws (per re-inspection): \$50

Total Inspections 250

85

4,675

275

- * Certificate of Occupancy Fees: One dollar (\$1.00) per thousand dollars of estimated cost. Minimum Fee \$25.00
- * Permit Revisions or Amendment: \$50.00 (plus \$17 per thousand (\$1000), of the estimated cost of construction and any additional inspections fees).

* Re-inspection fee for work not ready at time of inspection or not in compliance: \$50

* Applications for Undocumented Work/ Legalizing: Applications to legalize work done prior toapplying for and receiving a building permit shall pay double all applicable fees and inspections, including the cost of construction based on the cost of all proposed work being legalized at the time of application. Minimum fee \$500.00.

(To be collected at time of submission of application)Total _5,285

McC | Architecture pllc

25 n. dutcher st., irvington, ny 10533 mcc-architecture.com t: 917.887.0975 e: dmcclure@mcc-architecture.com

PROJECT INFORMATION:



Chandra Residence

49 Field Terrace. • Irvington, NY

DRAWING LIST: ARCHITECTURAL DRAWINGS:

COV COVER SHEET SP1 SITE PLAN, ZONING CALCS

ENERGY CODE NOTES SP1A REMOVAL AND PROPOSED SITE PLANS

SP2 COVERAGE AND F.A.R. A1 BASEMENT DEMOLITION PLAN

BASEMENT CONSTRUCTION PLAN A3 ENTRY FLOOR DEMO PLAN A4 ENTRY FLOOR PLAN

A5 ELEVATIONS **BUILDING SECTION**

E1 BASEMENT POWER PLAN BASEMENT LIGHTING PLAN ENTRY FLOOR POWER PLAN ENTRY FLOOR LIGHTING PLAN STRUCTURAL DRAWINGS: S-101 STRUCTURAL SHEET 1 S-102 STRUCTURAL SHEET 1

LANDSCAPE DRAWINGS: L-1.0 TREE INVENTORY, REMOVALS AND PROTECTION PLAN L-2.0

CIVIL ENGINEERING DRAWINGS: C-1 STORMWATER MANAGEMENT PLAN C-2 DETAILS

REV. #/DATE


1 PLANNING BOARD 2 PLANNING BOARD COMMENTS 12/1/21 PLANNING BOARD COMMENTS 1//14/22

TO THE BEST OF MY KNOWLEDGE BELIEF & PROFESSIONAL JUDGEMENT OF THE UNDERSIGNED, THE PLANS & SPECIFICATIONS DEPICTED ON THESE DRAWINGS ARE IN COMPLIANCE WITH THE APPLICABLE PROVISIONS OF THE NEW YORK STATE UNIFORM FIRE PREVENTION & BUILDING CODE & THE NEW YORK STATE ENERGY CONSERVATION CONSTRUCTION CODE CURRENTLY IN EFFECT

DRAWING TITLE:

DRAWING INFO.



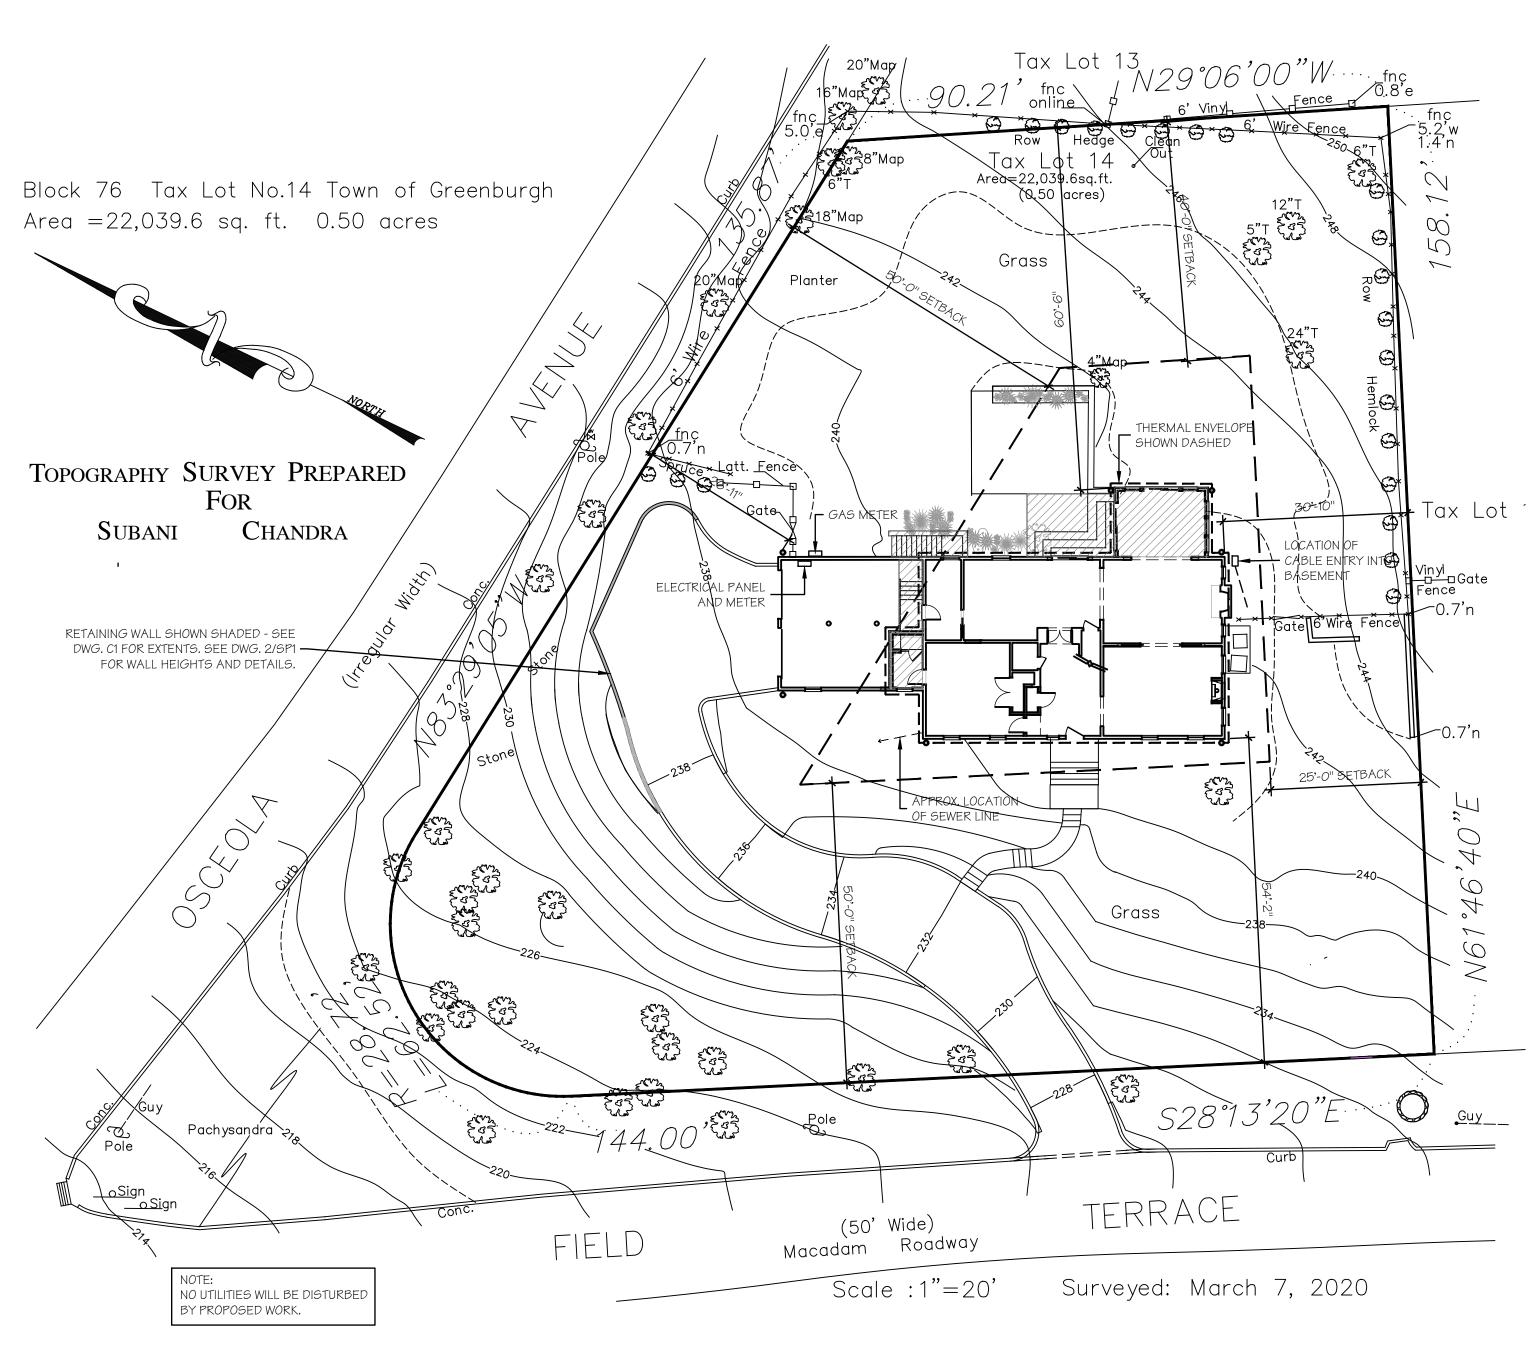



BUILDING DEPARTMENT NOTES

1 "AS-BULT" DRAWINGS OF THE SITE IMPROVEMENTS SHALL BE SUBMITTED TO THE VILLAGE ENGINEER FOR REVIEW PRIOR TO OBTAIING CERTIFICATE OF OCCUPANCY.

2. OCCUPANCY R3


3. CONSTRUCTION TYPE EXIST AND PROPOSED 5B UNPROTECTED

GENERAL NOTES:

ALL WORK SHALL COMPLY WITH THE PROVISIONS OF THE 2020 RESIDENTIAL CODE OF NEW YORK STATE, AND THE 2020 ENERGY CONSERVATION CODE OF NEW YORK STATE.

ALT LEVEL NO 2

SCOPE: NEW SUNROOM ADDITION ON REAR OF HOUSE, RELOCATION OF DRIVEWAY CONSTRUCTION TYPE 5B UNPROTECTED(EXIST AND NEW) OCCUPANCY= SINGLE FAMILY RESIDENTIAL (NO CHANGE)

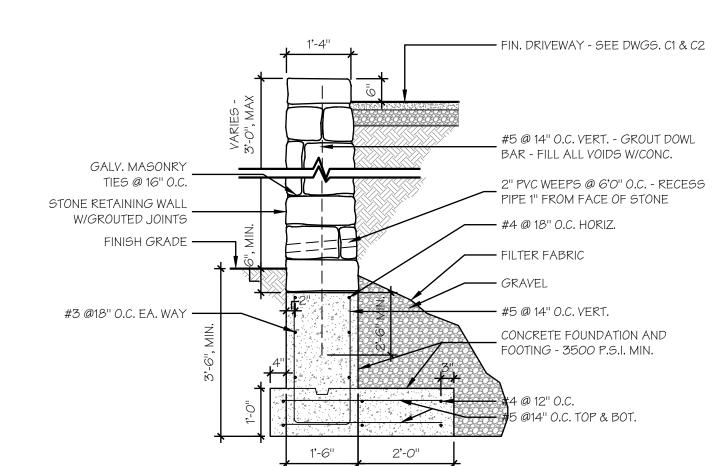



BUILDINGS SHALL BE CONSTRUCTED IN ACCORDANCE WITH THE PROVISIONS OF THE 2020 RESIDENTIAL CODE OF NEW YORK STATE

CLIMATIC & GEOGRAPHIC DESIGN CRITERIA (CLIMATE ZONE 4A)

GROUND	WIND SPD	SEISMIC DSGN	SUI	SUBJECT DAMAGE FROM			WINTER	ICE BARRIER	FLOOD	AIR	MEAN
SNOW LOAD TEMP.REQU'D		CATEGORY INDEX	WTHRING TEMP.	FRST LINE DPTH	TERMITE	DECAY	DESIGN	UNDERLYMNT	HAZARDS	FREEZING	ANNUAL
30 LBS./S.F.	115-120 MPH	С	SEVERE	42" DEEP	MODERATE TO HEAVY	SLIGHT TO MODERATE	7D	YES	FIRM COMMUNITY-PANEL MAP# 36119C0261F EFFECTIVE DATE: 9/28/2007	2000	51.6

INSULATION AND FENESTRATION REQUIREMENTS BY COMPONENT

FROM TABLE 402.1(2) AND R402.1.4 FROM 2020 ENERGY CONSERVATION CONSTRUCTION CODE OF NEW YORK STATE, BASED ON 5,750 HEATING DEGREE DAYS IN CLIMATE ZONE 4A (NOT MARINE)

SUB-SYSTEM	MAXIMUM U-FACTOR	MINIMUM R-VALUE
FENESTRATION	Ug = .35	R - 4
SKYLITE	Ug = .55	
GLAZED FENESTRATION	Ug = .40	
CEILING	Ug = .026	R - 49
FRAME WALL	Ug = .060	20 OR 13+5
MASS WALL	Ug = .098	8/13
FLOOR	Uf = .047	R - 19
BASEMENT WALL	Uf = .059	R - 10/13
SLAB PERIMETER and DEPTH		R10 FOR 2'
CRAWL SPACE WALL	Uf = .065	R - 10/13

- A. R-VALUES ARE MINIMUMS U-FACTORS AND SHGC ARE MAXIMUMS WHEN INSULATION IS INSTALLED IN A CAVITY WHICH IS LESS THAN THE LABEL OR DESIGN THICKNESS OF THE INSULATION, THE INSTALLED R-VALUE OF THE INSULATION SHALL NOT BE LESS THAN THE R-VALUE SPECIFIED IN THE TABLE.
- B. THE FENESTRATION U-FACTOR COLUMN EXCLUDES SKYLIGHTS THE SHGC COLUMN APPLIES TO ALL GLAZED FENESTRATION EXCEPTION: SKYLIGHTS MAY BE EXCLUDED FROM GLAZED FENESTRATION SHGC REQUIREMENTS IN CLIMATE ZONES I THROUGH 3 WHERE THE SHGC FOR SUCH SKYLIGHTS DOES NOT EXCEED 0 30 .
- C. 15/ 19" MEANS R-IS CONTINUOUS INSULATION ON THE INTERIOR OR EXTERIOR OF THE HOME OR R-21 CAVITY INSULATION AT THE INTERIOR OF THE BASEMENT WALL. 15/19 SHALL BE PERMITTED TO BE MET WITH R-13 CAVITY INSULATION ON THE INTERIOR OF THE BASEMENT WALL PLUS R-S CONTINUOUS INSULATION ON THE INTERIOR OR EXTERIOR OF THE HOME '10/13' MEANS R-IO CONTINUOUS INSULATION ON THE INTERIOR OR EXTERIOR OF THE HOME OR R-13 CAVITY INSULATION AT THE INTERIOR OF THE BASEMENT WALL
- D. R-5 SHALL BE ADDED TO THE REQUIRED SLAB EDGE R-VALUES FOR HEATED SLABS INSULATION DEPTH SHALL BE THE DEPTH OF THE FOOTING OR 2 FEET, WHICHEVER IS LESS IN CLIMATE ZONES I THROUGH 3 FOR HEATED
- E. THERE ARE NO SHGC REQUIREMENTS IN THE MARINE ZONE
- F. BASEMENT WALL INSULATION IS NOT REQUIRED IN WARM-HUMID LOCATIONS AS DEFINED BY FIGURE R301
- G. OR INSULATION SUFFICIENT TO FILL THE FRAMING CAVITY, R-21 MINIMUM
- H. THE FIRST VALUE IS CAVITY INSULATION, THE SECOND VALUE S CONTINUOUS INSULATION, SO '13+5" MEANS R-13 CAVITY INSULATION PLUS R-5 CONTINUOUS INSULATION.
- I. THE SECOND R-VALUE APPLIES WHEN MORE THAN HALF THE INSULATION IS ON THE INTERIOR OF THE MASS

ENERGY NOTES:

- 1. I, DOUGLAS MCCLURE, CERTIFY THAT THESE PLANS AND SPECIFICATIONS COMPLY WITH 8THE 2020 ENERGY CONSERVATION CODE OF NEW YORK STATE.
- 2 ALL INSULATION SHALL BE AT MINIMUM PAPER FACED FIBERGLASS BATTS, WITH THE PAPER FACING THE WARM SIDE OF THE ASSEMBLY.
- 3. THE G.C. SHALL PROVIDE A PERMANENT CERTIFICATE POSTED ON OR IN THE ELECTRICAL DISTRIBUTION PANEL LISTING THE PREDOMINANT R-VALUES OF THE INSULATION INSTALLED PER SYSTEM THROUGH OUT THE RESIDENCE PER SECTION 401.3 OF THE ENERGY CONSERVATION CONSTRUCTION CODE OF NEW YORK STATE.
- 4. FOR BLOWN IN INSULATION, THE SETTLED R-VALUE SHALL BE USED.
- 5. INSULATION VALUES SHOWN IN THE CHART ABOVE ARE MINIMUM VALUES REQUIRED BY CODE AND MAY NOT REFLECT THE INSULATION VALUES CALLED OUT IN THE CONSTRUCTION DOCUMENTS. WHEN TWO DIFFERENT INSULATION VALUES ARE CALLED OUT, CONTRACTORS ARE HEREBY DIRECTED TO INSTALL THE INSULATION WITH GREATER R-VALUE PER ASSEMBLY.
- 6. R-21 BATT INSULATION SHALL BE INSTALLED IN ALL 2X6 EXTERIOR WALLS.

R402.2.1 CEILINGS WITH ATTIC SPACES.

WHERE SECTION R402.1.2 WOULD REQUIRE R-38 INSULATION IN THE CEILING, INSTALLING R-30 OVER 100 PERCENT OF THE CEILING AREA REQUIRING INSULATION SHALL BE DEEMED TO SATISFY THE REQUIREMENT TOR R-38 WHEREVER THE FULL HEIGHT OF UNCOMPRESSED R-30 INSULATION EXTENDS OVER THE WALL TOP PLATE AT THE EAVES. SIMILARLY, WHERE SECTION R402.1.2 WOULD REQUIRE R-49 INSULATION IN THE CEILING, INSTALLING R-38 OVER 100 PERCENT OF THE CEILING AREA REQUIRING INSULATION SHALL BE DEEMED TO SATISFY THE REQUIREMENT TOR R-49 INSULATION WHEREVER THE FULL HEIGHT OF UNCOMPRESSED R-38 INSULATION EXTENDS OVER THE WALL TOP PLATE AT THE EAVES. THIS REDUCTION SHALL NOT APPLY TO THE U-FACTOR ALTERNATIVE APPROACH IN SECTION R402.1.4 AND THE TOTAL U-FACTOR ALTERNATIVE IN SECTION R402.1.5

R402.2.2 CEILINGS WITHOUT ATTIC SPACES.

WHERE SECTION R402.1.2 WOULD REQUIRE INSULATION LEVELS ABOVE R-30 AND THE DESIGN OF THE ROOF/CEILING ASSEMBLY DOES NOT ALLOW SUFFICIENT SPACE TOR THE REQUIRED INSULATION, THE MINIMUM REQUIRED INSULATION TOR SUCH ROOT/CEILING ASSEMBLIES SHALL BE R-30 THIS REDUCTION OF INSULATION FROM THE REQUIREMENTS OF SECTION R402.1.2 SHALL BE LIMITED TO 500 SQUARE FEET (46 METER SQ) OR 20 PERCENT OF THE TOTAL INSULATED CEILING AREA, WHICHEVER IS LESS. THIS REDUCTION SHALL NOT APPLY TO THE U-FACTOR ALTERNATIVE APPROACH IN SECTION R402 1 4 AND THE TOTAL UA ALTERNATIVE IN SECTION

FOR AIR-PERMEABLE INSULATIONS IN VENTED ATTICS, A BATTLE SHALL BE INSTALLED ADJACENT TO SOFFIT AND EAVE VENTS. BAFFLES SHALL MAINTAIN AN OPENING EQUAL OR GREATER THAN THE SIZE OF THE VENT. THE BATTLE

SHALL EXTEND OVER THE TOP OF THE ATTIC INSULATION. THE BATTLE SHALL BE PERMITTED TO BE ANY SOLID MATERIAL.

LOT DATA 40,000 NO CHANGE OT SIZE 22040 WIDTH 150 NO CHANGE 172 150 158 NO CHANGE **SETBACKS** FRONT YARD 50 30.2 30.2** 15.5 SIDE YARD 1 25 NO CHANGE SIDE YARD 2 25 15.5 NO CHANGE 40 67.6 NO CHANGE 2.5 MAX. HEIGHT-STORIES 2.5 NO CHANGE MAX. HEIGHT- FEET 35 28'-11" NO CHANGE COVERAGE 2645 3382 3060 MAX. BUILDING COVERAGE (12%)1ST 40,000+4% OF ADDITIONAL FT2 LOOR AREA RATIO (.43 x LOT AREA) 4320 1532 1760 SECOND 1526 1526 3195 3367 TOTAL

ZONING ANALYSIS

49 FIELD TERRACE, IRVINGTON, WESTCHESTER NY PARCEL ID: 2.170-76-14

ALLOWABLE

1F-40

BLOCK

EXISTING

PROPOSED

I. ALL WORK SHALL COMPLY WITH THE 2020 RESIDENTIAL CODE OF NY STATE, (MOST CURRENT INTERNATIONAL RESIDENTIAL CODE [IRC]), THE VILLAGE OF IRVINGTON ZONING CODE AND ALL OTHER AGENCIES HAVING JURISDICTION.

- THE G.C. IS TO SECURE A BUILDING PERMIT FROM THE VILLAGE OF IRVINGTON BUILDING DEPARTMENT
- G.C. SHALL GIVE THE OWNER A WRITTEN GUARANTEE COVERING ALL EQUIPMENT, MATERIALS AND WORKMANSHIP FOR A PERIOD OF (1) ONE YEAR FROM DATE OF FINAL ACCEPTANCE BY THE OWNER (CONFIRMED IN WRITING), AND HE SHALL, UPON NOTICE, PROMPTLY MAKE GOOD AT HIS OWN EXPENSE ALL DEFECTS IN MATERIAL AND WORKMANSHIP DURING THIS PERIOD AT NO COST
- THE CHARACTER AND SCOPE OF THE WORK ARE ILLUSTRATED BY THE DRAWINGS AND NOTES. FULL SIZE OR LARGE SCALE DETAILS OR DRAWINGS SHALL GOVERN OVER SMALL SCALE DRAWINGS WHICH THEY ARE INTENDED TO AMPLIFY. DETAILS OR CONDITIONS INDICATED FOR A PORTION OF THE WORK SHALL APPLY THROUGHOUT TO ALL SIMILAR PORTIONS EXCEPT AS OTHERWISE SPECIFICALLY NOTED. DIMENSIONS SHALL BE FIGURED RATHER THAN DETERMINED BY RULE OR SCALE.
- UNLESS OTHERWISE NOTED, ALL DIMENSIONS ARE FINISHED DIMENSIONS.
- VI. THE GENERAL CONTRACTOR SHALL PROVIDE ALL NECESSARY PROTECTION AGAINST DIRT AND DAMAGE
- VII. THE G.C SHALL PROVIDE, ERECT & MAINTAIN TEMP. DUST BARRIERS/PARTITIONS & OTHER ITEMS REQ'D. FOR PROPER PROTECTION OF AREAS ADJACENT TO THE WORK & PROVIDE SAFE ACCESS TO THE PORTIONS THAT ARE NOT AFFECTED BY THE WORK.
- VIII. ALL PERTINENT PRECAUTIONS FOR ACCIDENT PREVENTION RECOMMENDED BY THE ASSOCIATED GENERAL CONTRACTORS OF AMERICA, INC., OSHA, OR BY STATE AND LOCAL LAWS AND REGULATIONS, SHALL BE CONSIDERED TO FORM A PART OF THE CONTRACT WORK.
- IX. CONTRACTOR SHALL KEEP A FULL SET OF COMPLETE UP-TO-DATE PLANS AVAILABLE AT THE JOB. INSURANCE REQUIREMENTS:
- A. THE CONTRACTOR SHALL PURCHASE & MAINTAIN INSURANCE OF A FORM & WITH COMPANIES SATISFACTORY TO THE OWNER, & THE VILLAGE OF IRVINGTON.

XI. ELECTRICAL NOTES:

- A. ELECTRICAL INSTALLATIONS SHALL BE IN ACCORDANCE WITH THE 2014 NATIONAL ELECTRIC CODE, NFPA 70, THE VILLAGE OF IRVINGTON BUILDING DEPARTMENT, & ANY OTHER AGENCIES HAVING JURISDICTION. CONTRACTOR SHALL OBTAIN ALL NECESSARY APPROVALS FROM ALL AGENCIES HAVING JURISDICTION.
- B. FURNISH & INSTALL ALL LIGHTING FIXTURES & OTHER ELECTRICAL FIXTURES AS INDICATED ON PLANS.

SMOKE DETECTOR NOTES

- 1. THE INSTALLATION OF WIRING & EQUIPMENT SHALL BE IN ACCORDANCE WITH NFPA 72.
- 2. SMOKE DETECTORS SHALL BE INSTALLED ACCORDING TO NYS RESIDENTIAL CODE 314

3. LOCATIONS

- IN EACH SLEEPING ROOM • OUTSIDE EACH SEPARATE SLEEPING AREA IN THE IMMEDIATE VICINITY OF THE BEDROOMS • ON EACH ADDITIONAL STORY OF THE DWELLING INCLUDING BASEMENTS AND HABITABLE ATTICS ON DEWLLINGS WITH SPLIT LEVELS AND WITHOUT AN INTERVENING DOOR BETWEEN THE ADJACENT LEVELS A SMOKE
- ALARM ON THE UPPER LEVEL SHALL SUFFICE, PROVIDED THE LOWER LEVEL IS LESS THAN A FULL STORY BELOW • SMOKE ALARMS SHALL BE INSTALLED NO LESS THAN 3 FEET HORIZONTALLY FROM THE DOOR OR OPENING OF A BATHROOM THAT CONTAINS A BATHTUB
- 4. HARDWIRED AND INTERCONNECTED, CAN BE BATTERY OPERATED IN ADDITIONS, ALTERATIONS OR REPAIRS IF NOT REMOVING INTERIOR FINISHES UNLESS ACCESS FROM ATTIC, CRAWL SPACE OR BASEMENT
- 5. EACH SMOKE DETECTOR SHALL HAVE AN INTEGRAL TEST MEANS TO PERMIT THE OCCUPANT TO CHECK THAT IT IS OPERATIONAL. A CONTINUOUS POWER DISPLAY INDICATOR LIGHT IS RECOMMENDED, & ALL DETECTORS ARE TO BE HARDWIRED & INTERCONNECTED.
- 6. SMOKE DETECTORS SHALL BE LOCATED ON OR NEAR THE CEILING & WITHIN FIFTEEN FEET OF ALL ROOMS USED FOR SLEEPING PURPOSES. IN ALL DWELLING UNITS W/MULTIPLE LEVELS, WHEN ANY LEVEL HAS ONLY ONE MEANS OF EGRESS, THE DWELLING UNIT SHALL BE PROVIDED WITH SMOKE DETECTORS AT ALL LEVELS
- 7. IF CLG. MOUNTED, CLOSEST EDGE OF THE DETECTOR SHALL BE A MIN. OF 4" FROM WALL
- 8. IF WALL MOUNTED THE CLOSEST EDGE OF THE DETECTOR SHALL BE FOUR INCHES & A MAXIMUM OF TWELVE INCHES FROM THE CEILING.
- 9. SMOKE DETECTOR UNIT(S) SHALL BE APPROVED BY BSA ACCEPTED PURSUANT TO RULES & REGULATION PROMULGATED BY THE COMMISSIONER OR LISTED BY AN ACCEPTABLE TESTING AGENCY SUCH AS UNDERWRITERS LABORATORY OR APPROVED
- 10. UNITS TO BE EITHER, IONIZATION CHAMBER OR PHOTO ELECTRIC AND TO COMPLY WITH RS 17-11.

CARBON MONOXIDE DETECTOR NOTES:

1. CARBON MONOXIDE DETECTORS TO BE INSTALLED THROUGHOUT THE DWELLING IN ACCORDANCE WITH NEW YORK STATE BUILDING CODE. STRUCTURAL NOTES:

THE INTEGRITY OF EXISTING FRAMING AND FOUNDATION MEMBERS ARE NOT KNOWN PRIOR TO DEMOLITION. AN ENGINEER MUST CERTIFY THAT LOADS ARE AS ANTICIPATED AS WELL AS CONNECTIONS TO SUPPORTING MEMBERS AT DEMOLITION.

McC | Architecture pllc

25 n. dutcher st., irvington, ny 10533 mcc-architecture.com t: 917.887.0975 e: dmcclure@mcc-architecture.com

NOTES:

PROJECT INFORMATION:

REV. #/DATE

PLANNING BOARD PLANNING BOARD COMMENTS /3\ PLANNING BOARD COMMENTS

12/1/21

) THE BEST OF MY KNOWLEDGE BELIEF & PROFESSIONAL JUDGEMENT OF THE IDERSIGNED, THE PLANS & SPECIFICATIONS DEPICTED ON THESE DRAWINGS ARE I OMPLIANCE WITH THE APPLICABLE PROVISIONS OF THE NEW YORK STATE UNIFORM

RE PREVENTION & BUILDING CODE & THE NEW YORK STATE ENERGY


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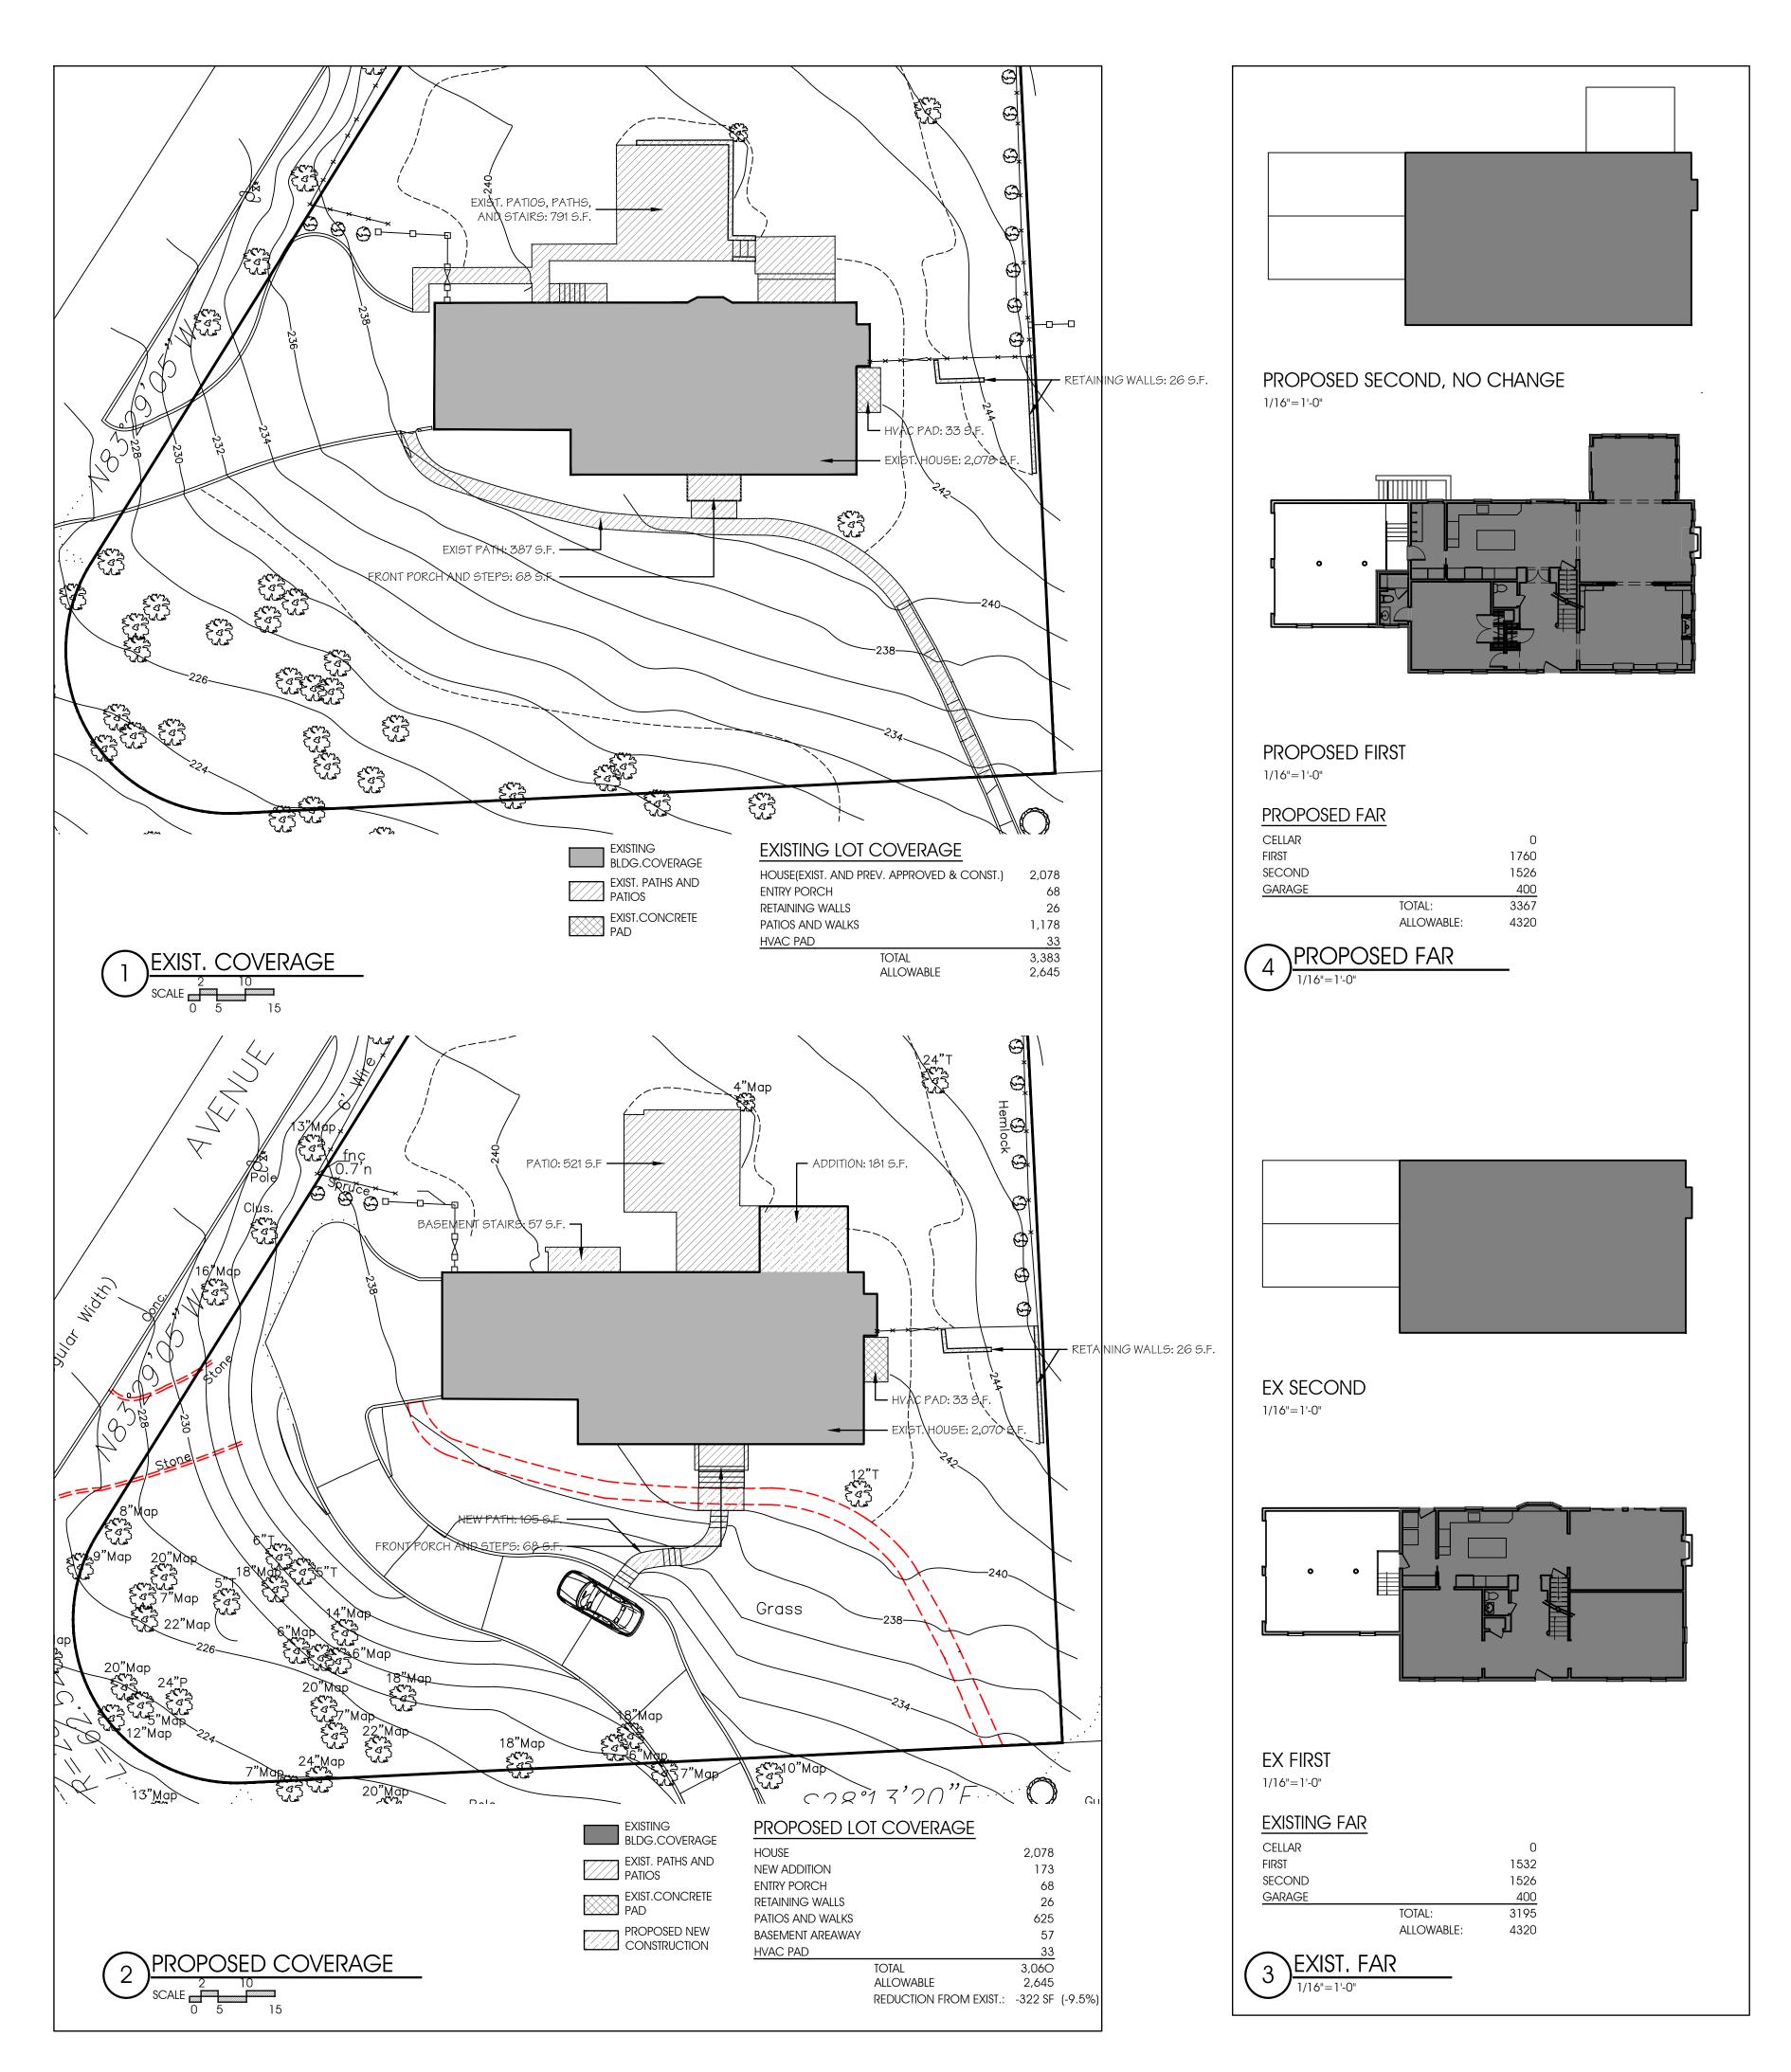
SITE PLAN **ZONING CALCS ENERGY CODE NOTES**


DRAWING INFO.

1917-Planning.dwg

1917-Planning.dwg



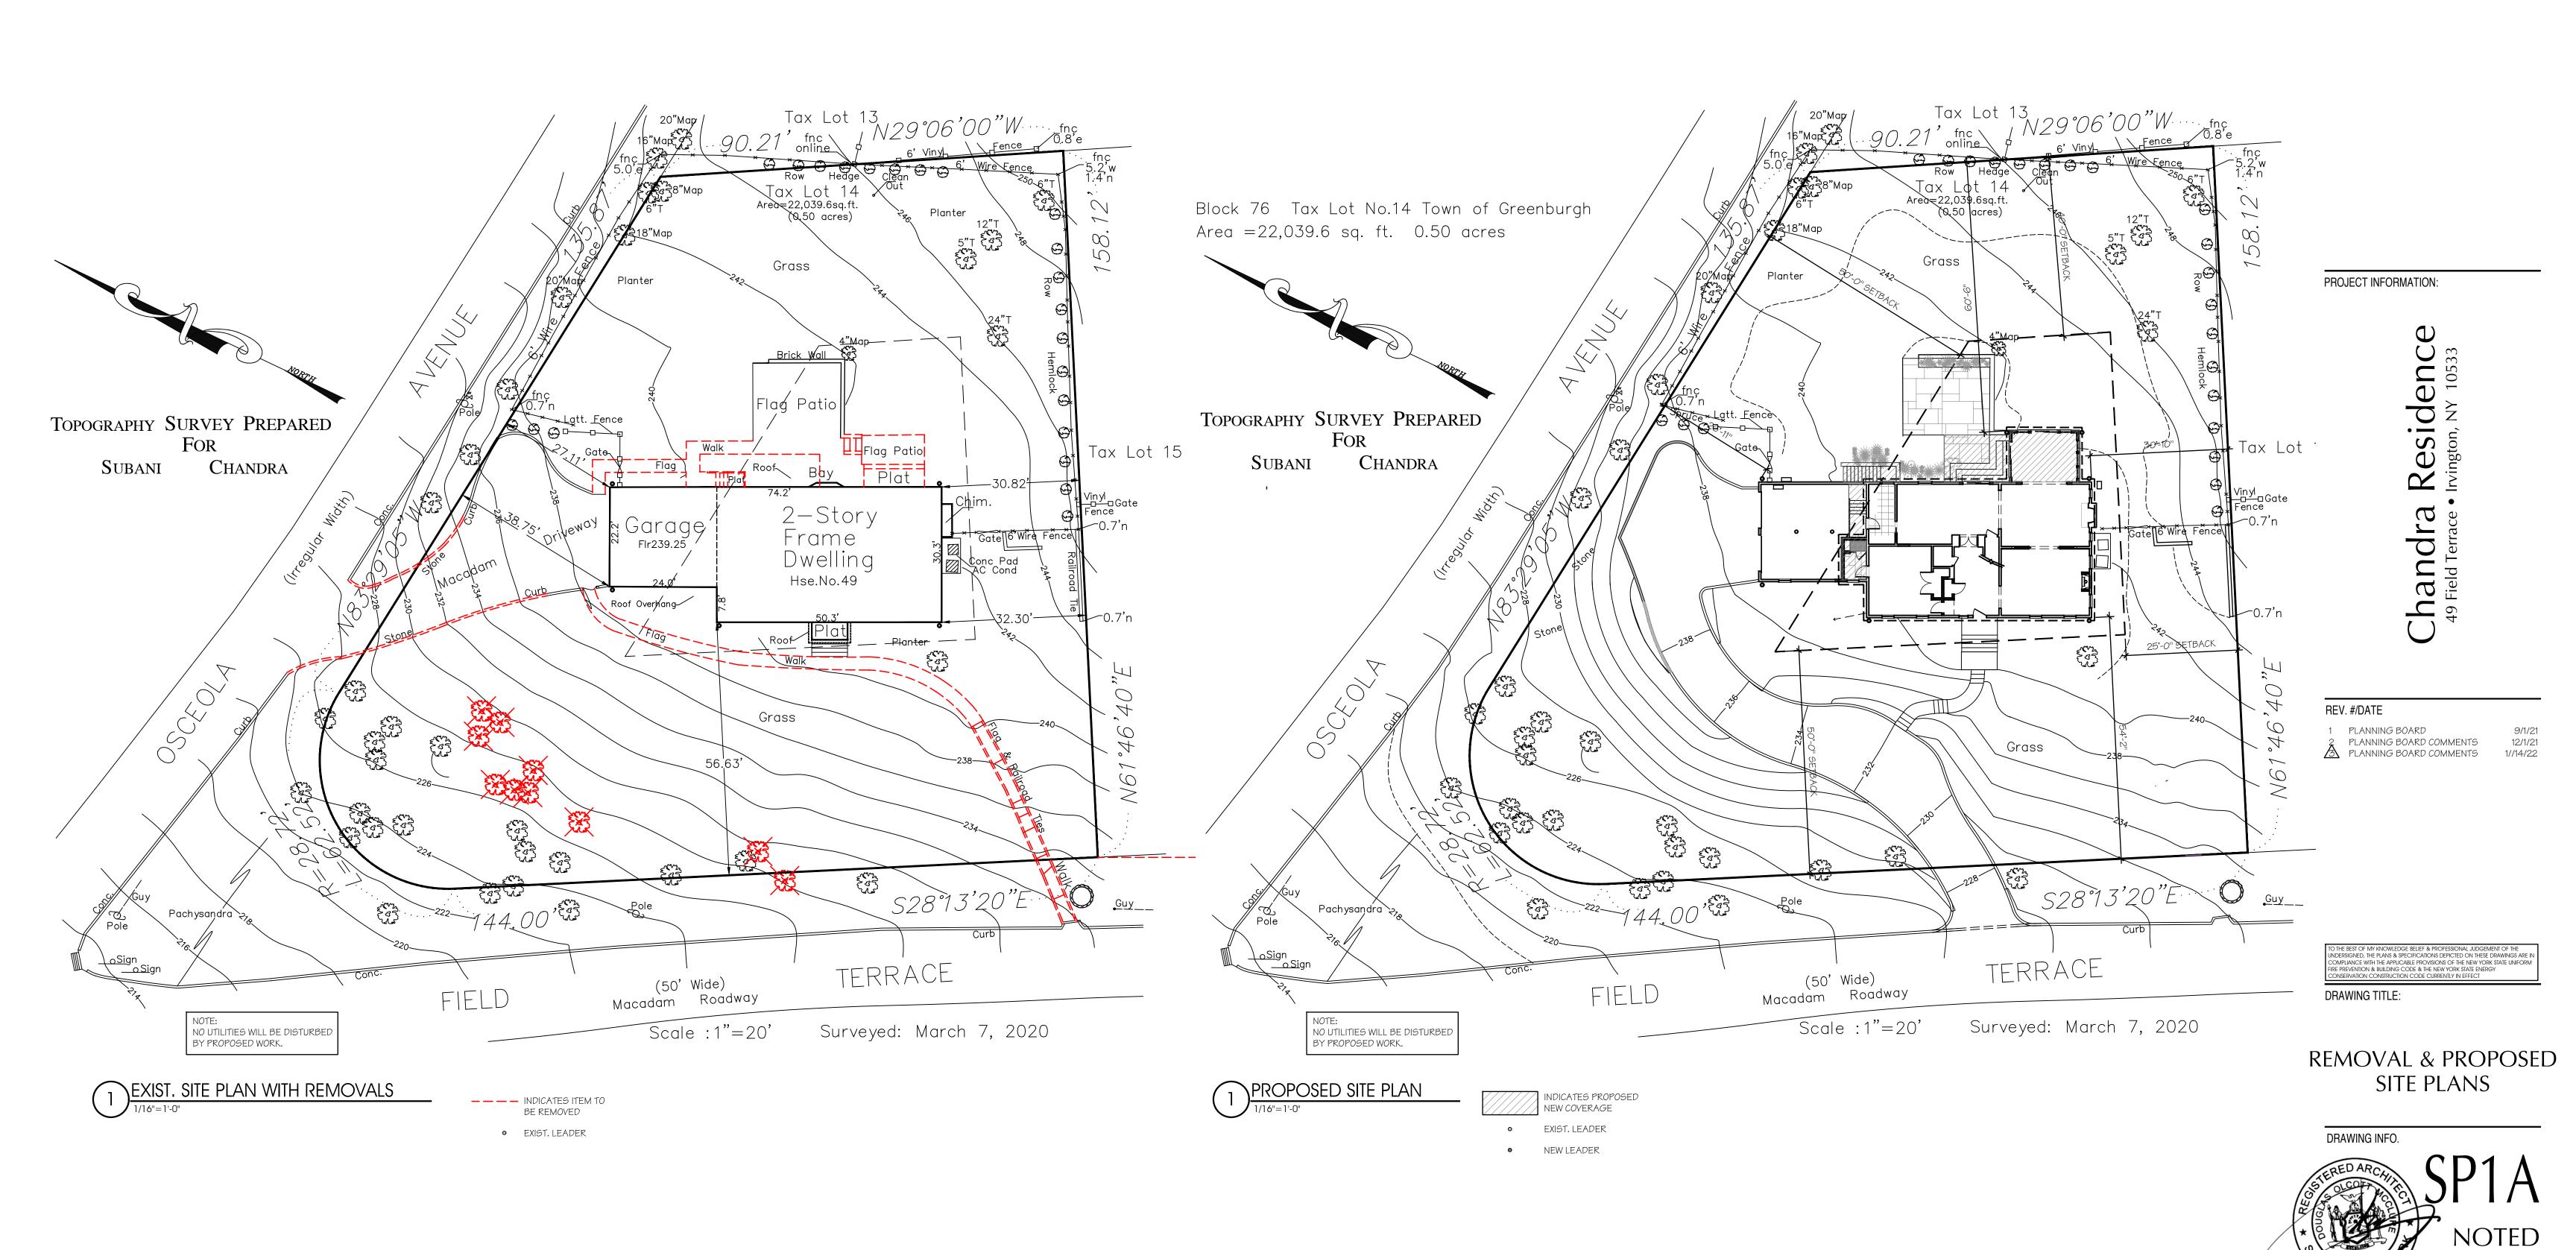

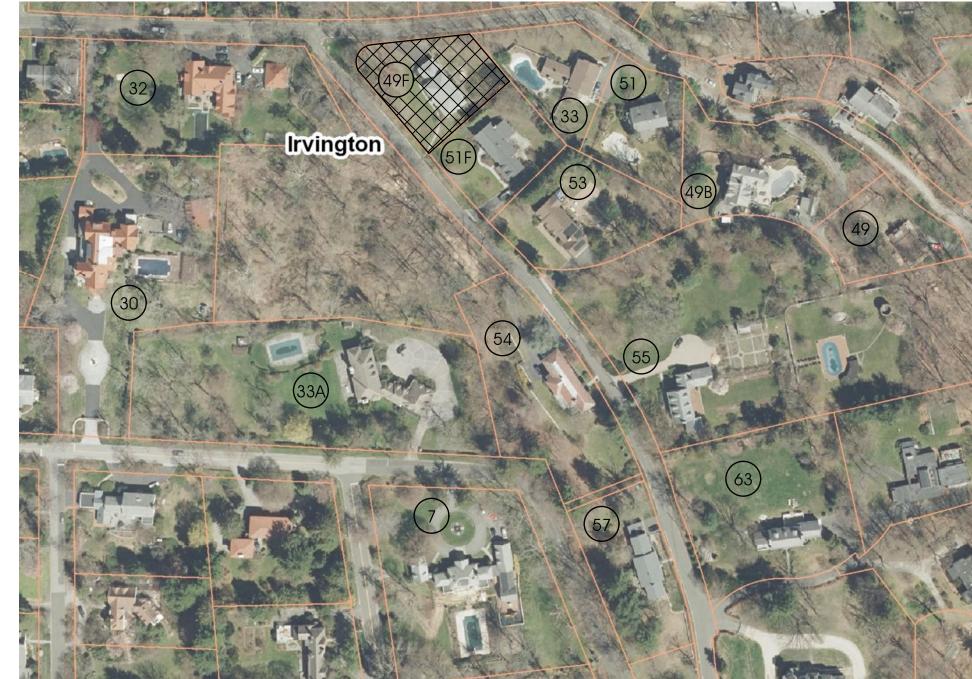

	Lot Information	Coverage*						
Key	Address	Parcel #	Area	Allowable	Existing	% Allowed	% of Lot	
30	30 OSCEOLA AVE.	2.170-76-39	66,647	5,886	8,138	138.26%	12.21%	
32	32 OSCEOLA AVE.	2.170-76-28	54,866	5,395	4,522	83.82%	8.24%	
33	33 OSCEOLA AVE.	2.170-76-13	20,473	2,457	5,953	242.29%	29.08%	
49	49 OSCEOLA AVE.	2.170-75-14	18,731	2,247	2,191	97.51%	11.70%	
49B	49B OSEOLA AVE.	2.170-76-11	35,284	4,234	6,068	143.32%	17.20%	
51	51 OSCEOLA AVE.	2.170.76.12	20,038	2,405	4,096	170.31%	20.44%	
49F	49 FIELD TERRACE	2.170-76-14	22,040	2,645	2,745	103.78%	12.45%	
51F	51 FIELD TERRACE	2.170-76-15	20,473	2,457	3,663	149.08%	17.89%	
53	53 FIELD TERRACE	2.170-76-16	30,056	3,606	4,454	123.52%	14.82%	
54	54 FIELD TERRACE	2.170-76-26	39,640	4,757	2,815	59.18%	7.10%	
55	55 FIELD TERRACE	2.170-76-19	133,294	8,532	17,195	201.54%	12.90%	
57	57 FIELD TERRACE	2.170-76-24	23,958	2,874	4,341	151.04%	18.12%	
63	63 FIELD TERRACE	2.170-76-20	51,197	5,248	3,916	74.62%	7.65%	
65	65 FIELD TERRACE	2.170-76-42	101,930	7,277	5,067	69.63%	4.97%	
33A	33 ARDSLEY AVENUE	2.170-76-40	87,991	6,720	6,764	100.65%	7.69%	
1	1 ARDSLEY AVENUE	2.170-80-6	39,640	5,883	6,172	104.91%	15.57%	
23	23 WASHINGTON AVE.	2.170-80-5	41,382	4,855	3,835	78.99%	9.27%	
19	19 WASHINGTON AVE	2.170-80-3.SD	81,026	6,441	6,991	108.54%	8.63%	

CONTEXT SCALE MAP AND COVERAGE CHART

N.T.S.

* COVERAGE NUMBERS DERIVED FROM GREENBURGH CAI PROPERTY CARDS, WHICH INCLUDE STRUCTURES ONLY. WHERE POSSIBLE, WALLS, TERRACES, AND PATHWAYS HAVE BEEN INCLUDED.

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NOTES:

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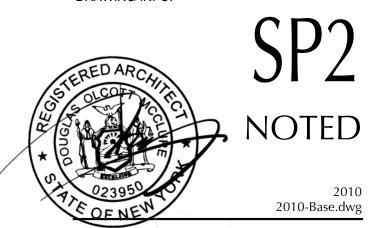
1 PLANNING BOARD 9/1/21 2 PLANNING BOARD COMMENTS 12/1/21 3 PLANNING BOARD COMMENTS 1//14/22

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DRAWING TITLE:

COVERAGE AND F.A.R.

DRAWING INFO.





EXISTING WALL TO BE REMOVED

EXISTING WINDOW TO BE REMOVED

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NOTE

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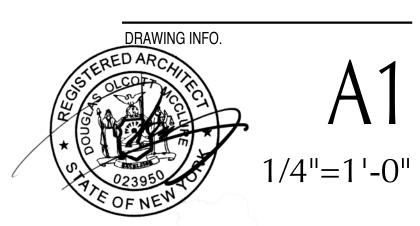
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DRAWING TITLE:

BASEMENT DEMOLITION PLAN



2010 2010-Base

PROPOSED EXTERIOR WALL, WOOD STUDS TO MATCH ADJACENT, R VALUE OF 21 OR MATCH ADJACENT, INTERIOR AND EXTERIOR FINISHES

TO MATCH

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DRAWING TITLE:

BASEMENT CONSTRUCTION PLAN

DRAWING INFO.




XI. DEMOLITION - CUTTING - PROTECTION:

- A. PROBE TO LOCATE UTILITIES OR STRUCTURE PRIOR TO REMOVING MATERIALS. DO ALL WORK SO AS NOT TO ENDANGER BUILDING STRUCTURE AND UTILITIES; PROVIDE TEMPORARY BRACES AND OTHER SUPPORTS AS MAY BE REQUIRED TO ASSURE THE SAFETY OF THE EXISTING CONSTRUCTION, WORKMEN, OCCUPANTS AND FINISHES.
- B. DO SUCH REQ'D WORK WITH CARE INCLUDING SHORING, BRACING, DUST PROTECTION, ETC. BE RESPONSIBLE FOR ANY DAMAGE WHICH MAY BE CAUSED BY SUCH WORK TO ANY PART OR PARTS OF EXISTING STRUCTURES OR ITEMS DESIGNATED FOR REUSE. PERFORM PATCHING, RESTORATION & NEW WORK AS
- C. DO NOT REMOVE ANY STRUCTURAL FRAMING WITHOUT APPROVAL BY ARCHITECT OR ENGINEER OF RECORD. EXISTING STUD FRAMING TO REMAIN UNLESS OTHERWISE INDICATED.
- D. DO NOT LOAD OR PERMIT ANY PART OF ANY STRUCTURE TO BE LOADED TO SUCH AN EXTENT AS TO ENDANGER ITS SAFETY.E. PROVIDE ADEQUATE FIRE PROTECTION IN ACCORDANCE WITH LOCAL FIRE
- DEPARTMENT REGULATIONS.

F. NO STRUCTURAL PARTS OF THE EXISTING BUILDING SHALL BE DAMAGED OR REMOVED.

SHORING NOTES:
G.C. TO PROVIDE ADEQUATE
TEMPORARY SHORING AND
BRACING AS REQQUIRED
DURING REMOVAL AND
REPLACEMENT OF EXISTING
BEARING WALLS, TO PREVENT
COLLAPSE AND/OR SHIFTING
OF EXISTING STRUCTURE.

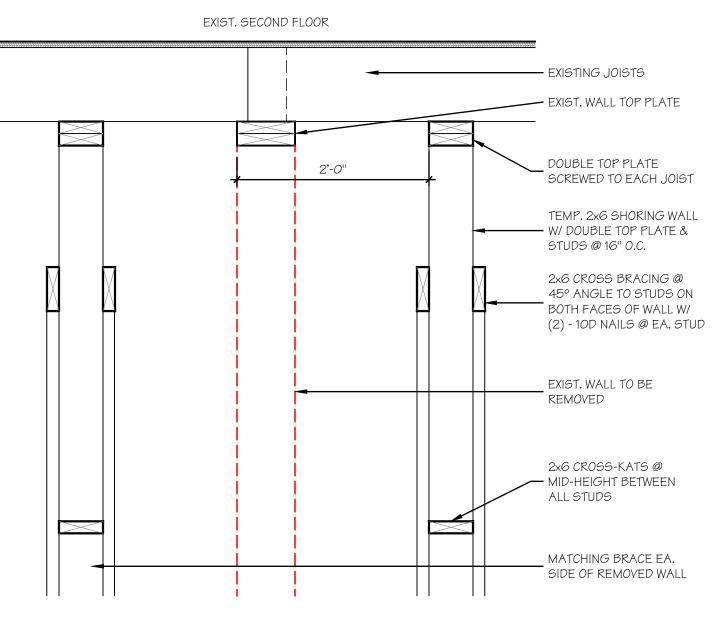

BRACING DIAGRAM

1"=1'-0"

PROJECT INFORMATION:

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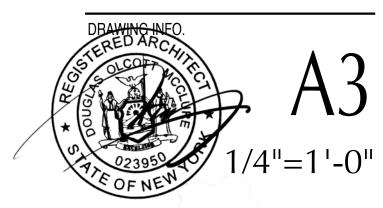
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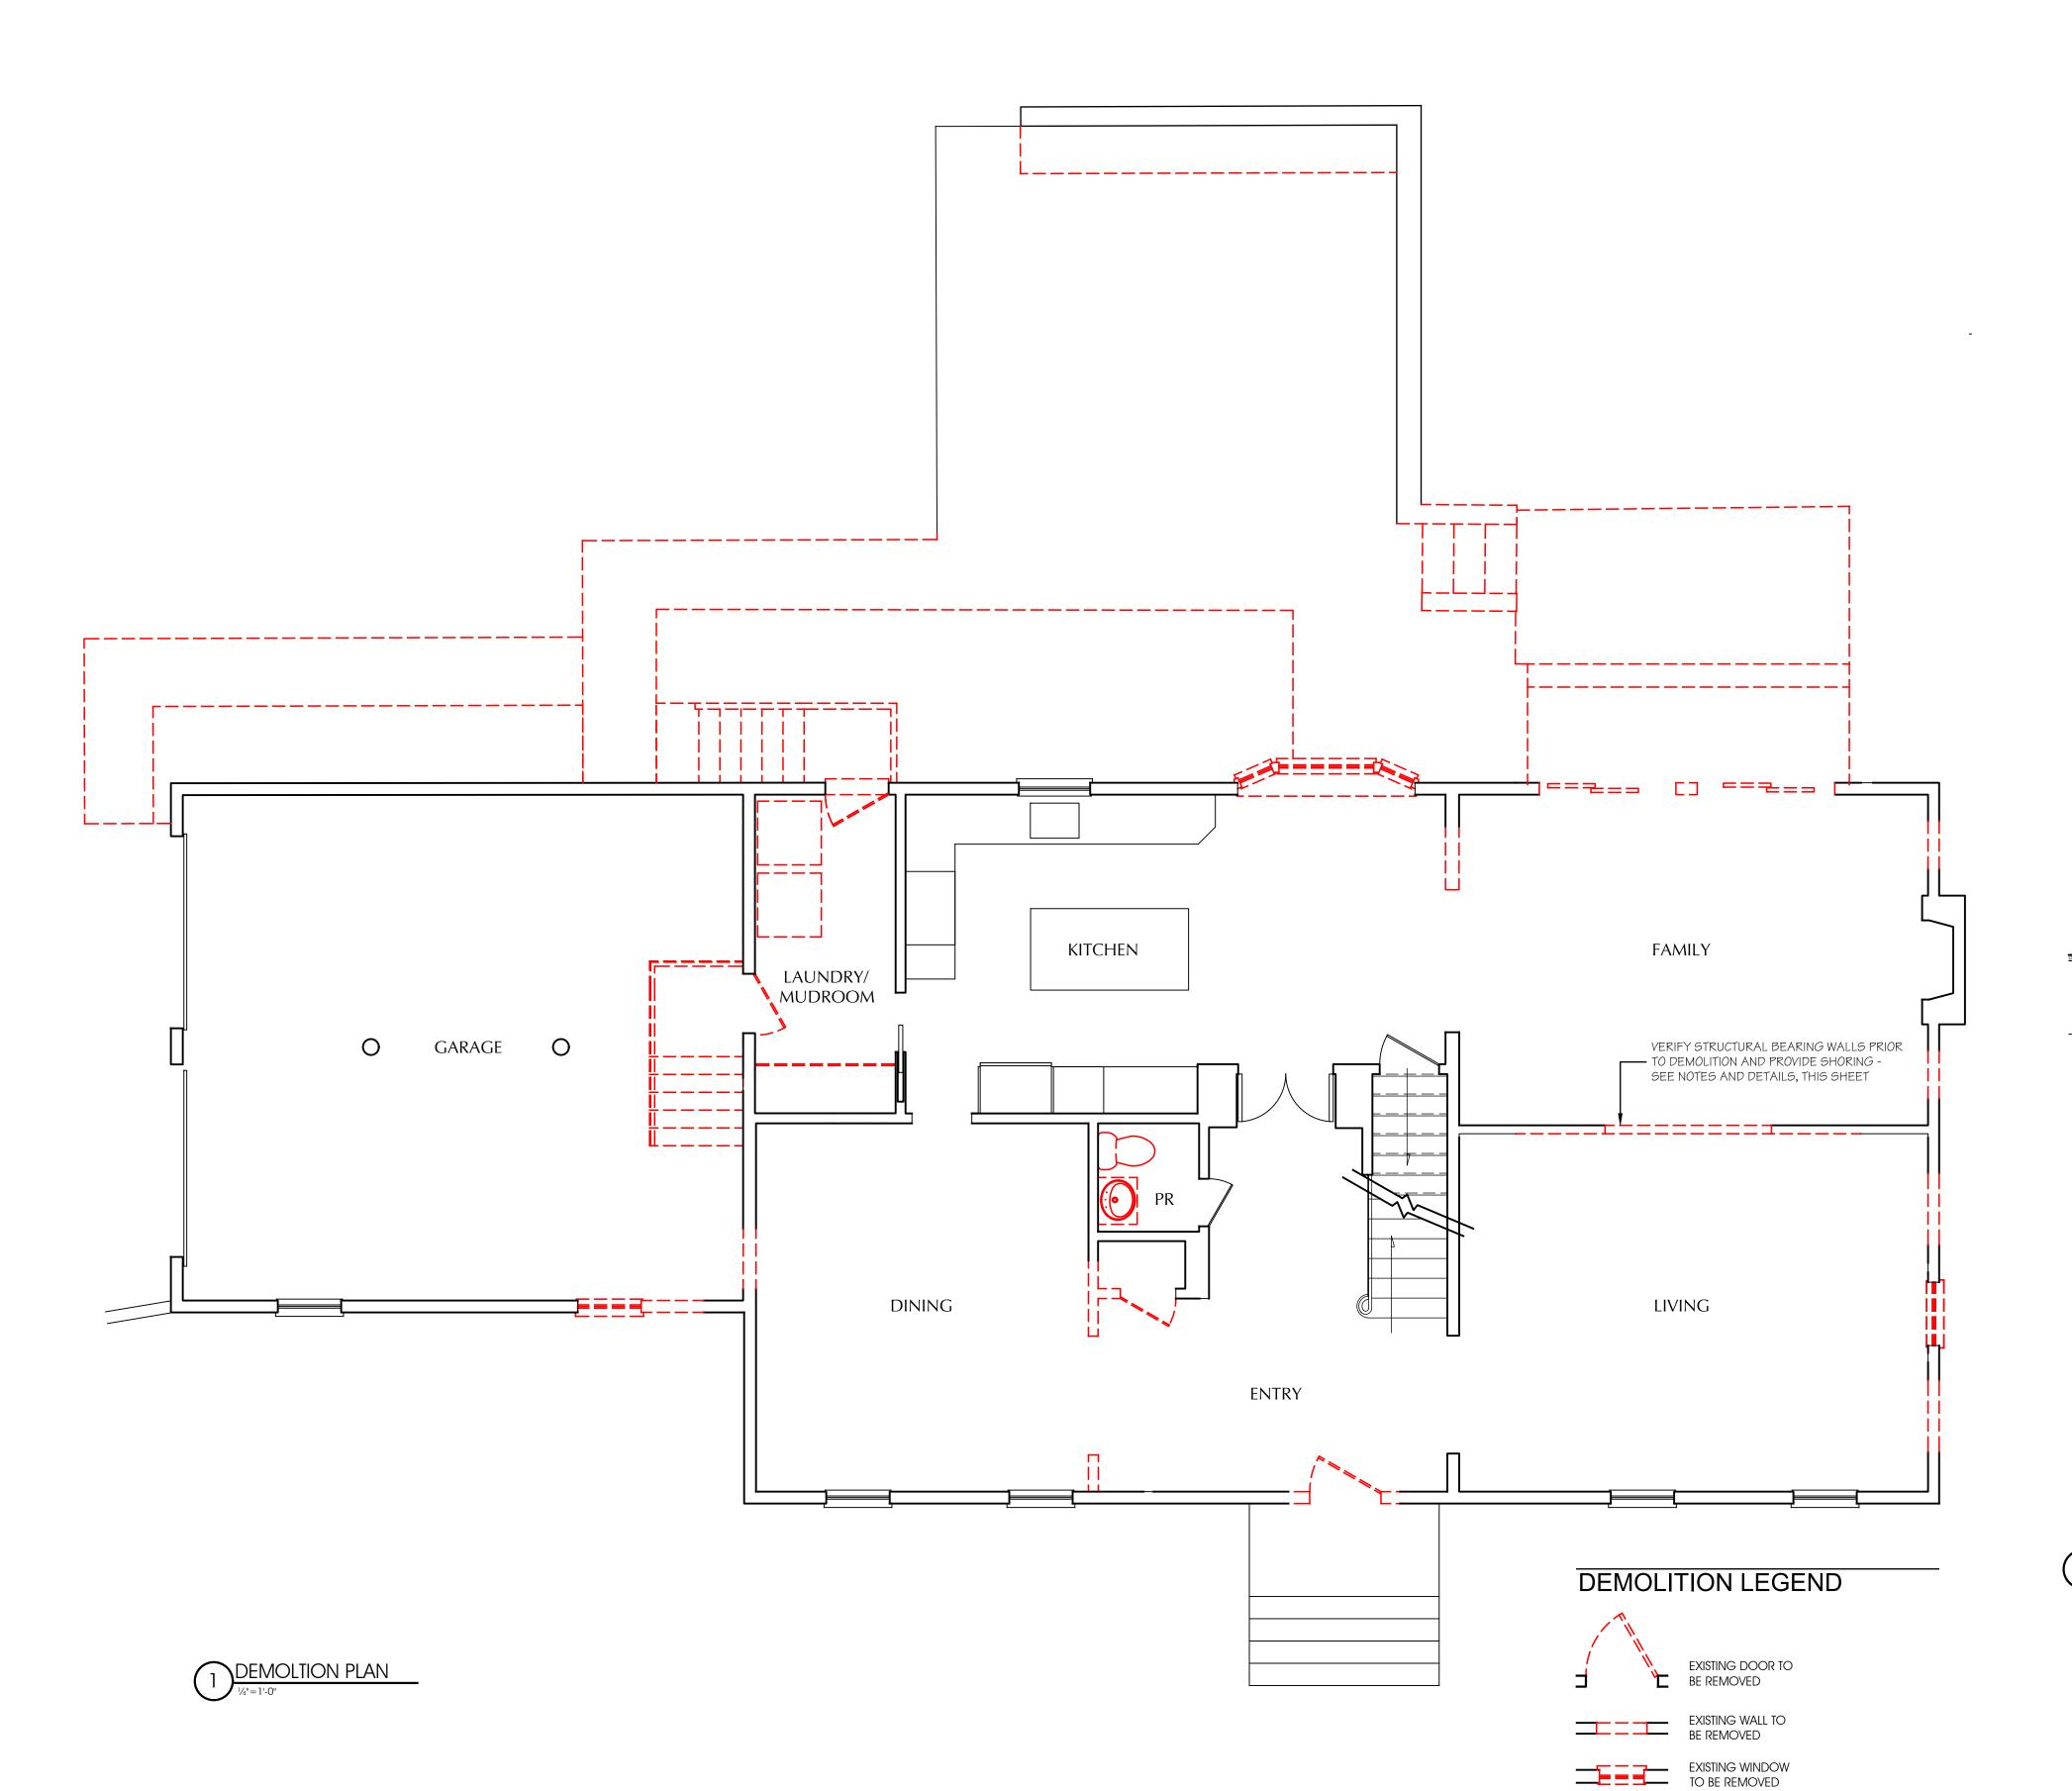
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DRAWING TITLE:

ENTRY FLOOR DEMO PLAN





NOTE:

SEE PLANS FOR ADDITIONAL
 INSTALL TWO STUDS AT ENDS OF EA. HEADER

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NOTE

PROJECT INFORMATION:

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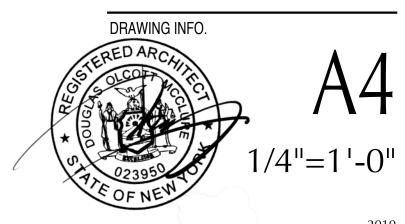
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ENTRY FLOOR PLAN





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NOTES:

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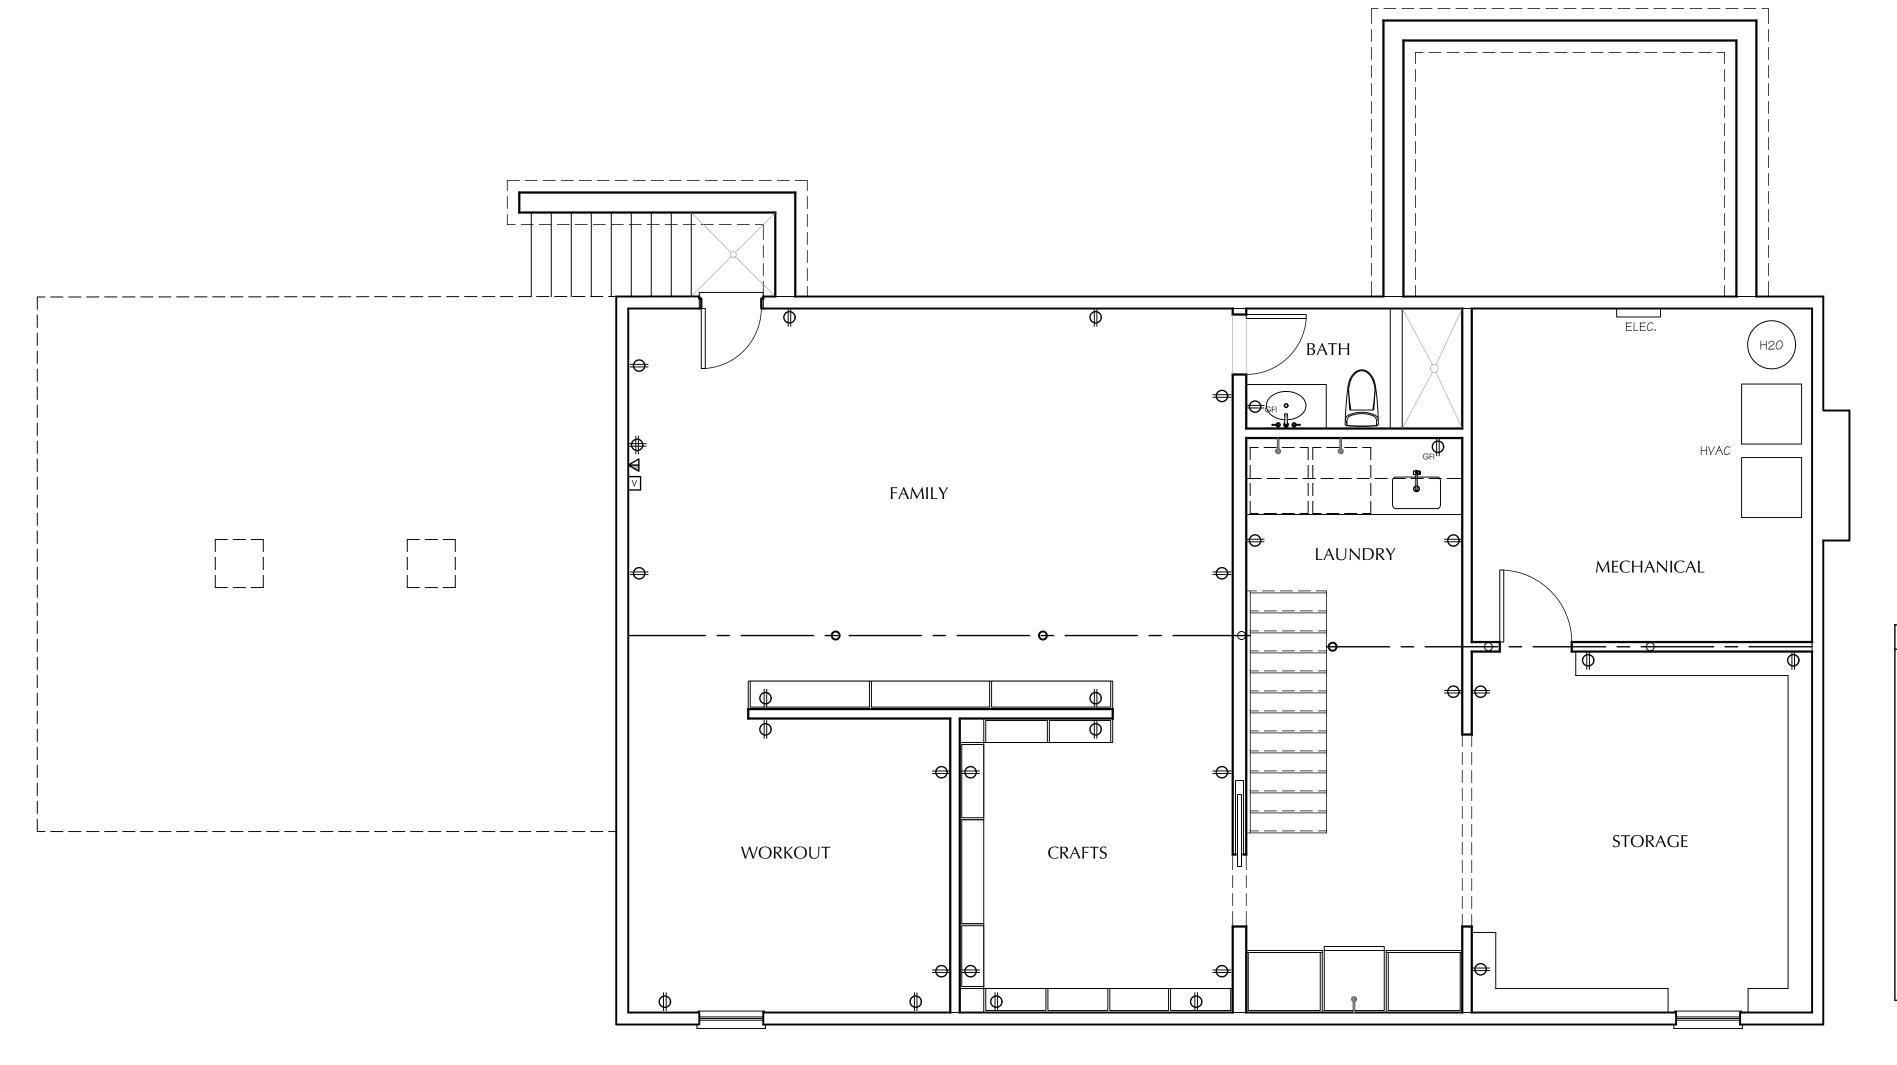
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DRAWING TITLE:

BUILDING SECTION



PROJECT INFORMATION:



POWER LEGEND

NOTE: ONLY NEW OUTLETS AND OTHER ELECTRICAL DEVICES ARE SHOWN.
EXISTING OUTLETS TO BE RECIRCUITED, REPLACED, OR ABANDONED AS
DIRECTED BY OWNER AND AS PER EXIST. NEW YORK STATE ELECTRICAL CODE

- DUPLEX ELECTRIC OUTLET MOUNTED @ 15" A.F.F. UNLESS OTHERWISE NOTED.
- G.F.I. OUTLET MOUNTED @ 42" A.F.F. UNLESS OTHERWISE NOTED
- DUPLEX ELECTRIC OUTLET WITH INTEGRATED USB MOUNTED

 @ 42" A.F.F. UNLESS OTHERWISE NOTED.
- WATERPROOF OUTLET
- QUAD OUTLET
- $f \Psi$ TELEPHONE/DATA OUTLET MOUNTED HORIZONTALLY PROVIDE 2 CAT 5E CABLES AT EACH LOCATION
- ▼ TELEVISION OR VIDEO CABLE OUTLET
- APPLIANCE HOOK UP VERIFY CONNECTION W/MANUFACTURE'S CUT

REV. #/DATE


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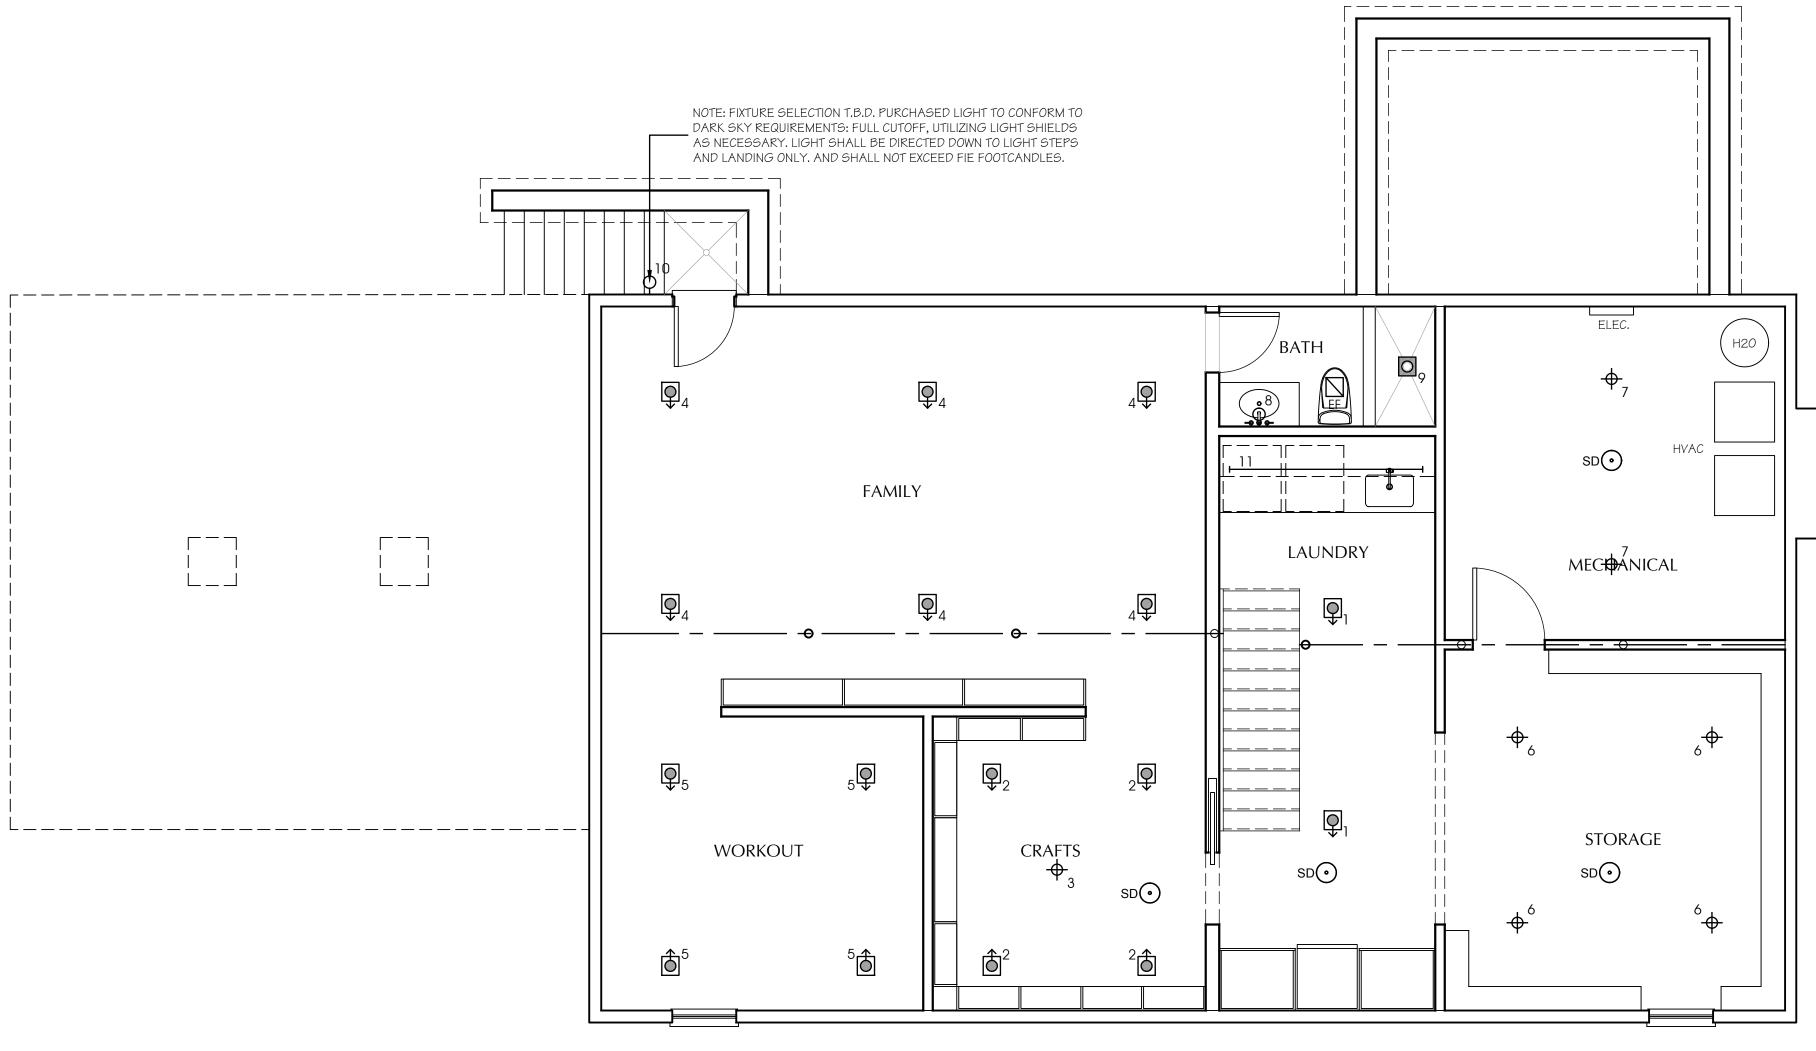
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DRAWING TITLE:

BASEMENT POWER PLAN

DRAWING INFO.



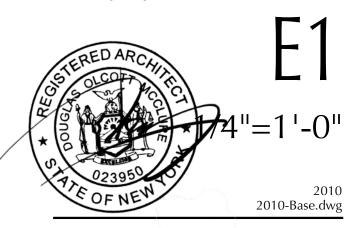

LEGEND: DIMMER SWITCH \$ DIMMER SWITCH SINGLE LOCATION LUTRON "CASETA" COLOR TO FOLLOW 3 OR 4 WAY DIMMER SWITCH LUTRON "CASETA" COLOR TO FOLLOW RECESSED ADJUSTABLE DOWN LIGHT MANUF: JUNO HOUSING: IC1RLEDT24 REMODEL HOUSING TRIM: 4RLA G2 06LM 30K 90CRI WFL 120 FRPC WH SIZE: 4" ROUND GIMBAL TRIM FINISH: WHITE LAMP: DIMMABLE LED, 600 LM, 2700K, NARROW FLOOD SURFACE MOUNTED DECORATIVE CEILING INCANDESCENT FIXTURE ON JUNCTION BOX - SUPPLIED BY OWNER - 100 WATTS SURFACE MOUNTED DECORATIVE WALL SCONCE INCANDESCENT FIXTURE - SUPPLIED BY OWNER - 100 WATTS SET MOUNTING HEIGHT IN FIELD WITH ARCHITECT. UNDERCABINET LIGHTING: RIBBONSTAR 24V LED STRIP LIGHT (OR 3 EQUAL), WARM WHITE (3000K), MOUNTED IN ALUM. CHANNEL RECESSED LENSED INCANDESCENT DOWNLIGHT - SHOWER LOCATIONS MANUF: JUNO HOUSING: IC1RLEDT24 REMODEL HOUSING TRIM: 4RLS DOWNLIGHT SIZE: 4" ROUND SURFACE MOUNT, LENSED LAMP: DIMMABLE LED, 800 LM, 3000K CLOSET LIGHT ON JAMB SWITCH MANUF: PROGRESSIVE LIGHTING MODEL: P3910-30WB, WHITE ETCHED OPAL ACRYLIC BOWL LAMP: 26 W CFL, WARM WHITE (2700 K) SD COMBINATION SMOKE/CO DETECTOR MANUF: KIDDE MODEL: #KN-COPE-1

MINIMUM 50% OF ALL FIXTURE LAMPS TO BE HIGH EFFICIENCY, AS PER NY STATE ENERGY CONSERVATION CODE.

EXHAUST FAN - SWITCH CONTROLLED - PANASONIC MODEL NO. FV-08V Q2(90CFM) - VENT TO EXTERIOR

COMBINATION SMOKE & CO DETECTORS SHALL BE INSTALLED THROUGHOUT THE DWELLING UNIT IN ACCORDANCE WITH NY STATE CODE. INCLUDING, BUT NOT LIMITED TO: OUTSIDE OF EACH SEPARATE AREA IN THE IMMEDIATE VICINITY OF THE BEDROOMS, & IN BASEMENT & RECREATION AREAS.

PROJECT INFORMATION:

REV. #/DATE

1 PLANNING BOARD 9/1/21
2 PLANNING BOARD COMMENTS 12/1/21
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DRAWING TITLE:

BASEMENT LIGHTING PLAN

DRAWING INFO.



NOTES:

PROJECT INFORMATION:

Chandra Residence
49 Field Terrace • Irvington, NY 10533

REV. #/DATE

POWER LEGEND

WATERPROOF OUTLET

QUAD OUTLET

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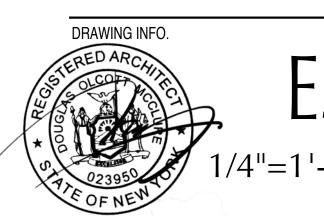
APPLIANCE HOOK UP - VERIFY CONNECTION W/MANUFACTURE'S CUT

▼ TELEVISION OR VIDEO CABLE OUTLET

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ENTRY FLOOR Power Plan



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NOTES

LEGEND: DIMMER SWITCH FIXTURE SYMBOL \$ DIMMER SWITCH SINGLE LOCATION LUTRON "CASETA" COLOR TO FOLLOW 3 OR 4 WAY DIMMER SWITCH LUTRON "CASETA" COLOR TO FOLLOW RECESSED ADJUSTABLE DOWN LIGHT MANUF: JUNO HOUSING: IC1RLEDT24 REMODEL HOUSING TRIM: 4RLA G2 06LM 30K 90CRI WFL 120 FRPC WH SIZE: 4" ROUND GIMBAL TRIM FINISH: WHITE LAMP: DIMMABLE LED, 600 LM, 2700K, NARROW FLOOD SURFACE MOUNTED DECORATIVE CEILING INCANDESCENT FIXTURE ON JUNCTION BOX - SUPPLIED BY OWNER - 100 WATTS SURFACE MOUNTED DECORATIVE WALL SCONCE INCANDESCENT FIXTURE - SUPPLIED BY OWNER - 100 WATTS SET MOUNTING HEIGHT IN FIELD WITH ARCHITECT. UNDERCABINET LIGHTING: RIBBONSTAR 24V LED STRIP LIGHT (OR EQUAL), WARM WHITE (3000K), MOUNTED IN ALUM. CHANNEL W/FROSTED LENS RECESSED LENSED INCANDESCENT DOWNLIGHT - SHOWER LOCATIONS MANUF: JUNO HOUSING: IC1RLEDT24 REMODEL HOUSING TRIM: 4RLS DOWNLIGHT SIZE: 4" ROUND SURFACE MOUNT, LENSED FINISH: WHITE LAMP: DIMMABLE LED, 800 LM, 3000K CLOSET LIGHT ON JAMB SWITCH MANUF: PROGRESSIVE LIGHTING MODEL: P3910-30WB, WHITE ETCHED OPAL ACRYLIC BOWL LAMP: 26 W CFL, WARM WHITE (2700 K) SD COMBINATION SMOKE/CO DETECTOR MANUF: KIDDE MODEL: #KN-COPE-1 EXHAUST FAN - SWITCH CONTROLLED - PANASONIC MODEL NO. FV-08V Q2(90CFM) - VENT TO EXTERIOR

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AREA IN THE IMMEDIATE VICINITY OF THE BEDROOMS, & IN BASEMENT &

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COMBINATION SMOKE & CO DETECTORS SHALL BE INSTALLED

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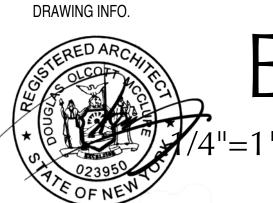
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DRAWING TITLE:

ENTRY FLOOR Lighting Plan



BUILDING CODE AND REFERENCE STANDARDS:

THE 2020 NEW YORK STATE RESIDENTIAL BUILDING CODE, AS ADOPTED AND MODIFIED BY THE LOCAL JURISDICTION SHALL GOVERN THE DESIGN AND CONSTRUCTION OF THIS PROJECT. REFERENCE TO A SPECIFIC SECTION IN THE CODE DOES NOT RELIEVE THE CONTRACTOR FROM COMPLIANCE WITH THE ENTIRE MATERIALS REFERENCE STANDARDS. THE LATEST EDITION OF THE MATERIALS REFERENCE STANDARDS SHALL BE USED.

GENERAL NOTES:

- THE CONTRACTOR SHALL VERIFY ALL CONDITIONS AT THE BUILDING SITE BEFORE COMMENCEMENT OF WORK
- ALL DIMENSIONS ARE TO ROUGH FRAMING
- CONTRACTOR SHALL RECEIVE, STORE AND PROTECT ALL MATERIALS DELIVERED TO THIS SITE FROM WEATHER AND DAMAGE.
- CONTRACTOR SHALL INSTALL ALL MATERIALS IN ACCORDANCE WITH THE MANUFACTURER'S SPECIFICATIONS.
- CONTRACTOR SHALL BE RESPONSIBLE FOR THE SITE CLEAN UP ON A DAILY BASIS
- THE CONTRACTOR SHALL MAINTAIN A SET OF APPROVED PLANS AT THE CONSTRUCTION SITE IN A SAFE PLACE FOR REVIEW BY THE MUNICIPALITY BUILDING INSPECTOR DURING CONSTRUCTION.
- ALL WORK SHALL BE DONE IN CONFORMANCE WITH THE PLANS AND SPECIFICATIONS.
- CONTRACTOR SHALL NOT SCALE DRAWINGS.
- USE GIVEN DIMENSIONS. CHECK DETAILS FOR APPROPRIATE LOCATION OF ALL ITEMS NOT DIMENSIONED.
- 10. ALL CONSTRUCTIONS IS SUBJECT TO INSPECTION BY THE BUILDING OFFICIAL. THE CONTRACTOR SHALL COORDINATE ALL REQUIRED INSPECTION WITH BUILDING OFFICIAL AND DOCUMENT FOR REVIEW AN INSPECTION REPORT.

FRAMING NOTES

- 1. ALL STRUCTURAL PRODUCTS SHALL BE IDENTIFIED BY GRADE MARK OR CERTIFICATE OF INSPECTION ISSUED BY CERTIFYING AGENCY.
- 2. FOR ALL OPENINGS NOT OTHERWISE NOTED, SCHEDULED OR DETAIL ON THE PLANS, HEADER SIZING SHALL FOLLOW THE SIZES LISTED ON HEADER TABLE.
- 3. WOOD FRAMING SHALL MAINTAIN 8" CLEARANCE ABOVE GRADE.
- . UNLESS OTHERWISE NOTED 2x4 COLLAR TIES SHALL BE INSTALLED AT THE TOP THIRD POINT OF EVERY OTHER ROOF RAFTER. CUT ENDS TO FIT SLOPE AND NAIL TO ADJACENT
- 5. NOTCH RAFTERS TO FIT EXTERIOR WALL PLATES AND TOE NAIL OR USE METAL FRAMING
- ANY OPENINGS IN ROOF FRAMING SHALL HAVE 2-PLY RAFTERS TO FORM HEADERS AND TRIMMERS AROUND ROOF OPENING AND SUPPORT WITH METAL HANGERS WHERE REQUIRED
- 7. WHERE RAFTERS ABUT AT RIDGE, PLACE DIRECTLY OPPOSITE EACH OTHER AND NAIL TO RIDGE MEMBER.
- 8. HIP AND VALLEY RAFTERS SHALL BE 2-PLY AND MINIMUM 2" DEEPER THAN ADJACENT RAFTERS UNLESS SIZE NOTED OTHERWISE. BEVEL ENDS OF JACK RAFTERS FOR FULL BEARING AGAINST VALLEY RAFTER.

CONCRETE NOTES:

- 1. STRUCTURAL CONCRETE STRENGTH SHALL BE f'c = 4,000 PSI WITH NORMAL WEIGHT AGGREGATE.
- 2. ALL CONCRETE MIXES SHALL COMPLY WITH THE REQUIREMENTS OF THE BUILDING CODE AND THE ACI 318. MIX DESIGNS FOR EACH TYPE AND STRENGTH SHALL BE PREPARED BY CONTRACTOR AND TESTED BY INDEPENDENT TESTING LABORATORY.
- 3. PORTLAND CEMENT SHALL CONFORM TO ASTM C150.
- 4. FLY ASH MAY BE USED IN CONCRETE MIXES, THE FLY ASH SHALL CONFORM TO
- 5. NORMAL WEIGHT AGGREGATE SHALL CONFORM TO THE REQUIREMENTS OF ASTM C33.
- 6. LIGHT WEIGHT AGGREGATE SHALL CONFORM TO THE REQUIREMENTS OF ASTM C330 AD ASTM C157.
- 7. CONCRETE FORMS SHALL BE LAID OUT AND CONSTRUCTED TO MEET DIMENSIONS REQUIRED ON PLANS.
- 8. REINFORCING BARS SHALL CONFORM TO THE REQUIREMENTS OF ASTM A615, GRADE 60. REINFORCING BARS, WHICH ARE TO BE WELDED, SHALL CONFORM TO APPLICABLE ASTM AND AWS SPECIFICATIONS.
- 9. ALL BARS AT NON-CONTINOUS ENDS SHALL HAVE A STANDARD HOOK.
- 10. ALL DOWELS SHALL BE FULLY DEVELOPED IN TENSION UNLESS OTHERWISE
- 11. ALL REINFORCING STEEL SHALL BE SECURELY HELD IN ORDER TO MAINTAIN ITS POSITION WHILE CONCRETE IS POURED. CHAIRS, TIES, SPACERS, ADDITIONAL BARS AND STIRRUPS, ETC. SHALL BE PROVIDED BY THE CONTRACTOR.
- 12. CONTRACTOR SHALL COORDINATE AND INSTALL ALL REQUIRED EMBEDDED ITEMS, SLEEVES, POCKETS, ETC PRIOR TO CONCRETE PLACEMENT.
- 13. MECHANICAL, ELECTRICAL OR OTHER BUILDING SERVICE ITEMS SHALL NOT PASS THROUGH CONCRETE BEAMS.

SLAB ON GRADE NOTES:

- 1. SLAB ON GRADE SHALL BE PLACED ON BACKFILL THAT SHALL BE COMPACTED TO A MINIMUM OF 95% MODIFIED PROCTOR VALUE WITH MAXIMUM DRY DENSITY IN ACCORDANCE WITH ASTM D1557.
- 2. A MINIMUM OF 6" THICK COMPACTED GRANULAR LAYER IS TO BE PLACED BELOW ALL GRADE SLABS. GRANULAR SHALL BE AS NOTED ON DETAILS OR AS APPROVED USING SAND-GRAVEL OR CRUSHED STONE.
- 3. A VAPOR BARRIER ACCORDING TO THE SPECIFICATIONS SHALL BE PLACED ABOVE THE COMPACTED GRANULAR LAYER PER DETAILS.

STRUCTURAL PERMIT PLANS FOR ADDITIONS AND ALTERATIONS:

DEMOLITION NOTES

- 1. DEMOLITION SHALL BE PERFORMED IN A SAFE AND ORDERLY MANOR AND IS RESPONSIBILITY OF CONTRACTOR TO ENSURE SAFE WORKING CONDITIONS.
- PRIOR TO ANY DEMOLITION THE IOBSITE SHALL BE VISITED BE DEMOLITION CONTRACTOR TO EXAMINE THE EXTENTS OF DEMOLITION. ANY AREAS OF DEMOLITION NOT DESCRIBED UNDER THIS DRAWING PACKAGE SHALL BE VERIFIED BY OWNER AND DESIGN PROFESSIONAL PRIOR TO ANY ADDITIONAL DEMOLITION.
- 3. ALL BUILDING MATERIAL AND DEBRIS SHALL BE REMOVED FROM SITE IN AN ORDERLY
- 4. EXCESSIVE QUANTITIES OF DEBRIS SHALL NOT BE PILED TOGETHER INSIDE THE STRUCTURE OR ON THE SURROUNDING PREMISES.
- 5. ALL DEMOLITION WORK SHALL CONFORM TO THE CURRENT LOCAL CODES.
- 6. PRIOR TO ANY DEMOLITION OF BUILDING SERVICES, THE PROPER UTILITIES SHOULD BE DISCONNECTED. COORDINATE WITH LOCAL UTILITY PROVIDERS AS REQUIRED.
- 7. ALL ELECTRICAL WORK SHALL BE COMPLETED UNDER THE SUPERVISION OF A LICENSED
- ELECTRICAL CONTRACTOR. 8. ALL PLUMBING WORK SHALL BE COMPLETED UNDER THE SUPERVISION OF A LICENSED
- 9. ALL SURFACES DAMAGED DURING THE DEMOLITION PROCESS SHALL BE REPAIRED AS NECESSARY.

TEMPORARY SHORING PROCEDURE NOTES:

PLUMBING CONTRACTOR

- 1. TEMPORARY SHORING SHALL BE PROVIDED FOR REMOVAL OF LOAD BEARING WALLS
- 2. SHORING SHALL CONSISTS OF 2x4 LUMBER AND SHORING SHALL BEAR DIRECTLY ONTO SOLID GROUND.
- 3. EXISTING SUPPORT COLUMNS SHALL NOT BE REMOVED UNTIL ALL TEMPORARY SHORING HAS BEEN PROPERLY INSTALLED.
- 4. CONTRACTOR SHALL BE RESPONSIBLE FOR MEANS AND METHODS OF CONSTRUCTION AND JOB RELATED SAFETY STANDARDS. CONTRACTOR SHALL BE AWARE AND RESPONSIBLE FOR STABILITY OF STRUCTURE AT ALL TIMES DURING CONSTRUCTION.

LUMBER NOTES

- ALL NOMINAL STRUCTURALLY GRADED LUMBER SHALL BE DOUGLAS FIR NO, 2, E 1,600,000 PSI OR AN APPROVED EQUIVALENT.
- LVL MEMBERS SHALL BE 'MICRO-LAM LVL' AS MANUFACTURED BY TRUSS JOIST CORPORATION, Fb = 2,600 PSI, E = 1,900,000 PSI OR AN APPROVED EQUIVALENT, U.N.O.
- 3. PSL MEMBERS SHALL BE 'PARALLAM PSL' AS MANUFACTURED BY TRUSS JOIST CORPORATION, Fb= 2900 PSI, Fb= 2900 PSI OR AN APPROVED EQUIVALENT.
- FLUSH FRAMED WOOD CONNECTIONS SHALL BE MADE WITH PREFABRICATED GALVANIZED STEEL HANGERS OF THE WIDTH AND DEPTH REQUIRED FOR THE SUPPORTED MEMBER. HANGERS SHALL BE SECURED WITH THE QUANTITY AND TYPE OF FASTENERS RECOMMENDED BY THE MANUFACTURER. (APPLIES TO EXISTING & NEW MEMBERS)
- BUILT-UP FRAMING MEMBERS SHALL HAVE ADIACENT PLIES NAILED TOGETHER WITH \ROWS OF NAILS AT 12" O.C. LUMBER SHALL BE NAILED WITH ROWS OF 10D COMMON NAILS WITH (2) NAILS PER ROW FOR 2x6 AND 2x8 AND (3) NAILS PER ROW FOR 2x10 AND 2x12. LVL MEMBERS SHALL BE NAILED WITH ROWS OF 16D COMMON NAILS WITH (2) NAILS PER ROW FOR 7' AND SHALLOWER MEMBERS, (3) NAILS PER ROW FOR 93'4 TO 11 W DEPTH MEMBERS, AND (4) NAILS PER ROW FOR 14' TO 16' DEPTH MEMBERS. U.N,O.
- PROVIDE TWO STUDS AT EACH END OF ALL FLUSH FRAMED HEADERS AND BEAMS UNLESS MORE ARE INDICATED ON PLAN. PROVIDE A JACK STUD AND A KING STUD AT EACH END OF ALL DROPPED HEADERS AND BEAMS UNLESS MORE ARE INDICATED ON PLAN.
- 7. FLOOR AND ROOF OPENINGS SHALL BE FRAMED WITH DOUBLE MEMBERS, UNLESS OTHERWISE NOTED IN PLAN. FLOOR IOISTS WHICH SUPPORT NON-LOAD BEARING PARTITIONS WHICH SPAN PARALLEL TO THE JOISTS SHALL BE DOUBLED AND BRIDGING SHALL BE PROVIDED AT A MAXIMUM SPACING OF 8'-0' O.C. IN ALL FLOOR FRAMING,
- 8. ALL WOOD EXPOSED TO THE WEATHER OR IN CONTACT WITH MASONRY SHALL BE PRESSURE TREATED.
- 9. PLYWOOD SHALL CONFORM TO THE U.S. DEPT. OF COMMERCE DOC PS-1 AND BEAR THE APA GRADE TRADEMARK OF THE AMERICAN PLYWOOD ASSOCIATION. PLYWOOD SHEATHING FOR FLOORS, ROOFS, & WALLS SHALL BE OF THICKNESS INDICATED, EXPOSURE 1.
- 10. HEADERS AT EXTERIOR WALLS SHALL BE MINIMUM (2) 2x10, U.N.O.
- 11. ALL WOOD PLACED IN CONTACT WITH CONCRETE OR MASONRY SHALL BE PRESSURE
- 12. PRIOR TO THE ISSUANCE OF A CERTIFICATE OF COMPLIANCE A TRUSS IDENTIFICATION SIGN SHALL BE FIXED AT THE ELECTRICAL METER STATING THAT THIS STRUCTURE UTILIZES TRUSS TYPE, PRE-ENGINEERED WOOD AND/OR TIMBER CONSTRUCTION. SIGN SHALL BE A PERMANENT, NON-FADING WEATHER RESISTANT STICKER OR DECAL.

FOUNDATION NOTES:

- 1. ALL FOUNDATIONS, FOOTINGS AND SLABS SHALL BEAR ON UNDISTURBED, NON-ORGANIC MATERIALS, COMPACTED STRUCTURAL FILL OR CRUSHED STONE.
- 2. THE GENERAL CONTRACTOR SHALL CONFORM TO THE REQUIREMENTS OF OSHA REGARDING OPEN HOLES, SLOPE STABILITY AND EXCAVATION PROCEDURES.
- 3. ALL FOUNDATION FOOTINGS SHALL BE MINIMUM 3'-6" OR MORE BELOW FINISHED GRADE.
- 4. BACKFILLING OF FOUNDATIONS SHALL NOT EXCEED MORE THAN 2'-0" UNBALANCED BACK FILL CONDITIONS WITHOUT TEMPORARY SHORING OF FOUNDATIONS WALLS, UNLESS FLOOR SYSTEM HAS BEEN FRAMED OR DECKED.
- 5. WHEREVER BEDROCK IS ENCOUNTERED THE ROCK SHALL BE REMOVED TO 2'-0" BELOW BOTTOM OF FOOTINGS OR 1;-0" BELOW BOTTOM OF SLAB AND RESTORED IN 8" LIFTS OF COMPACTED CRUSHED STONE.
- 6. A GEOTECHNICAL EXPLORATION AND TESTING HAS NOT BEEN UNDERTAKEN. IT IS RESPONSIBILITY OF OWNER OR CONTRACTOR TO UNDERTTAKE ANY ADDITIONAL TEST PITS, BORINGS OR INVESTIGATION AS NECESSARY TO ASSURE MINIMUM BEARING CAPACITY.

DESIGN LOADS: $\overline{\text{LIVE LOAD}} = 40 \, \overline{\text{PSF}}$

DEAD LOAD = 20 PSFROOFLIVE = 20 PSFROOF (SNOW) = 30 PSF

ALLOWABLE DEFLECTION = L/360

49 FIELD TERRACE IRVINGTON, NY 10533

NAILING SCHEDULE:

- 1. JOIST TO SILL OR GIRDER (3) 8D
- 2. BRIDGING TO JOIST, TOE NAIL EACH END (2) 8D
- 3. LEDGER STRIP THREE 16d AT EACH JOIST
- 4. SUB-FLOORING, SIX INCHES WIDE OR LESS TO EACH JOIST FACE NAIL-
- 5. SOLE PLATE TO JOIST OR BLOCKING, FACENAIL 16D AT 16" O.C.
- 6. TOP PLATE TO STUD, END NAIL (2) 16D
- 7. STUD TO SOLE PLATE, TOE NAIL (4) 8D OR (3) 16D
- 8. DOUBLE STUDS, FACENAIL 10D AT 16"O.C.
- 9. DOUBLE TOP PLATES, FACENAIL- 10D AT 16" O.C.
- 10. TOP PLATES, LAP AND INTERSECTIONS, FACENAIL (2) 10D
- 11. ROOF RAFTERS TO RIDGE, VALLEYS OR HIP RAFTERS, TOE NAIL (3) 16 FACE NAIL THREE 16D
- 12. RIM JOIST TO TOP PLATE, TOE NAIL 8D AT 6" O.C.
- 13. CONTINUOUS HEADER, 16D AT 16" O.C.
- 14. CEILINGS JOISTS TO PLATE, TOENAIL (3) 16D
- 15. CONTINUOUS HEAD TO STUD, TOENAIL (4) 8D
- 16. CEILING JOISTS, LAPS OVER PARTITIONS, FACENAIL (3) 10D
- 17. CEILING JOISTS TO PARALLEL RAFTERS, FACENAIL (3) 10D
- 18. RAFTER TO PLATE, TOENAIL (3) 16D
- 19. BRACE ONE INCH TO EACH STUD AND PLATE, FACENAIL (3)8D
- 20. SHEATHING AND SUB-FLOORING, 1 INCH BY UP TO 8 INCH, EACH BEARING FACENAIL -(3) 8D
- 21. SHEATHING AND SUB-FLOORING, WIDER THAN ONE INCH B MORE THAN 8INCH EACH BEARING FACENAIL (3)8D

DOUBLE TOP

(2)16D -

SCALE: NTS

MAX. HOLE

1-1/2

OUTER 1/3 MOF SPAN

ALLOWED

MINIMUM-

NAIL SIZE

SCALE: NTS

SIMPSON ST

DOUBLE 2x4

2x4 KING STUD

STUDS, MINIMUM

JOIST SIZE

2x12

REFER TO PLANS

FOR DIMENSIONS

TIE AT EACH END

STRAP TIE

- 22. BUILT-UP CORNER STUDS 16(D) AT 16"O.C.
- 23. BUILT-UP GIRDERS AND BEAMS 10D, NAIL EACH 2" LUMBER LAYER AT

SIMPSON ST

PLATE

STRAP TIE

HEADER DETAIL

GUIDE TO NOTCHING AND BORING JOISTS

MAX. NOTCH DEPTH

1-1/4

1-1/2

MIDDLE 1/3 MOF SPAN

PENETRATIONS

12"

BEAM NAILING DETAIL

SCALE: NTS

BEAM/HEADEI

MAX. END NOTCH

1-3/8

1-7/8 2-3/8

2-7/8

OUTER 1/3 MOF SPAN

REFER TO PLANS

16 D NAILS

LEDGER LOK FLAT HEAD

EASTENER FOR LEDGER

FOR USE AS ALTERNATE


CONNECTION

TRUCTURAL SCREWS APPROV


FOR DIMENSIONS

NOTE: D = DEPTH OF JOIST (IN.)


- 24" O.C. ALONG EACH EDGE AND STÄGGERED
- 24. COLLAR TIES TO RAFTERS FACE NAIL (4) 8D

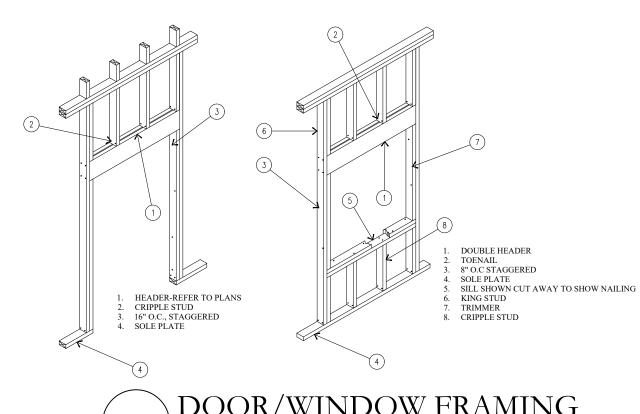

DOOR/WINDOW FRAMING SCALE: NTS

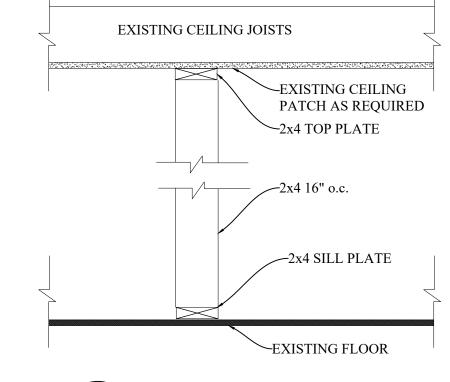

TEMPORARY SHORING SCALE: NTS

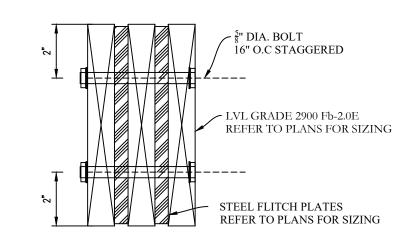

FLITCH PLATE DETAIL

SCALE: NTS

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361 Route 202 - Suite #7 Somers, NY 10589

PROPERTY INFORMATION: PREPARED BY: JMS ENGINEERING SERVICES, PC PROIECT LOCATION: 49 FIELD TERRACE PROJECT VILLAGE: IRVINGTON BUILDING DEPARTMENT: IRVINGTON PROPERTY IDENTIFICATION: 2.170-76-14 OCCUPANCY: SINGLE FAMILY DWELLING ZONING CODE: 1F-40

CHECKED: APPROVED IMS 07/12/2021

SEAL & SIGNATURE



JOHN M. SCAVELLI PE LICENSE # 095178 JMS ENGINEERING SERVICES, PC

IT IS A VIOLATION OF STATE LAW FOR ANY PERSON UNLESS DIRECTED BY A REGISTERED ARCHITECT OR PROFESSIONAL ENGINEER TO ALTER THIS ITEM IN ANY WAY.

PROJECT:

49 Field Terrace Irvington, NY 10533

DRAWING TITLE:

STRUCTURAL SHEET

S-101

NOTES:

