

TRANSMITTAL

To:	Village of Irvington			
	Building Department			

85 Main Street Irvington, NY 10533 From: Sean Jancski, RLA, ASLA, LEED-AP

32 Elm Place – Suite 1N Rye, New York 10580

Date: 10/03/22 Pages: 6

RE: 33 Park Rd In-Ground Pool Application

2.130-64-18

□ As Requested □ Urgent □ For Review/Comment □ For Pricing □ For Your Use

QTY	DWG	ENCLOSURE	<u>DATE</u>	REVISION	<u>NOTES</u>
1	LS-0	Existing Conditions Plan	08/24/22	N/A	By TC Merritts Land Surveyors
1	LS-1	Site Development Plan	08/24/22	N/A	By SJLA
1	LS-2	Landscape Screening Plan	08/24/22	N/A	By SJLA
1	LS-3	Site Details	08/24/22	N/A	By SJLA
1	C-1	Drainage Site Plan	08/11/22	N/A	By Benedict Salanitro
1	C-2	Drainage Details	08/11/22	N/A	By Benedict Salanitro

Please feel free to call (914) 967-1904 or email me anytime to discuss.

Sincerely, Sean Jancski

APPLICATION FOR BUILDING PERMIT

The Village of Irvington | 85 Main St | Irvington NY 10533

Application Number:	790	Date:	09/29/2022
Job Location:	33 PARK RD	Parcel ID:	2.130-64-18
Property Owner:	Tom Schirmacher	Property Class:	1 FAMILY RES
Occupancy:	One/ Two Family	Zoning:	
Common Name:			

Applicant	Contractor	
Sean Jancski	Wayne Clee	
Sean Jancski Landscape Architects	Shoreline Pools Inc.	
32 Elm Place Suite 1NRye NY 10580	393 West Ave Stamford CT 06902	
9149671904	2039671203	

Description of Work

Type of Work:	Swimming pool	Applicant is:	Architect
Work Requested by:	The Owner	In association with:	
Cost of Work (Est.):	150000.00	Property Class:	1 FAMILY RES

Description of Work

In-ground Swimming pool with integrated spa and associated masonry, pergola, landscaping and site work

Please Note: Completing the application does not constitute a permit to commence construction. To obtain your permit follow the instructions on the instruction page provided on page 3.

Job Location: 33 PARK RD

Parcel Id: 2.130-64-18

AFFIDAVIT OF APPLICANT

I Sean Jancski being duly sworn, depose and s with offices at: 32 Elm Place Suite 1N Rye NY	ays: That s/he does business as: 10580 and that s/he is:	Sean Jancski Landscape Architects
The owner of the property described her		with offices at:
	duly authorized by reso	olution of the Board of Directors, and that
said corporation is duly authorized by the	e owner to make this application.	
A general partner of	uner to make this application. rized by the owner to make this a d by the owner to make this appl	pplication
That the information contained in this application knowledge and belief. The undersigned here Uniform Fire Prevention and Building Code, laws pertaining to same, in the construction as Sworn to before me this	ation and on the accompanying d eby agrees to comply with all the the Village of Irvington Building C	requirements of the New York State Code, Zoning Ordinance and all other on plans or specify in this application.
OWNER'S AUTHORIZATION	y Commission Expires 00-10-2020	
I Tom Schirmacher as the owner of the subject work under the subject application.	premises and have authorized th	e contractor named above to perform the
Owner phone number 310-717-6429 Thomas W. Sch.: mache to ensure that if the permit (if issued) reconstruction further that if a Final Certificate of Approximation may be placed on the property. Sworn to before me this Notary Public / Commission of Deeds	Thereby acknowledge that it is seives a Final Certificate of Approval is not obtained upon completi for which this permit is being requal and of of of	my responsibility as the property owner eval from the Building Department and on of the construction, a property uested.

LIM KIM A.

Notary Public, State of New York
No. 01L16144154

Qualified in Westchester County
Commission Expires Apr. 24, 20_--6

VILLAGE OF IRVINGTON

PLANNING BOARD

85 MAIN STREET IRVINGTON, NEW YORK 10533

Tel: (914) 591-8335 • Fax: (914) 591-5870





View of yard screening facing North

View of driveway facing North-East







View of screening facing North-West

VILLAGE OF IRVINGTON

PLANNING BOARD

85 Main Street Irvington, New York 10533 Tel: (914) 591-8335 • Fax: (914) 591-5870





View of yard screening from porch facing North



View of screening facing East





View of yard screening facing West




View of brick garden screening facing North-West



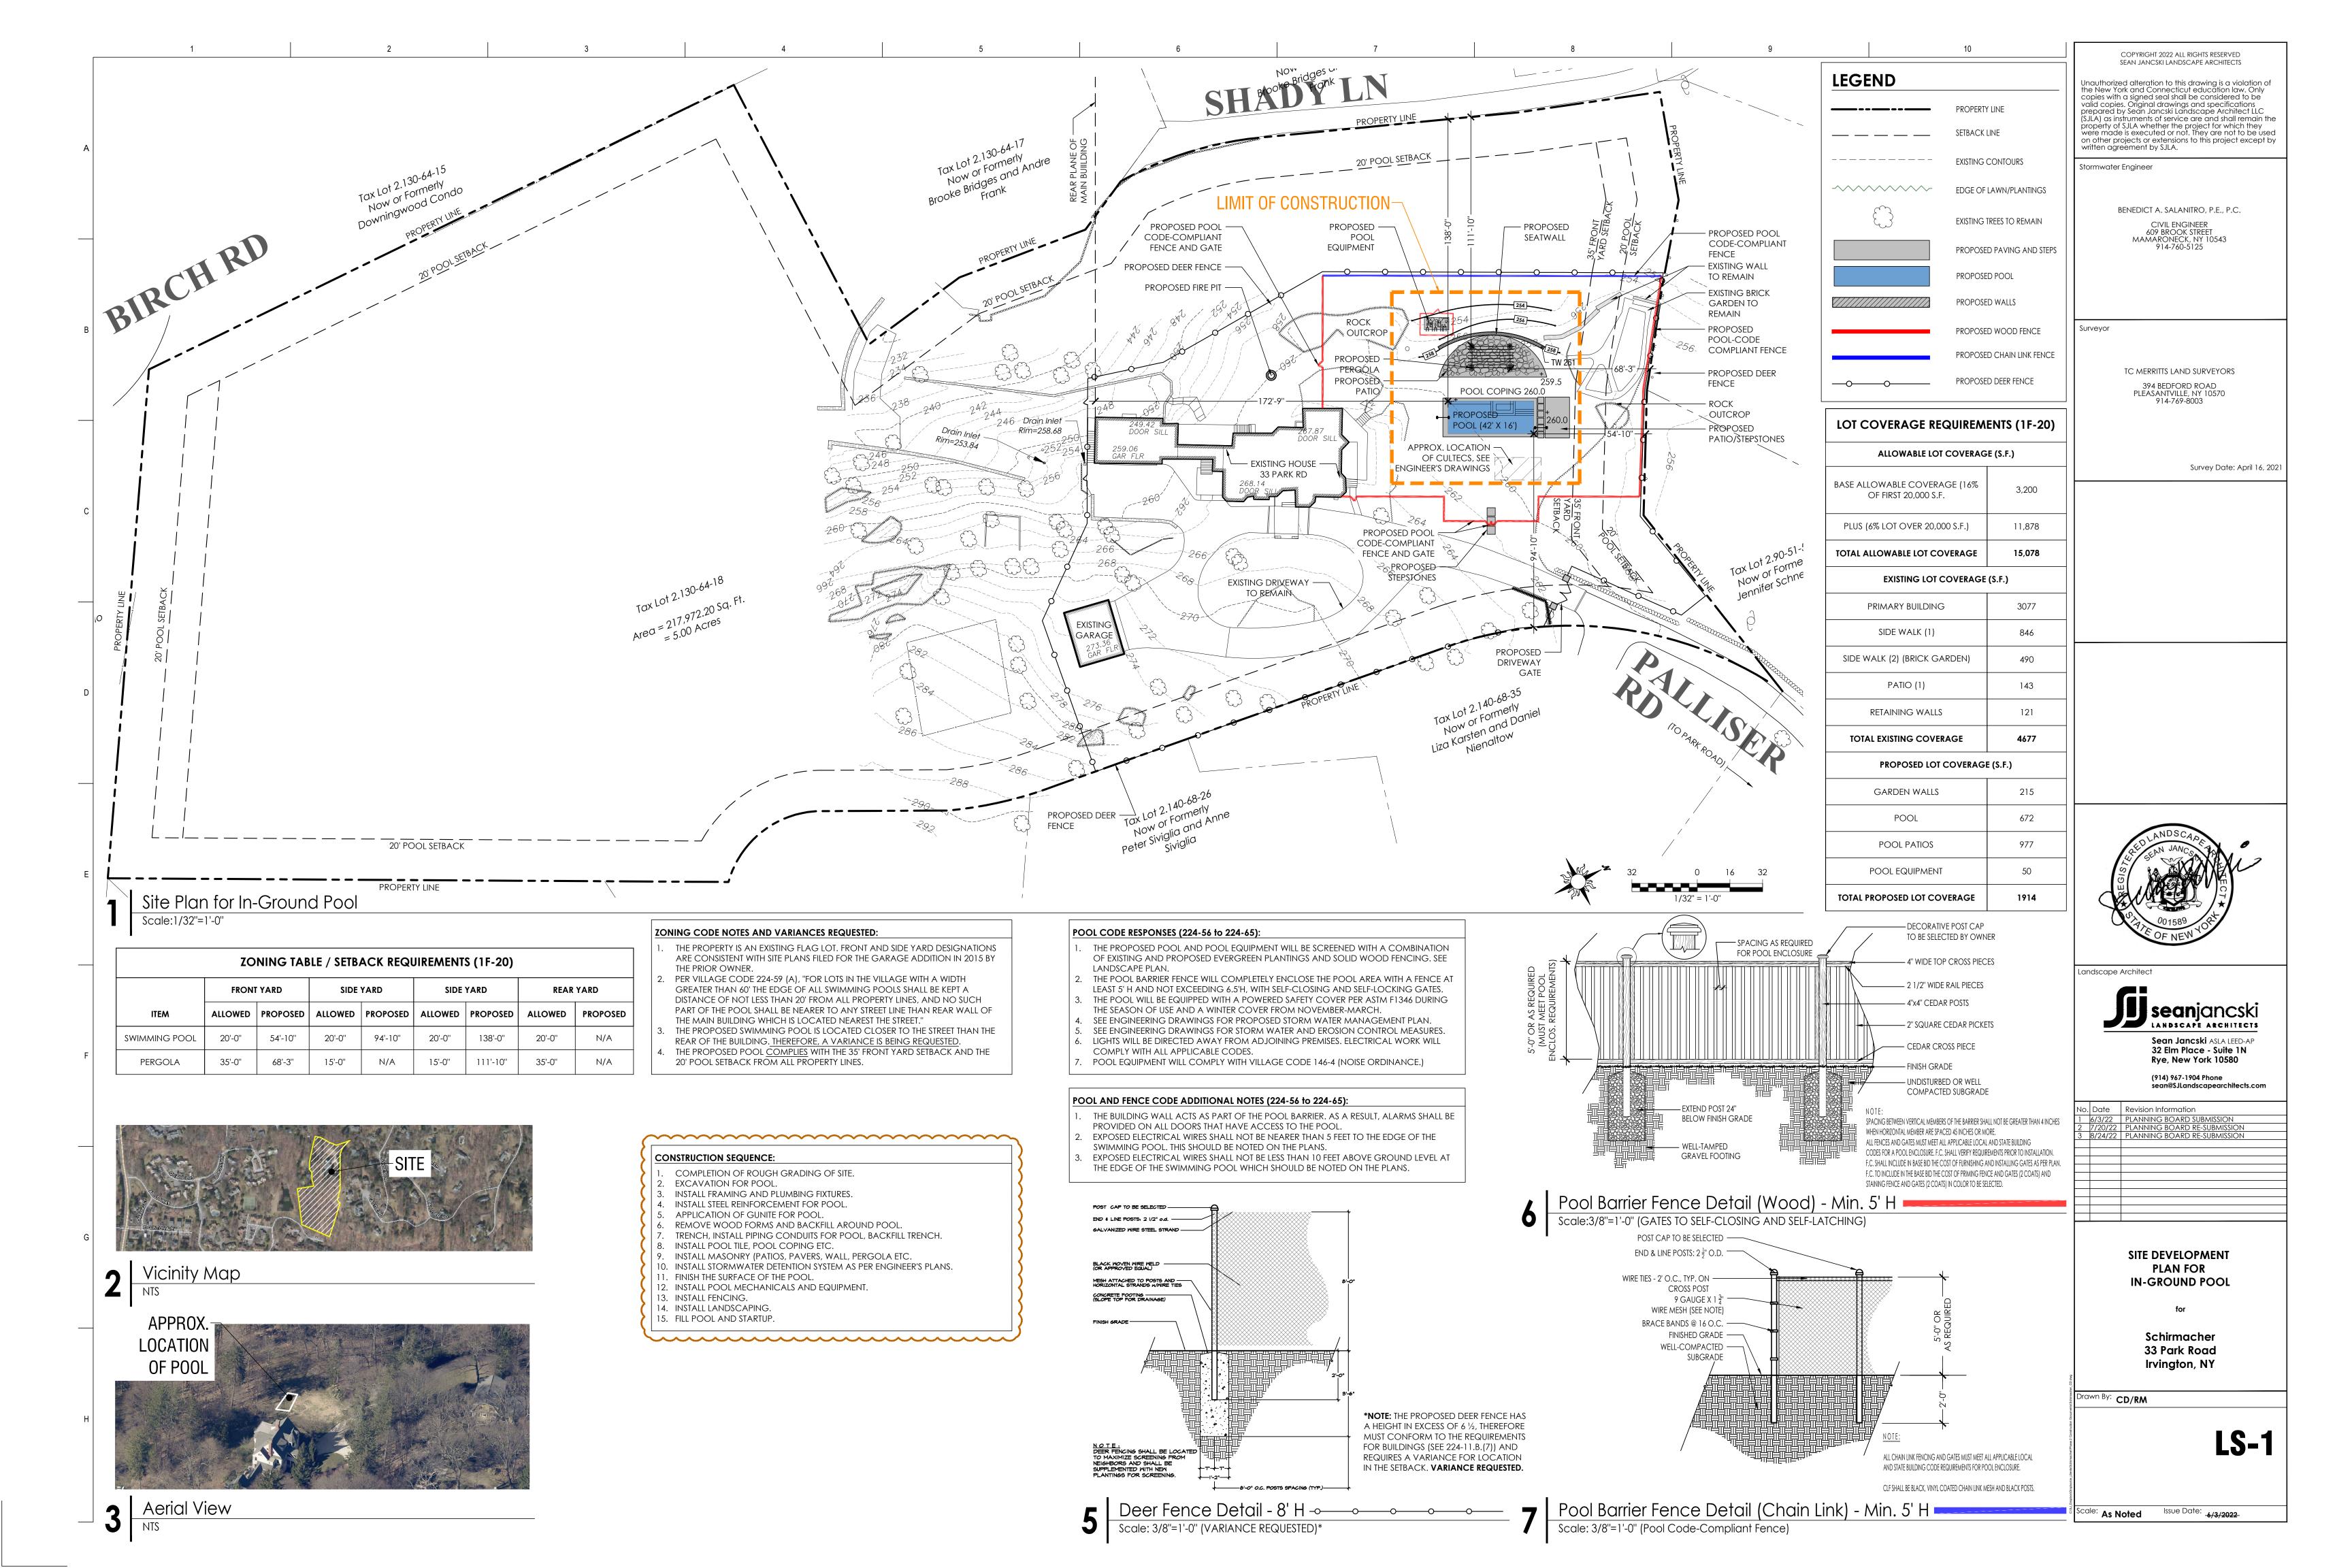

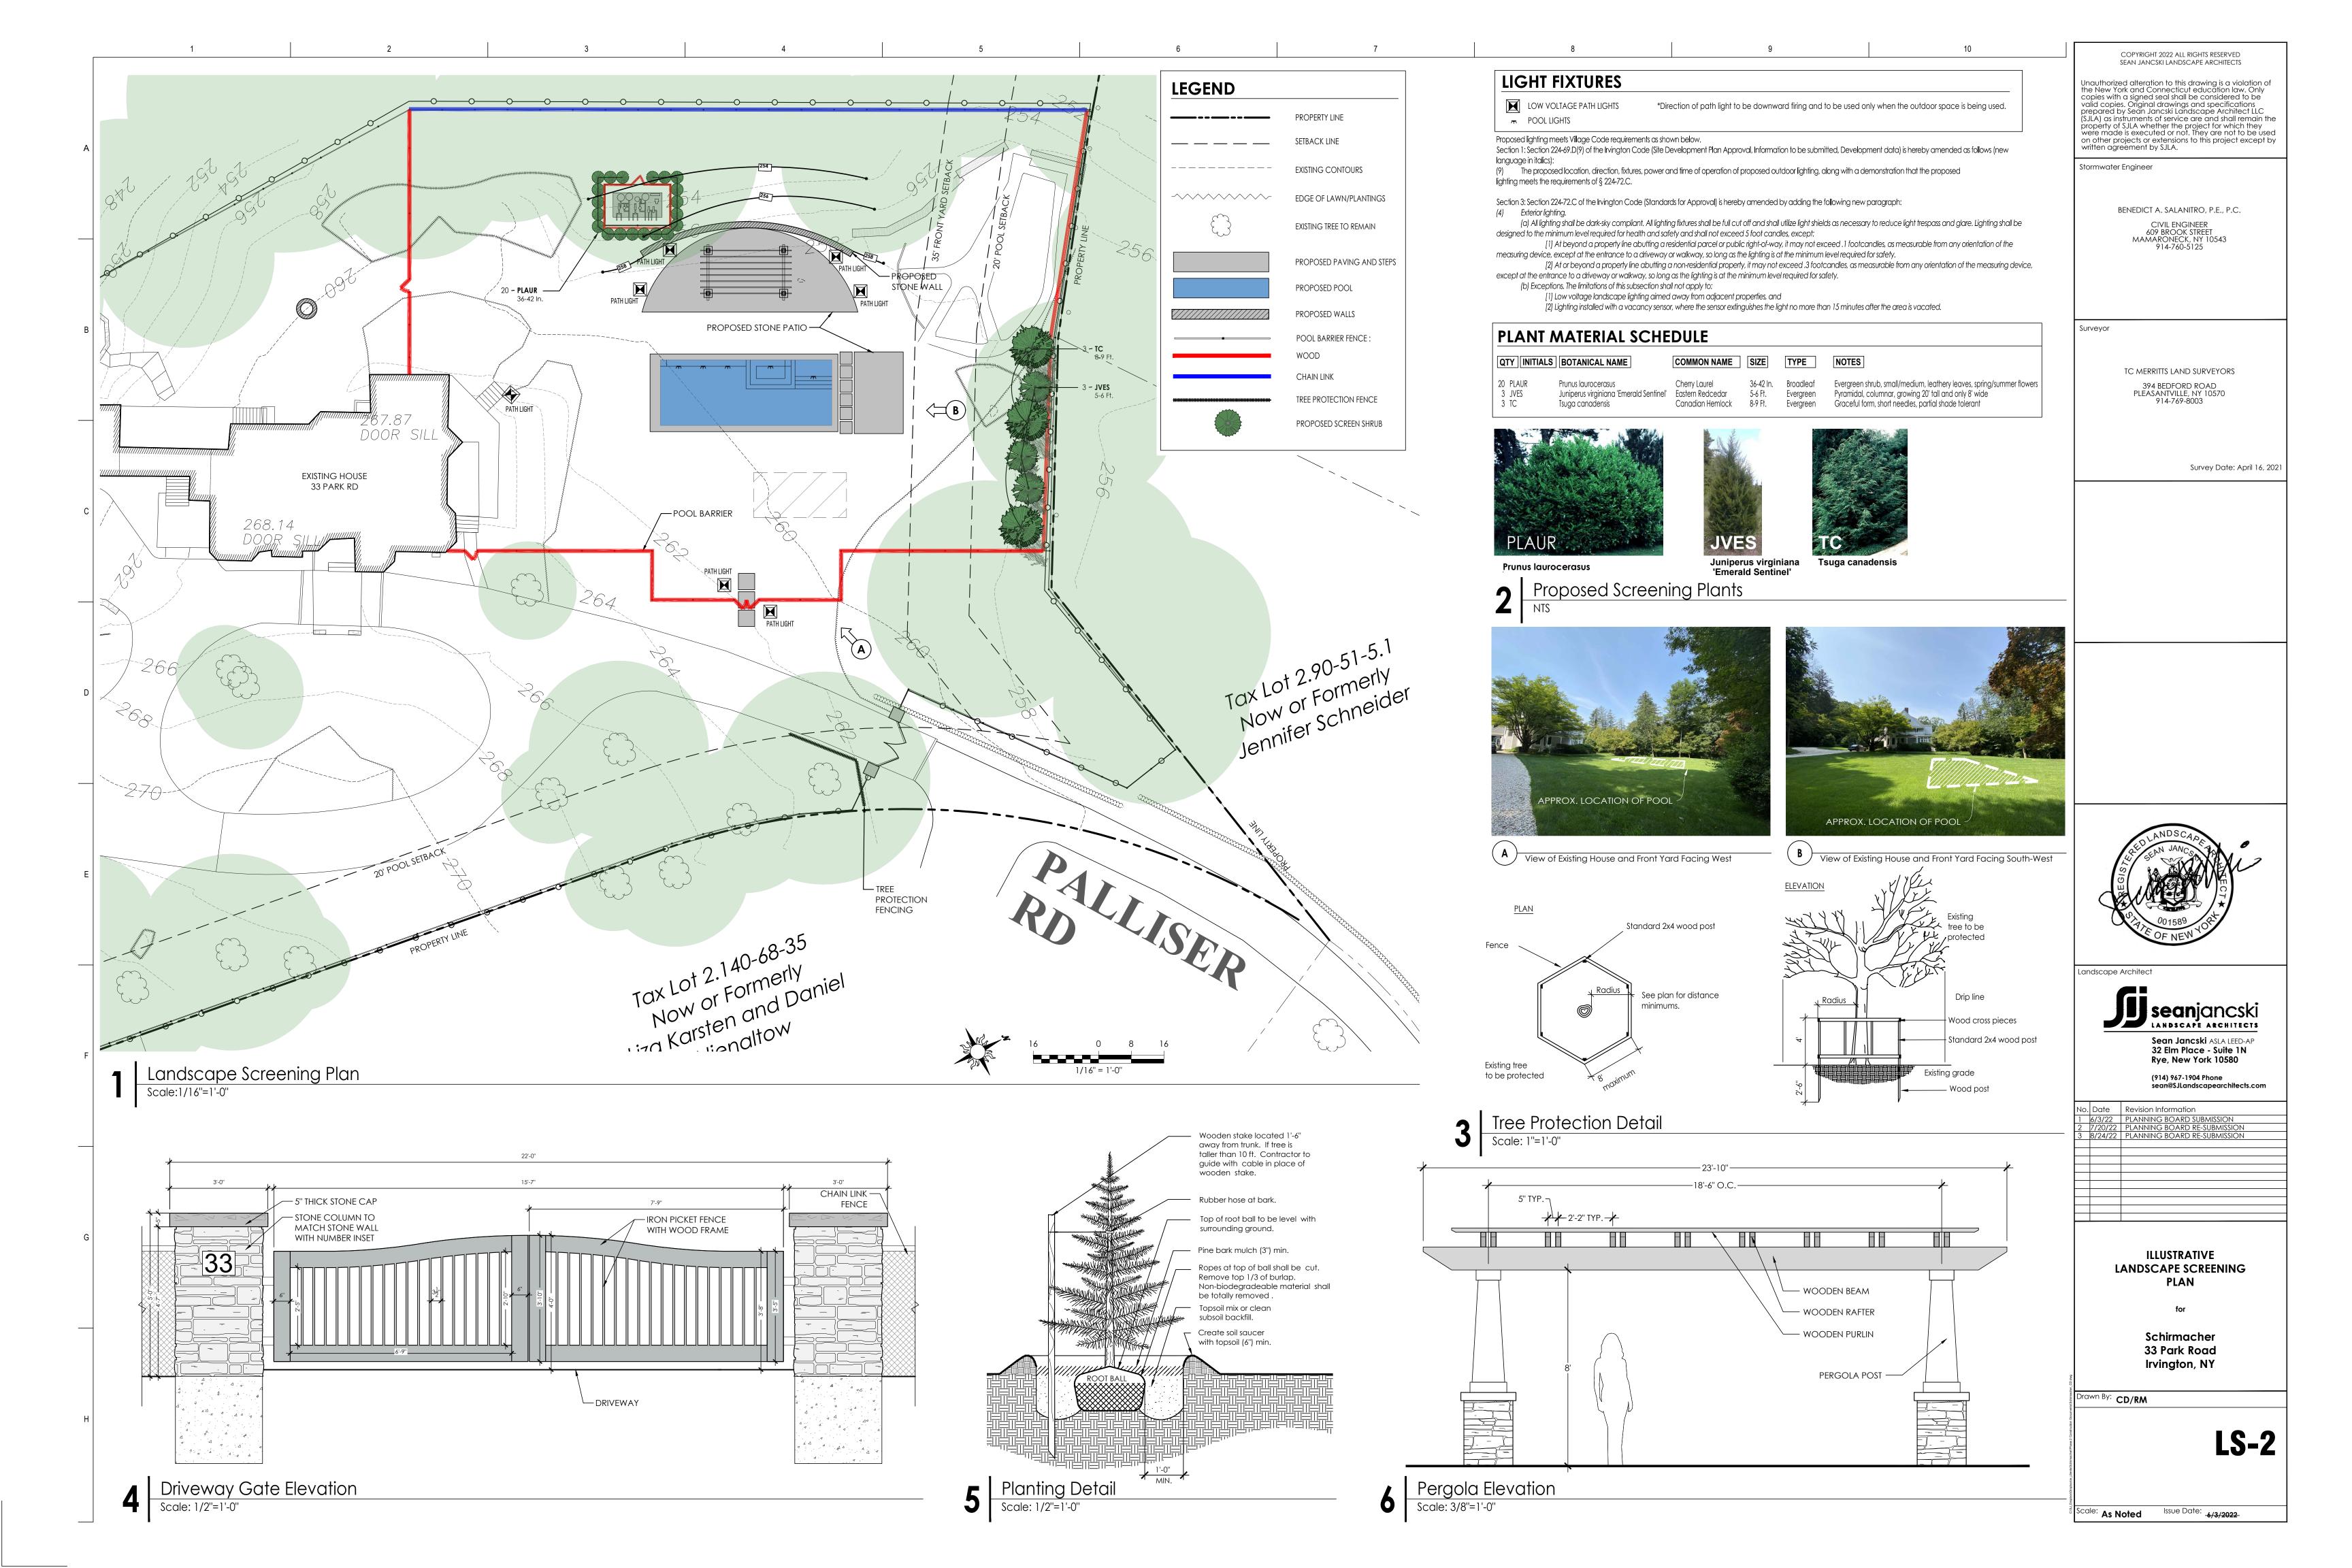

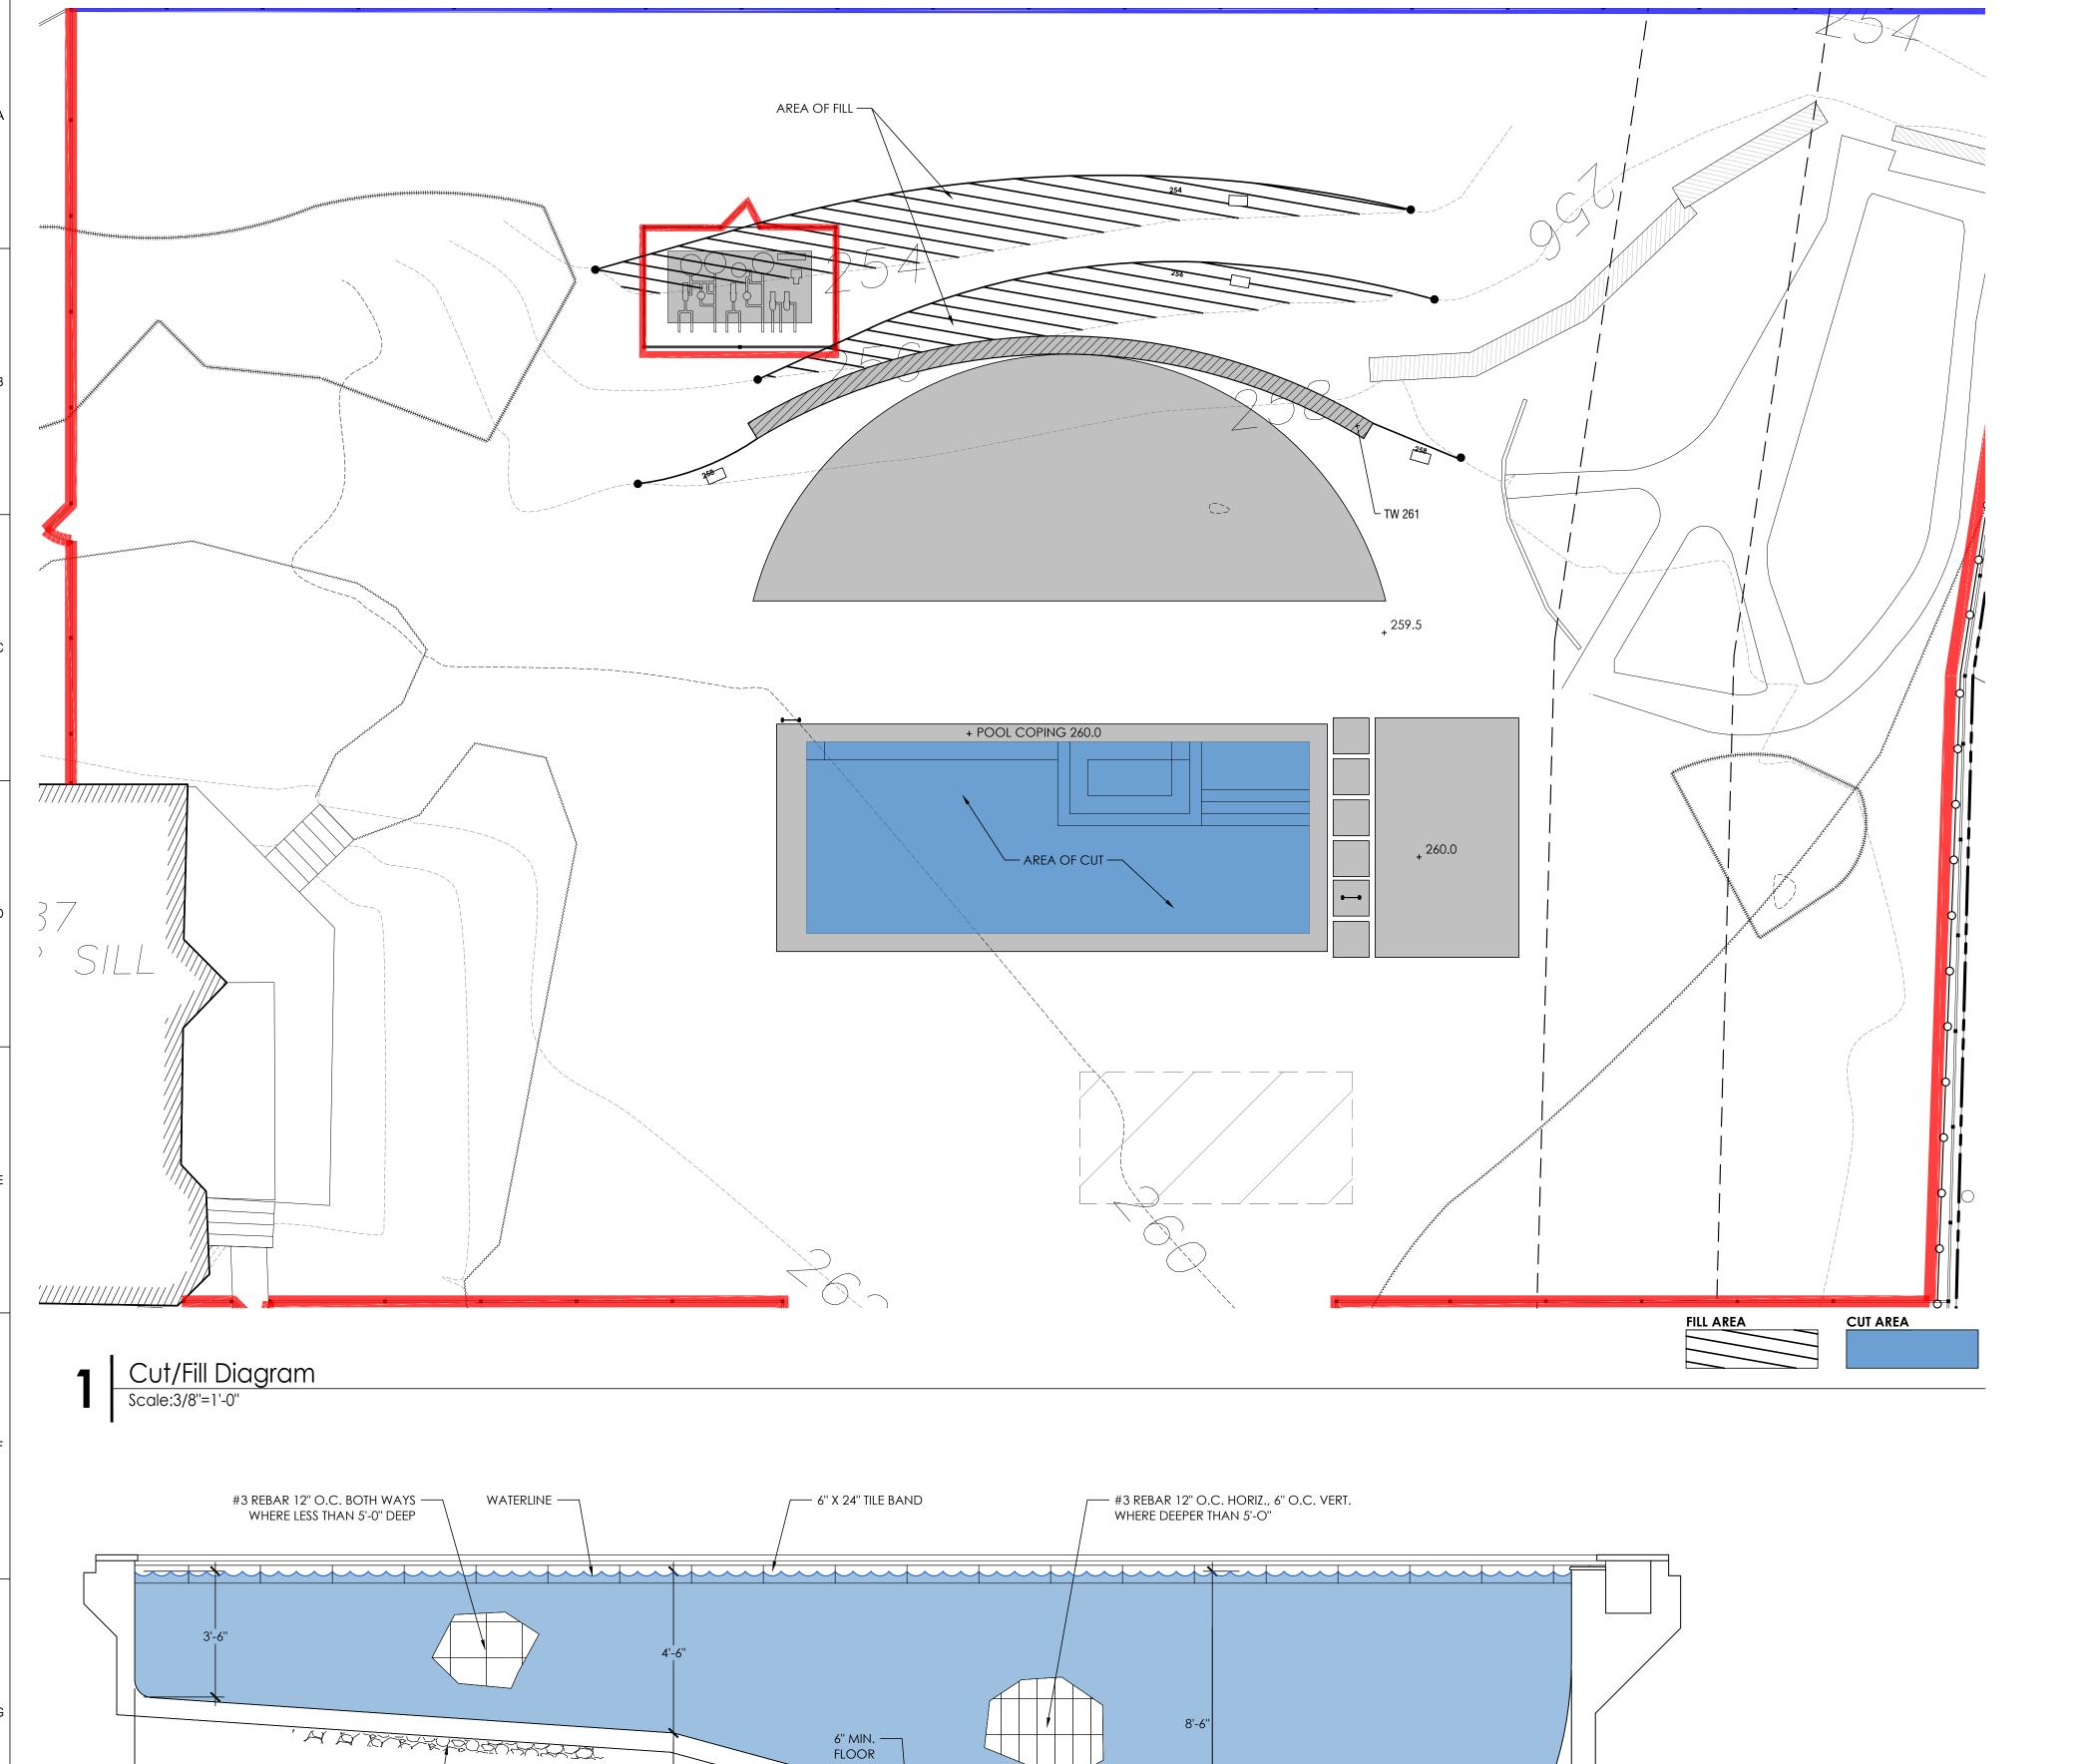

FLOOR

42'-0" OVERALL LENGTH

2" THICK STONE - THERMAL FINISH TOP W/ THERMAL -FINISH EXPOSED SIDE; SEE NOTE BELOW RE: AUTOCOVER STONE WIDTH (I.E. TO HIDE AUTCOVER BAR) - LEADING EDGE OF 18" STEEL ANGLE $\frac{1}{2}$ " THICK — **AUTOCOVER** or as required 2'-6" — 1 1/2 " OVERHANG EXPANSION JOINT -— ENCAPSULATED COVER TRACK BEYOND WATER LEVEL 5" BELOW COPING BOTTOM - 6"X24" TILE BAND; COLOR TBD - TILE TOP AND SIDES OF BOND BEAM (COLOR TO BE SELECTED) UNDISTURBED OR $\overline{\mathbb{H}}$ SLOPE BOND BEAM $\frac{1}{2}$ " WELL-COMPACTED SUBGRADE; SEE STRUCTURAL - SLOPE COVER PIT FLOOR DWGS PROVIDED BY P.C. TO DRAIN — POOL WALL AT DEEP END - COMPACTED GRAVEL NOTES:

1. P.C. TO SUBMIT DRAWING OF POOL AUTOCOVER WITH BID PROPOSAL AND SUBMIT SHOP DRAWINGS FOR APPROVAL PRIOR TO INSTALLATION.

2. INTENT IS TO HAVE AUTOCOVER BAR COVERED BY AUTOCOVER STONE.

3. COORDINATE SIZE OF ROLL UP TUBE AREA WITH MANUFACTURER'S RECOMMENDATIONS.

Pool Autocover Detail Scale:3/4"=1'-0"

2" THICK X 18" WIDE POOL COPING STONE - ——

THERMAL FINISH TOP W/ THERMAL FINISH EXPOSED SIDE; LA TO APPROVE SAMPLE — 1" MORTAR SETTING BED; COLOR TBD EXPANSION JOINT ----—— 1-1/2" OVERHANG PITCH ~ WATERLINE $X^{\triangleright} \xrightarrow{P} X \xrightarrow{\bullet} X \xrightarrow{\Delta D} X \xrightarrow{\triangleright} X \xrightarrow{\bullet} X \xrightarrow{\bullet}$ 4" COMPACTED -GRAVEL BASE - AUTOCOVER TRACK CONCRETE — 6"X24"X1/2" HAUNCH FOR TILE BAND: SAMPLE TILE TERRACE BASE

TO BE APPROVED BY OWNER/LA CEMENT PLASTER OR PEBBLE INTERIOR FINISH (COLOR AND FINISH TBD) - #3 BARS 12" O.C. HORIZ. & VERT. FOR POOL DEPTHS OF 5'-0" OR LESS; 12" O.C. HORIZ. & 6" VERT. FOR POOL DEPTHS OF MORE THAN 5'-0"; SEE DRAWINGS BY OTHERS

— 4" COMPACTED GRAVEL BASE

- POOL WALL; SEE DRAWINGS BY OTHERS

UNDISTURBED OR

SUBGRADE

WELL-COMPACTED

- IN-GROUND POOL DESIGN AND CONSTRUCTION WILL BE IN COMPLIANCE WITH ANSI/APSP/ICC 5. (FROM 2020 RESIDENTIAL CODE OF NY STATE R326) POOL COVER WILL BE CAPABLE OF SUPPORTING A MINIMUM DEAD WEIGHT OF 200 POUNDS
- WHEN FASTENED OR LOCKED IN PLACE OVER A SWIMMING POOL. THE POOL COVER MUST FULLY COVER POOL WHEN NOT IN USE AND DURING THE PERIOD OF NOVEMBER 1 THROUGH
- DISCHARGE OF POOL WATER WILL BE IN COMPLIANCE TO MS4 AND BE DIRECTED TO THE MS4 STORM SEWER SYSTEM THAT IS CONNECTED TO THE PROPERTY SANITARY SEWER SYSTEM.

Unauthorized alteration to this drawing is a violation of the New York and Connecticut education law. Only copies with a signed seal shall be considered to be valid copies. Original drawings and specifications prepared by Sean Jancski Landscape Architect LLC (SJLA) as instruments of service are and shall remain the property of SJLA whether the project for which they were made is executed or not. They are not to be used on other projects or extensions to this project except by written agreement by SJLA. Stormwater Engineer BENEDICT A. SALANITRO, P.E., P.C. CIVIL ENGINEER 609 BROOK STREET MAMARONECK, NY 10543 914-760-5125

Surveyor

TC MERRITTS LAND SURVEYORS 394 BEDFORD ROAD PLEASANTVILLE, NY 10570 914-769-8003

COPYRIGHT 2022 ALL RIGHTS RESERVED SEAN JANCSKI LANDSCAPE ARCHITECTS

Survey Date: April 16, 2021

andscape Architect seanjancski LANDSCAPE ARCHITECTS Sean Jancski ASLA LEED-AP 32 Elm Place - Suite 1N Rye, New York 10580

(914) 967-1904 Phone sean@\$JLandscapearchitects.com o. Date Revision Information SITE DETAILS Schirmacher 33 Park Road Irvington, NY

Drawn By: RM

ale: As Noted Issue Date: 7/20/2022

Pool - Longitudinal Section Profile

Scale:3/8"=1'-0"

4" MIN. CRUSHED STONE ——

STORMWATER SYSTEM NOTES:

- ALL RUNOFF FROM THE PROPOSED POOL ADDITION TO BE COLLECTED AND CONVEYED INTO THE PROPOSED STORMWATER SYSTEM AS SHOWN. IT SHALL BE DETERMINED BY THE CONTRACTOR PRIOR TO EXCAVATION FOR THE STORMWATER
- SYSTEM THAT NO UTILITIES ARE IN INTERFERENCE. CONTRACTOR TO VERIFY ALL PROPOSED ELEVATIONS PRIOR TO COMMENCEMENT OF WORK. NOTIFY
- ENGINEER OF ANY DISCREPANCIES.

4. ALL STORM WATER PIPING TO BE 4" SCHED. 40 PVC UNLESS OTHERWISE NOTED.

SITE PLAN LAYOUT PROVIDED BY SEAN JANCSKI LANDSCAPE ARCHITECTS.

SITE PLAN SHOWN HEREIN SHALL BE USED SOLELY TO ILLUSTRATE LOCATION OF THE STORM WATER SYSTEM & EROSION CONTROL PROVISIONS.

THE ENGINEER MAKES NO REPRESENTATION AS TO THE ACCURACY OR COMPLETENESS OF INFORMATION TAKEN FROM SURVEY. PROPERTY INFORMATION SHOWN FOR GRAPHIC PURPOSES ONLY. SEE ORIGINAL SURVEY FOR ALL PROPERTY INFORMATION.

ALL WORK MATERIALS, SPECIFICATIONS, REGULATIONS, RULES, PERMITS. ETC. OF ALL STATE, COUNTY AND THE TOWN/ VILLAGE OF HARRISON SHALL BE FOLLOWED BY THE CONTRACTOR.

ALL MANUFACTURED ITEMS SHALL BE INSTALLED OR APPLIED AS DIRECTED BY THE MANUFACTURES

WELL AS ADEQUATE LIABILITY INSURANCE DURING THE ENTIRE LENGTH OF THE JOB. CONTRACTOR SHALL

- RECOMMENDATIONS CONTRACTORS AND HIS SUBCONTRACTORS SHALL MAINTAIN WORKMEN'S COMPENSATION INSURANCE AS
- CONTRACTOR SHALL FURNISH ALL PERMITS. LICENSES AND APPROVALS NECESSARY TO COMPLETE THE CONTRACTOR TO INCLUDE ALL MATERIALS, LABOR, INCIDENTALS AND SERVICES FOR SATISFACTORY

SUPPLY THE REQUIRED INSURANCES AS SPECIFIED BY THE TOWN/ VILLAGE OF HARRISON.

- COMPLETION OF ALL WORK.
- JOB SITE SHALL BE KEPT CLEAN AT ALL TIMES, TRASH TO BE REMOVED FROM THE SITE DAILY. NOTIFY THE ENGINEER OF ANY UNSUITABLE SUB-SOIL CONDITIONS IF ENCOUNTERED DURING EXCAVATION. CARE SHALL BE TAKEN TO PROTECT THE TREES TO REMAIN FROM THE METHODS OF CONSTRUCTION, TRAFFICKING AND STORAGE OF MATERIALS. RETURN THOSE AREAS DAMAGED BY SUCH TO THEIR ORIGINAL
- DURING CONSTRUCTION, PROVISIONS FOR SAFE PEDESTRIAN ACCESS SHALL BE MAINTAINED AT ALL TIMES. 10. THIS ENGINEER IS NOT RESPONSIBLE FOR POOL DESIGN OR POOL SAFETY CONSIDERATIONS.

INSTALLATION & MAINTENANCE OF EROSION CONTROL

CONSTRUCTION SCHEDULE NOTIFY APPROPRIATE MUNICIPAL AGENCY HAVING JURISDICTION AT LEAST 5 DAYS PRIOR TO START

EROSION CONTROL MEASURES Install all erosion control measures prior to start of construction. Call for inspection from the appropriate Municipal Agency having jurisdiction at least 2 days prior to finish.

MAINTENANCE (TO BE PERFORMED DURING ALL PHASES OF CONSTRUCTION)

After any rain causing runoff Contractor to inspect haybales, etc. and remove any excessive sediment, and inspect stockpiles and correct any problems with seed establishment. Inspections shall be documented in writing and submitted to the appropriate Municipal Agency having jurisdiction.

STOCK PILING OF EXCAVATED MATERIAL

INSPECTION BY MUNICIPALITY

INSPECTION BY MUNICIPALITY

Strip Topsoil and Stockpile. Stockpile Excavation Subgrade. Seed piles with 1 lb. total annual rye or remove from site within 2 INSPECTION BY MUNICIPALITY

FINAL GRADING

Remove unneeded subgrade from site. Call for inspection from the appropriate Municipal Agency having jurisdiction at at least 2 days prior to finish. **INSPECTION BY MUNICIPALITY**

Spread topsoil evenly over areas to be seeded. Hand rake level. Broadcast 1:25 lb. Bag of Jonathan Green "Fastgrow" mix or equal over areas to be seeded. Apply straw mulch and water within 2 days of completion of topsoiling. Call for inspection from the appropriate Municipal Agency having jurisdiction at least 2 days prior to finish.

FINAL LANDSCAPING Grass established. Call for inspection from the appropriate Municipal Agency having jurisdiction at least 2 days prior to finish. INSPECTION BY MUNICIPALITY

FINAL INSPECTION

All erosion control measures removed and grass established. Call for inspection from the appropriate Municipal Agency having jurisdiction at least 2 days prior to finish.

AREA OF DISTURBANCE = 10,280 SF.

REFER TO LANDSCAPE ARCHITECTS PLANS FOR ADDITIONAL DETAILS

CODE 753:

PRIOR TO CONSTRUCTION, THE CONTRACTOR SHALL LOCATE ALL BURIED UTILITIES AND INSURE THAT INTERFERENCES WITH THE PROPOSED STORMWATER SYSTEM DO NOT EXIST.




Know what's below. Call before you dig.

1. THE INFILTRATION SYSTEM MUST NOT BE CONNECTED UNTIL CONSTRUCTION IS COMPLETE AND THE SITE IS STABILIZED.

2. THE AREA OF THE PROPOSED INFILTRATION SYSTEM SHOULD BE PROTECTED FROM OVER-COMPACTION DURING CONSTRUCTION. THE AREA SHOULD BE FENCED OFF DURING CONSTRUCTION AND DECOMPACTED PRIOR TO THE INSTALLATION OF

- THE INFILTRATION UNITS. 3. POST CONSTRUCTION MAINTENANCE SHALL BE AS FOLLOWS: DRAINAGE INLET(S) AND DRYWELLS SHALL BE VACUUM SWEPT A MIN. OF TWICE A YEAR, (FALL & SPRING).
- INSPECT FACILITIES FOR SEDIMENT AND REMOVE SAME IF FOUND. 4. SWIMMING POOL SHALL BE DECHLORINATED PRIOR TO BEING DRAINED (8"
- DRAWDOWN /DAY AS REQUIRED) INTO THE PROPOSED DRYWELL SYSTEM. 5. THE BUILDING INSPECTOR OR VILLAGE ENGINEER MAY REQUIRE ADDITIONAL EROSION CONTROL MEASURES IF DEEMED APPROPRIATE TO MITIGATE UNFORESEEN
- SILTATION AND EROSION OF DISTURBED SOILS. 6. "AS-BUILT" DRAWINGS OF THE SITE IMPROVEMENTS SHALL BE SUBMITTED TO THE VILLAGE BUILDING INSPECTOR FOR REVIEW PRIOR TO OBTAINING THE CERTIFICATE
- OF OCCUPANCY. 7. INFILTRATION SYSTEM ACCESS PORTS SHALL BE SHOWN ON "AS-BUILT" DRAWING. 8. IMPORTED FILL MUST BE CERTIFIED AND APPROVED BY THE VILLAGE BUILDING

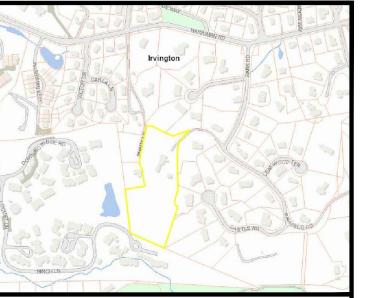


LOCATION MAP

DO NOT SCALE DRAWINGS

DC	NOT SCALE DRA	vviivGS	
2	ENGINEER COMMENTS	08-11-202	
1	ENGINEER COMMENTS	07-11-202	
NO	DESCRIPTION	DATE	
- REVISIONS -			



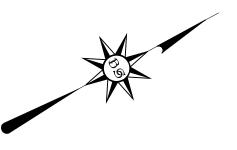

SITE PLAN, DRAINAGE, EROSION CONTROL PLAN FOR NEW IN-GROUND SWIMMING POOL

> <u>SCHIRMACHER</u> RESIDENCE

33 PARK ROAD IRVINGTON, NY 10533

<u>SHEET:</u> 2.13 <u>BLOCK:</u> 64 <u>LOT:</u> 18 <u>ZONE:</u> 1F-20 DRAWING TITLE: NOTES, SITE PLAN

Benedict A. Salanitro, P.E., P.C.

CIVIL ENGINEER

609 BROOK STREET Mamaroneck, New York 10543





STATE EDUCATION LAW FOR ANY ERSON, UNLESS ACTING UNDER TH DIRECTION OF A LICENSED PROFESSIONAL ENGINEER. TO ALTE ANY ITEM ON THIS DRAWING AND/OR COMPLIANCE WITH THE NEW YORK STATE EDUCATION LAW. THE PROFESSIONAL ENGINEER WHOSE SEAL APPEARS HEREON ASSUMES NO ALTERATION OR RE-USE WITHOUT HI


PROJECT No: *051622*

DATE : <u>05/16/22</u> SCALE: AS.NOTED DRAWN BY : $\sqrt{.}$ \lesssim .


CHECKED BY: B.S.

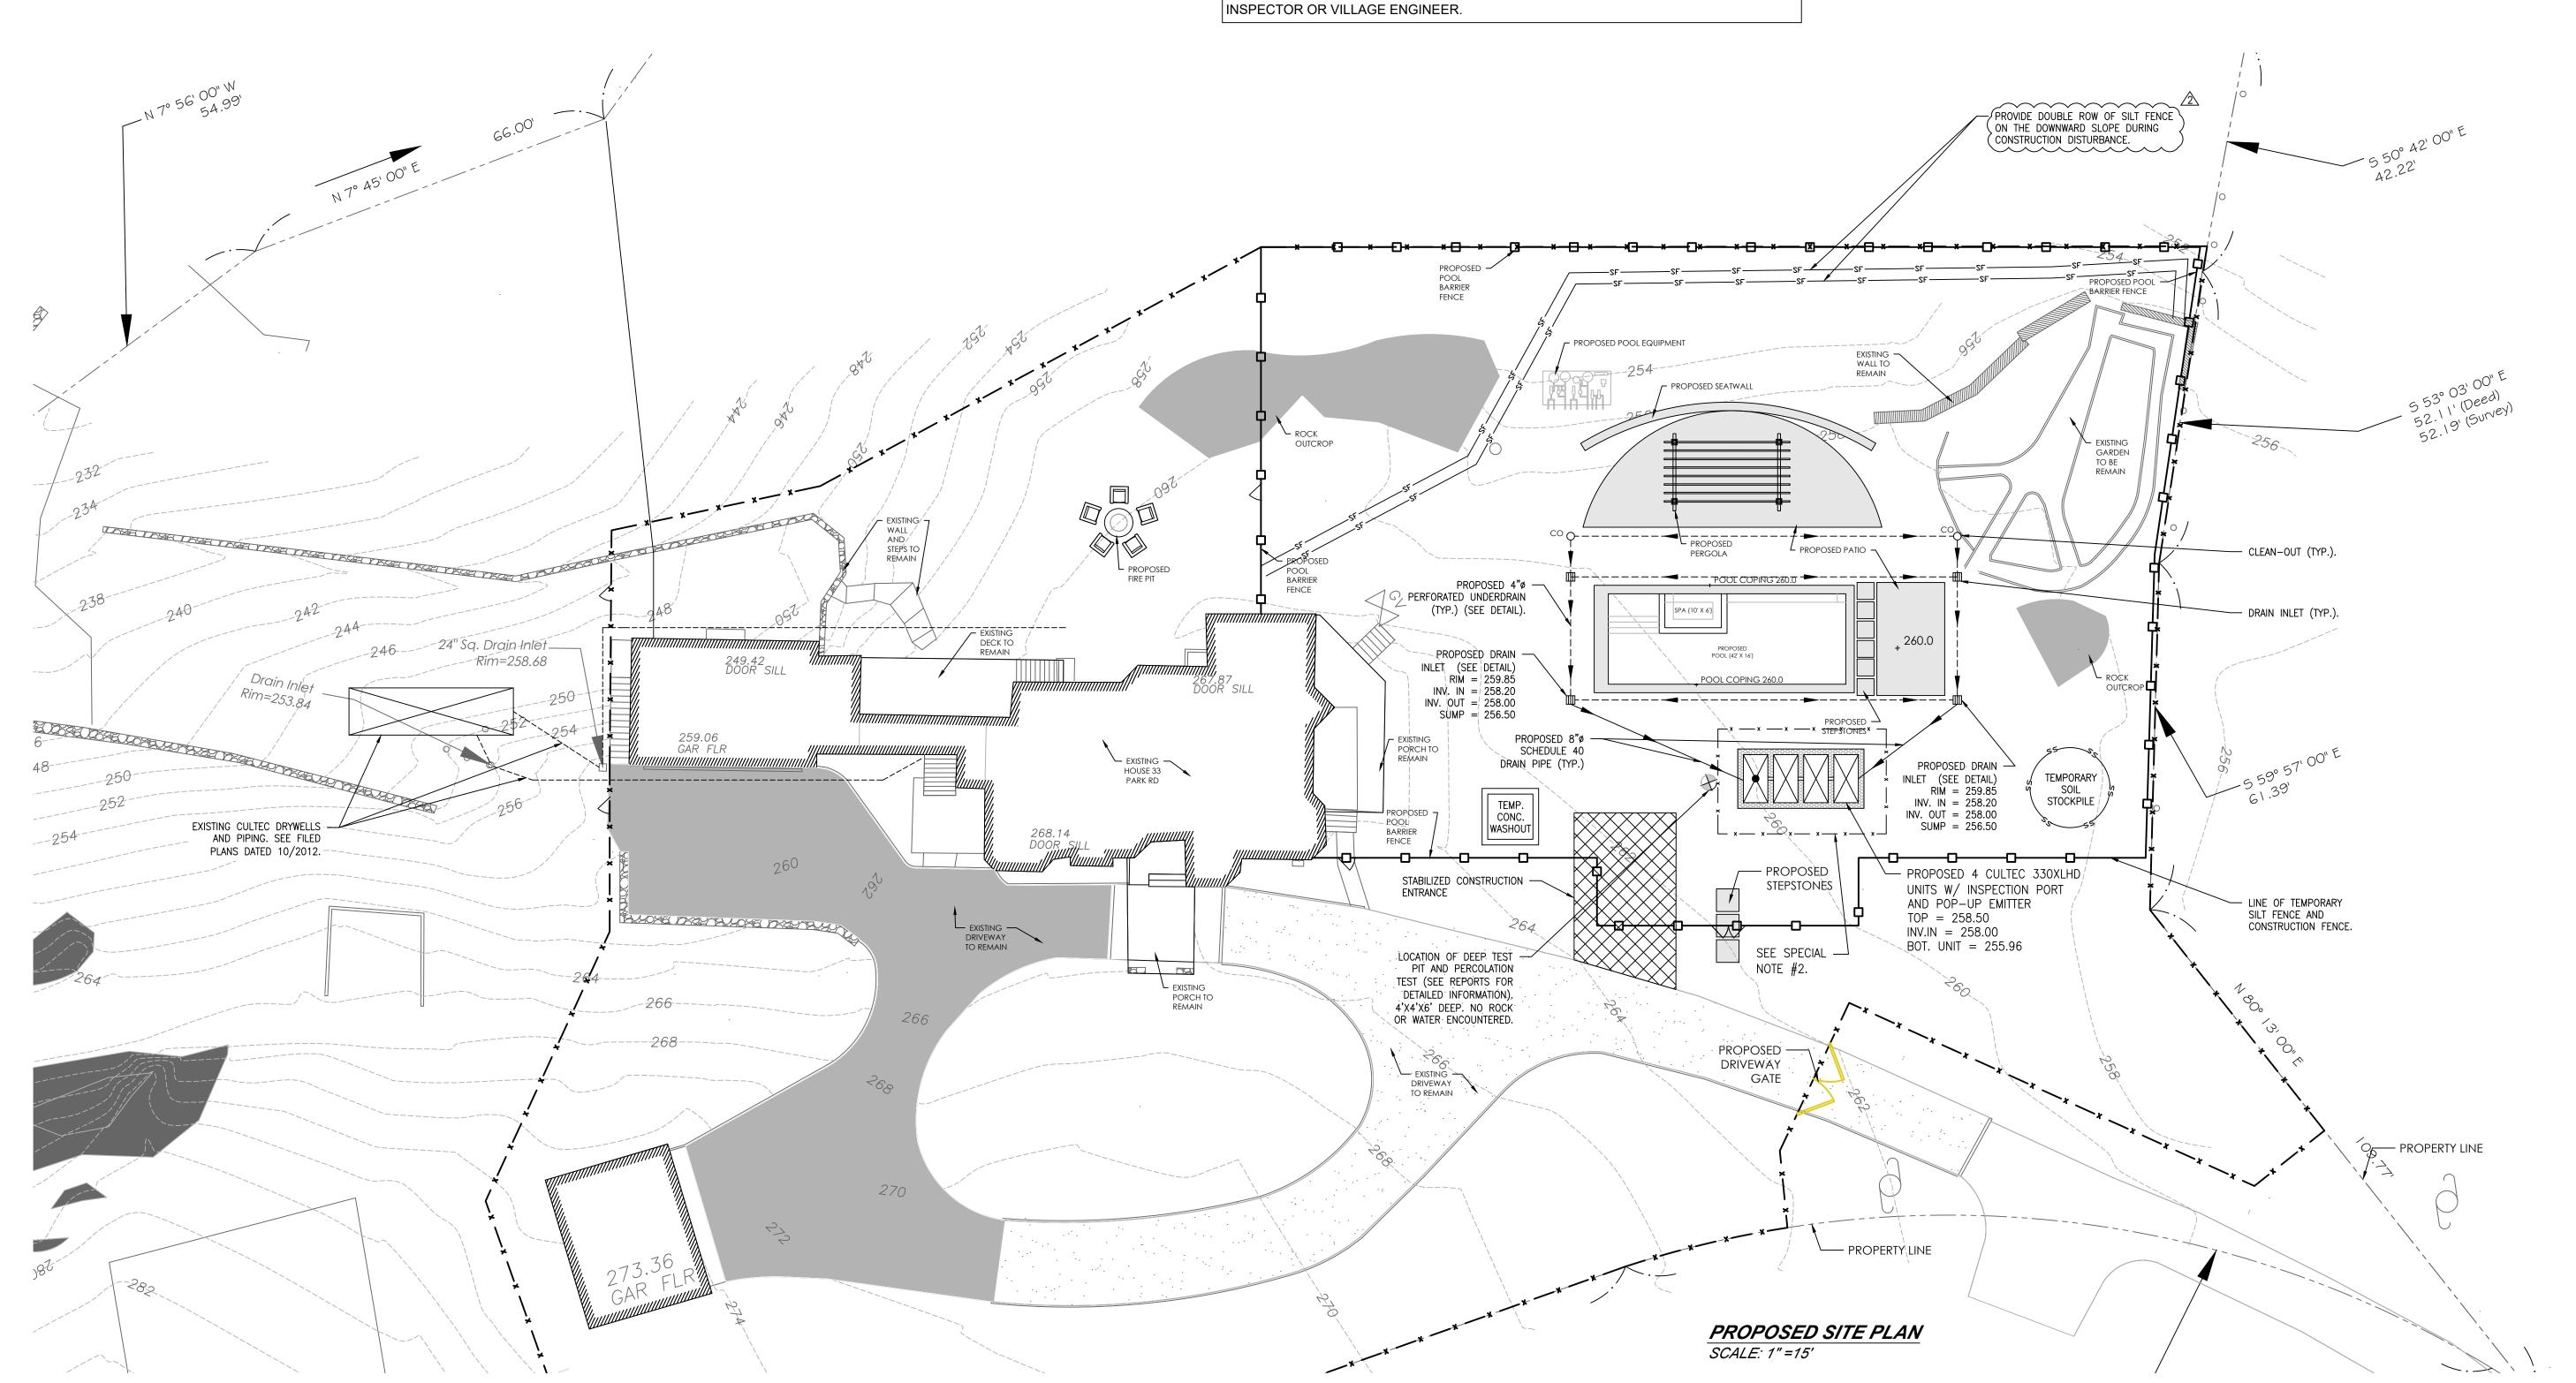

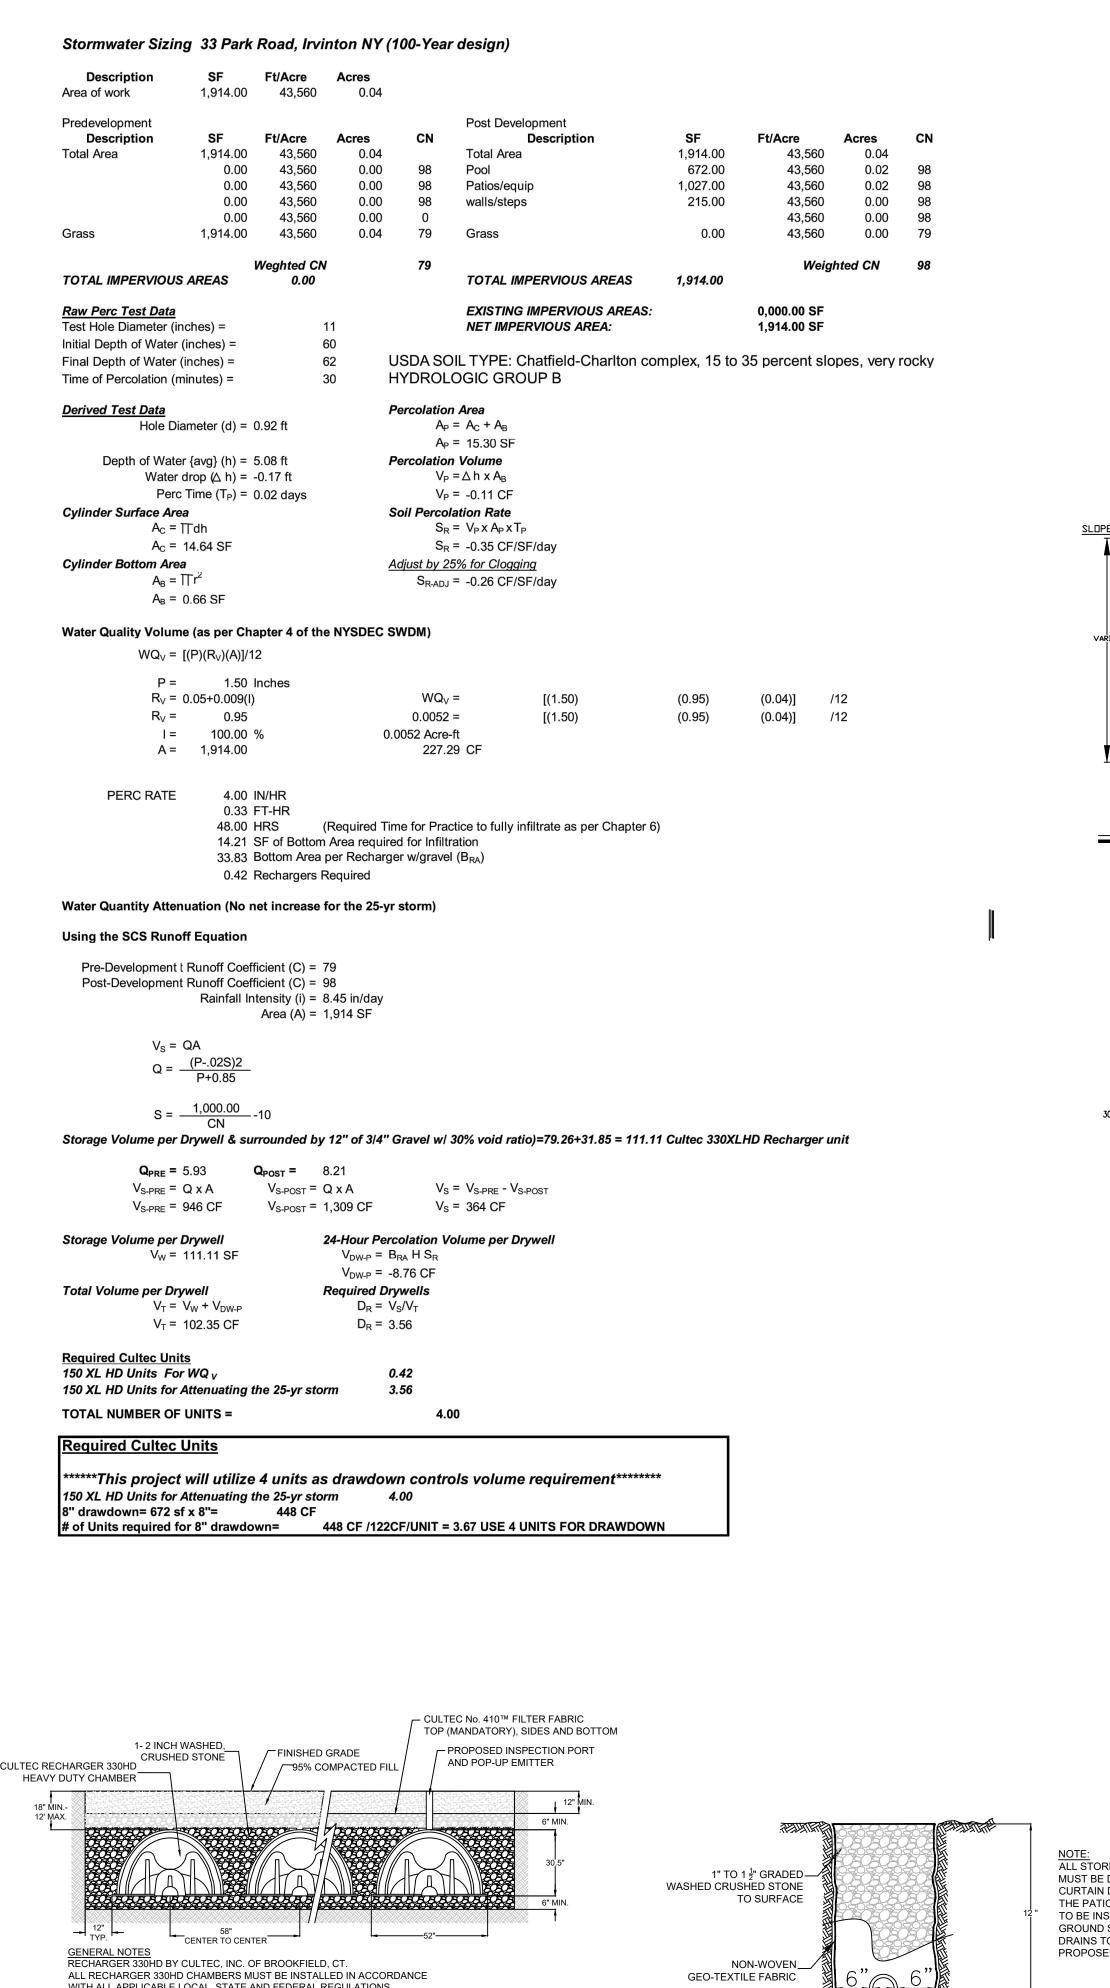

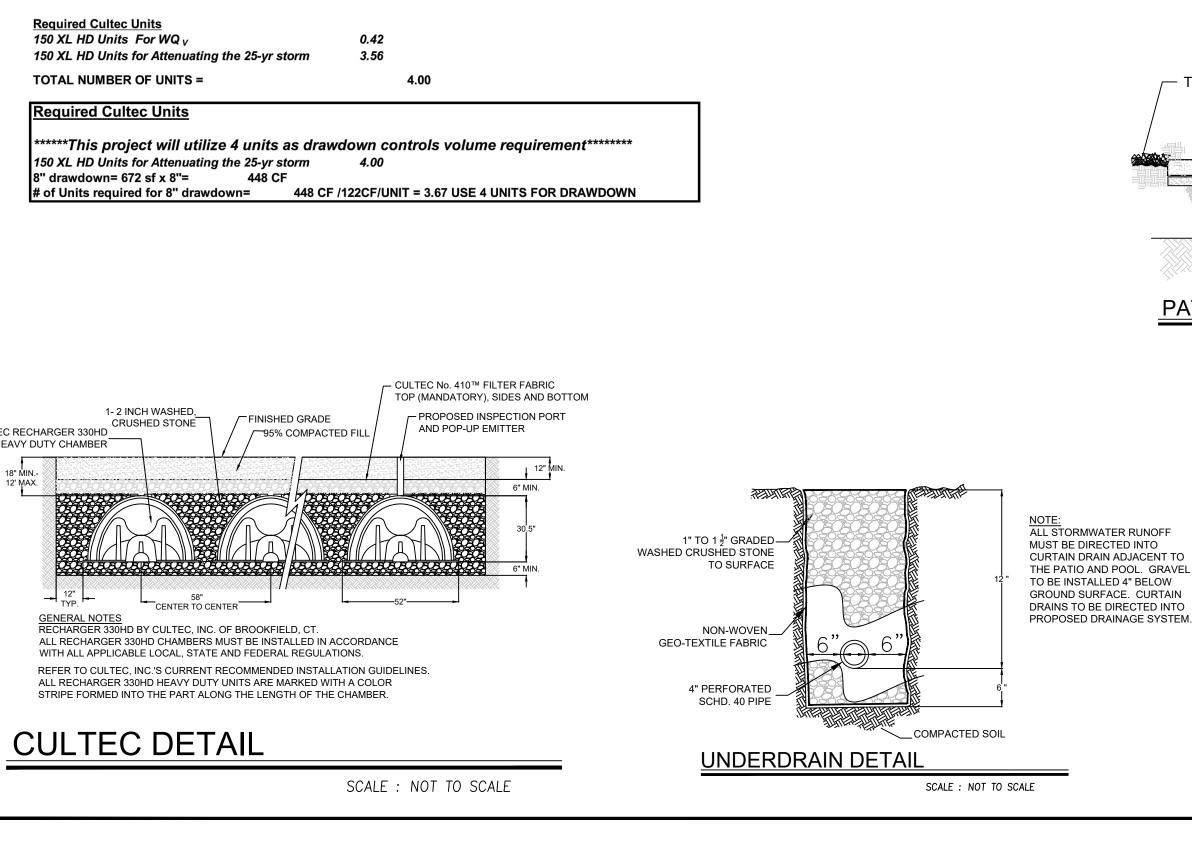



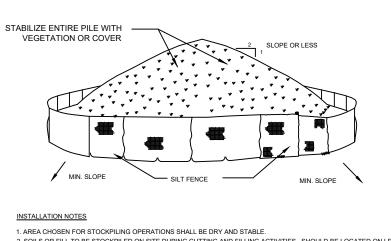

INSTALLATION NOTES AREA CHOSEN FOR STOCKPILING OPERATIONS SHALL BE DRY AND STABLE.
 SOILS OR FILL TO BE STOCKPILED ON SITE DURING CUTTING AND FILLING ACTIVITIES SHOULD BE LOCATED ON LEVEL PORTIONS. OF THE SITE WITH A MINIMUM OF 50-75 FOOT SETBACKS FROM TEMPORARY DRAINAGE SWALES. 4. UPON COMPLETION OF SOIL STOCKPILING, EACH PILE SHALL BE SURROUNDED WITH EITHER SILT FENCING, THEN STABILIZED 5. STOCKPILES REMAINING IN PLACE FOR MORE THAN A WEEK SHOULD BE SEEDED AND MULCHED OR COVERED WITH GEO-TEXTILE FABRIC SURROUNDED BY SILT FENCE.

6. SEE SPECIFICATIONS FOR INSTALLATION OF SILT FENCE.

SOIL STOCKPILE DETAIL

__6" WIRE STAPLE OR SANDBAG

TEMPORARY CONCRETE

- TOPSOIL & SEED

PATIO DETAIL

WASHOUT FACILITY - STRAW BALE

MORTAR JOINTS

— BLUESTONE

PLAN VIEW

returning the faciliities to a functional condition

. Maintaining temporary concrete washout facilities shall include

2. Facility shall be cleaned or reconstructed in a new area once

3. Each straw bale is to be staked in place using (2) 2"x2"x4'

removing and disposing of hardend concrete and/or slurry and

SCALE: NOT TO SCALE

SCALE: NOT TO SCALE

6" Wire Staple or Sandbag —

Liner Anchor

STRAW BALE ANCHOR SECTIONS

· 1" MORTAR BED

SCALE: NOT TO SCALE

SILT FENCE DETAIL

4" 3500 PSI CONCRETE

COMPACTED SUBGRADE

NOTE: USE STEEL POSTS WEIGHING 1.3 LBS/FT

SCALE: NOT TO SCALE


NOTE:
AT THE COMPLETION OF THE PROJECT AND AFTER SOIL STABILIZATION AND VEGETATIVE

GROWTH HAVE BEEN ASSURED, THE SILT FENCE MUST BE COMPLETELY REMOVED AND THE EMBEDMENT TRENCH RESTORED TO A NATURAL CONDITION.

CONCRETÈ

WASHOUT


AREA

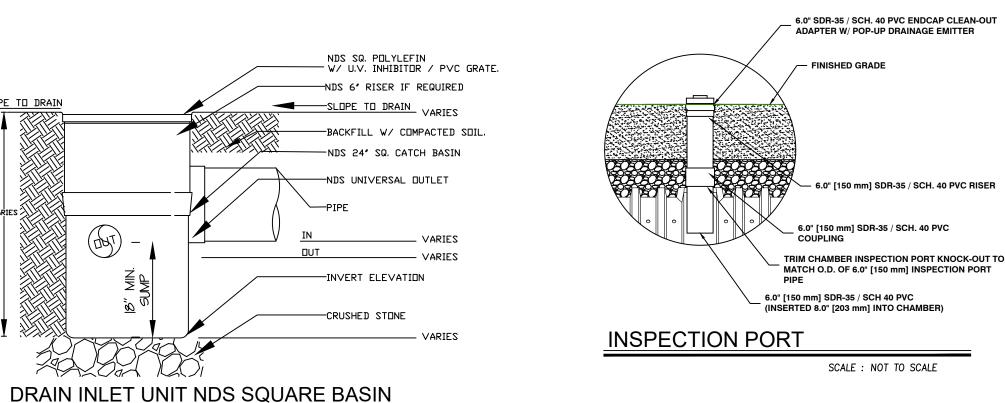

Plywood or Aluminum

_ 4"x4"x6' Wood Post or

6' Steel Post Min.

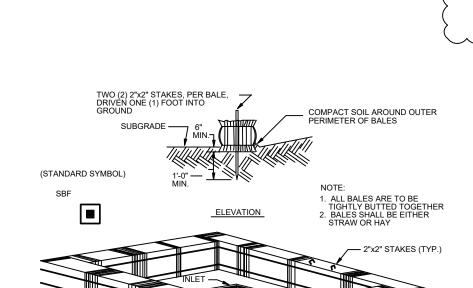

- NDS Polyolefin Pop-Up Drainage

Emitter with U.V. Inhibitor or Approved Equal

— Compacted Topsoil

PORT FROM CULTEC

SCALE: NOT TO SCALE

POP-UP DRAINAGE EMITTER

- 4" DIA. PVC RISERINSPECTION


BOTTOM OF BALES **INLET PROTECTION**

SCALE : NOT TO SCALE

WATER CONTROL DEVICES ONCE RE-CONSTRUCTION

EXCESSIVE SEDIMENT. 2. INSPECTION SHALL BE DOCUMENTED IN WRITING

VILLAGE

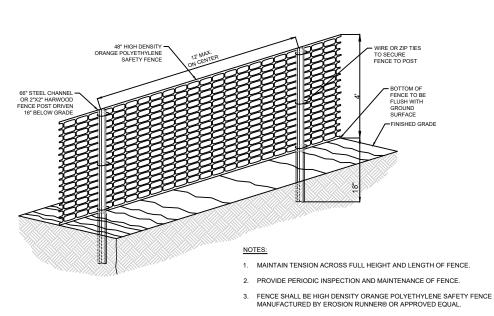

CONSTRUCTION FENCE SCALE : NOT TO SCALE


NOTIFY BLDG. DEPT. OF START UP DATE AT LEAS


5 DAYS PRIOR TO START.

1. INSTALL 40" SNOW FENCE, POSTS @ 6-0" O.C. (MAX.) WITH FILTER FABRIC PRIOR TO START OF CONSTRUCTION.

. CALL FOR INSPECTION FROM VILLAGE

AT LEAST 2 DAYS PRIOR TO FINISH.

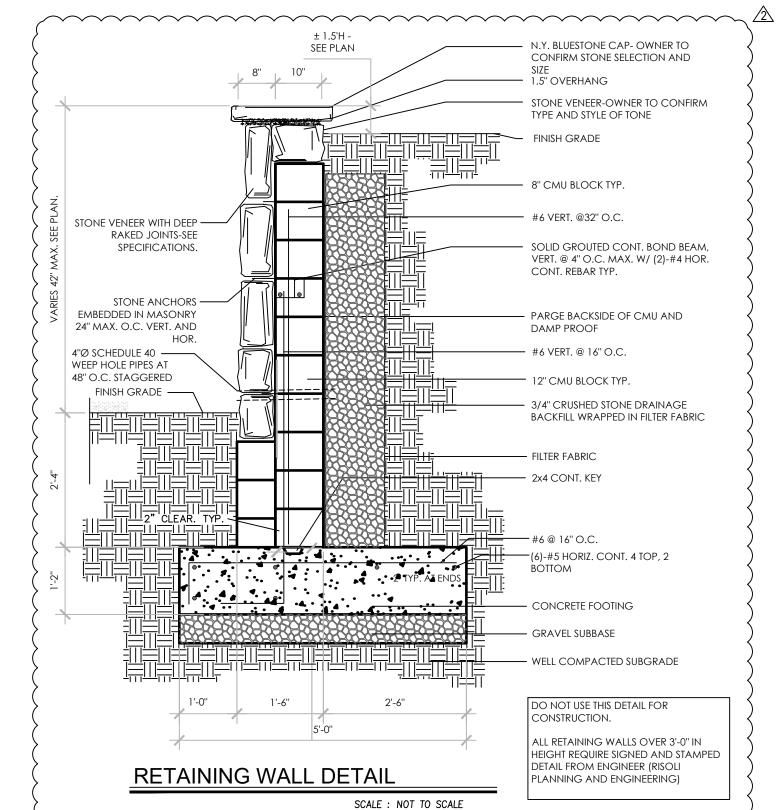

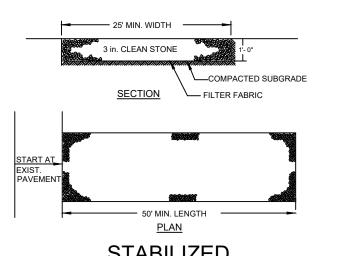

1. STONE SIZE - USE 3" STONE, OR RECLAIMED OR RECYCLED CONCRETE EQUIVALENT RESIDENCE LOT WHERE A 30 FOOT MINIMUM LENGTH WOULD APPLY 3. THICKNESS - NOT LESS THAN SIX (6) INCHES.


4. WIDTH - 25 FOOT MINIMUM, BUT NOT LESS THAN THE FULL WIDTH AT POINTS WHERE INGRESS OR EGRESS OCCUR.
5. FILTER CLOTH - WILL BE PLACED OVER THE ENTIRE AREA PRIOR TO PLACING OF STONE, FILTER CLOTH WILL NOT BE REQUIRED ON A SINGLE FAMILY RESIDENCE LOT S. SURFACE WATER: ALL SURFACE WATER FLOWING OR DIVERTED TOWARD
 CONSTRUCTION ENTRANCES SHALL BEPIPED ACROSS THE ENTRANCE. IF PIPING IS

IMPRACTICAL, A MOUNTABLE BERM WITH 5:1 SLOPES WILL BE PERMITTED. . MAINTENANCE - THE ENTRANCE SHALL BE MAINTAINED IN A CONDITION WHICH WIL PREVENT TRACKING OR FLOWING OF SEDIMENT ONTO PUBLIC RIGHT OF WAY THIS MAY REQUIRE PERIODIC TOP DRESSING WITH ADDITIONAL STONE AS CONDITIONS DEMAND AND REPAIR AND/OR CLEANOUT OF ANY MEASURES LISED ONTO PUBLIC RIGHT OF WAY MUST BE REMOVED IMMEDIATELY. 8. WASHING - WHEELS SHALL BE CLEANED TO REMOVE SEDIMENT PRIOR TO ENTRANCE ONTO PUBLIC RIGHT OF WAY, WHEN WASHING IS REQUIRED, IT: BE DONE ON AN AREA STABILIZED WITH STONE AND WHICH DRAINS INTO AN

APPROVED SEDIMENT TRAPPING DEVICE. STABILIZED 9. PERIODIC INSPECTION AND NEEDED MAINTENANCE SHALL BE PROVIDED AFTER EACH

CONSTRUCTION ENTRANCE

SCALE: NOT TO SCALE

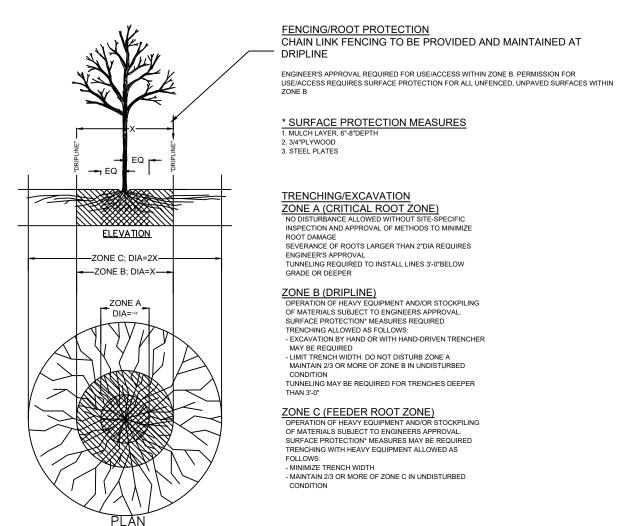

PROJECT No: *051622* DATE : 05/16/22 SCALE: AS.NOTED DRAWN BY : $\sqrt{.}$ \lesssim .

SHEET No

IT IS A VIOLATION OF THE NEW YORK

PROFESSIONAL ENGINEER. TO ALTE ANY ITEM ON THIS DRAWING AND/OR

ALTERATIONS MUST BE MADE IN MPLIANCE WITH THE NEW YORK

STATE EDUCATION LAW. THE

PROFESSIONAL ENGINEER WHOSE

SEAL APPEARS HEREON ASSUMES NO

ALTERATION OR RE-USE WITHOUT HIS

STATE EDUCATION LAW FOR ANY PERSON, UNLESS ACTING UNDER TH DIRECTION OF A LICENSED


TREE FENCE PROTECTION


FINAL GRADING AND GROUND COVER RESTORATION. EXCESSIVE SEDIMENT. 2. INSPECTION SHALL BE

EROSION CONTROL SCHEDULE

EXCESSIVE SEDIMENT. 2. INSPECTION SHALL BE DOCUMENTED IN WRITING

ALL EROSION CONTROL MEASURES SHALL CONFORM TO THE "NYS STANDARDS & SPECIFICATIONS FOR EROSION & SEDIMENT CONTROL"

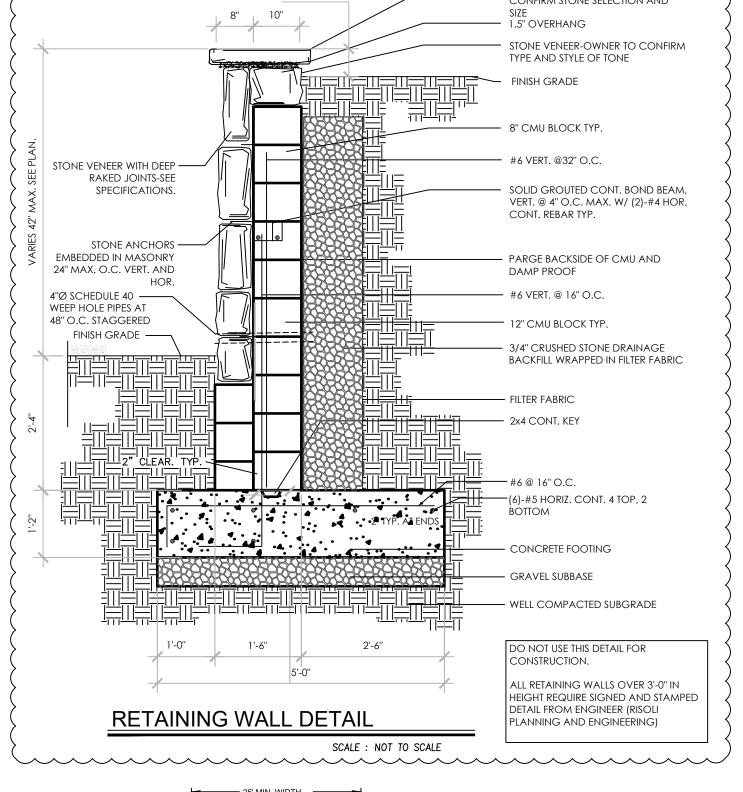

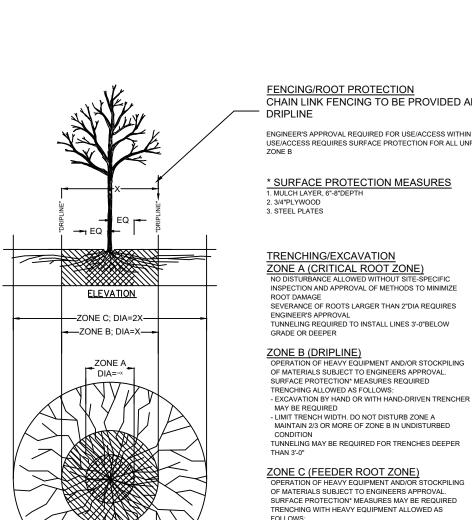

VILLAGE

SCALE: NOT TO SCALE

VILLAGE INSPECTION

CHECKED BY: B.S.

LOCATION MAP

DO NOT SCALE DRAWINGS

ENGINEER COMMENTS

ENGINEER COMMENTS

- REVISIONS -

SITE PLAN, DRAINAGE.

EROSION CONTROL

PLAN FOR NEW

IN-GROUND SWIMMING

POOL

<u>SCHIRMACHER</u>

RESIDENCE

33 PARK ROAD

IRVINGTON, NY

10533

DETAILS, CALCULATIONS

Benedict A. Salanitro,P.E.,P.C.

CIVIL ENGINEER

609 BROOK STREET

Mamaroneck, New York 10543

<u>SHEET:</u> 2.13

<u>ZONE:</u> 1F-20

DRAWING TITLE:

BLOCK: 64

DATE

DESCRIPTION