APPLICATION FOR BUILDING PERMIT

The Village of Irvington | 85 Main St | Irvington NY 10533

Application Number:	414	Date:	01/27/2023
Job Location:	15 JAFFRAY CT	Parcel ID:	2.90-44-56
Property Owner:	Sadre, Nader & Muir, Lauren	Property Class:	1 FAMILY RES
Occupancy:	One/ Two Family	Zoning:	
Common Name:			

Applicant	Contractor	
Bill Witt		
William P Witt Architects PLLC		
268 Route 202Somers NY 10589		
914-276-0225		

Description of Work

Type of Work:	Addition	Applicant is:	Architect
Work Requested by:	The Owner	In association with:	
Cost of Work (Est.):	475000.00	Property Class:	1 FAMILY RES

Description of Work

Build a one story addition and deck. Renovate existing interior spaces

Please Note: Completing the application does not constitute a permit to commence construction. To obtain your permit follow the instructions on the instruction page provided on page 3.

Job Location: 15 JAFFRAY CT

Parcel Id: 2.90-44-56

AFFIDAVIT OF APPLICANT

I

I Bill Wi	tt being duly sworn, depose and says: That s/he does business as: William P Witt Architects PLLC with offices Route 202 Somers NY 10589 and that s/he is:
	The owner of the property described herein. The of the New York Corporation with offices at:
	duly authorized by resolution of the Board of Directors, and that
:	said corporation is duly authorized by the owner to make this application.
	A general partner of and that said
	Partnership is duly authorized by the Owner to make this application. The Lessee of the premises, duly authorized by the owner to make this application. The Architect of Engineer duly authorized by the owner to make this application. The contractor authorized by the owner to make this application.
know Unifo laws	the information contained in this application and on the accompanying drawings is true to the best of his vledge and belief. The undersigned hereby agrees to comply with all the requirements of the New York State orm Fire Prevention and Building Code, the Village of Irvington Building Code, Zoning Ordinance and all other pertaining to same, in the construction applied for, whether or not shown on plans or specify in this application.
Swo	rn to before me this 3 day of February of 2023
1	Jana Niers MARIA NIEVES MARIA NIEVES
Nota	ry Public / Commission of Deeds No. 01Ni6177292 Qualified in Dutchess County My Commission Expires Apr 4, 2024 Notary Public - State of New York NO. 01Ni6177292 Applicant's Signature Applicant's Signature
OWNER'	SAUTHORIZATION
l Sadre, l perform t	Nader & Muir, Lauren as the owner of the subject premises and have authorized the contractor named above to he work under the subject application.
	er phone number Owner email address
fu	I hereby acknowledge that it is my responsibility as the property owner of ensure that if the permit (if issued) receives a Final Certificate of Approval from the Building Department and author that if a Final Certificate of Approval is not obtained upon completion of the construction, a property iolation may be placed on the property for which this permit is being requested.
S	tworn to before me this ? of day of of of
	-Alm
N	otary Public / Commission of Deeds Applicant's Signature

LIM KIM A. Notary Public, State of New York
No. 01L16144154
Qualified in Westchester County
Commission Expires Apr. 24, 20

SCALE COMPA	RISON based o	lic info.	House, detached st and covered por (w/o walks & uncover	ructures ches red patios)	
ADDRESS	LOT SIZE	FLOOR AREA	F.A.R.	LOT COVERAGE	% of LOT
15 JAFFRAY CT.	0.165 AC. +/-	2,153.5 sq.ft. Existing	.299	1,525.5 sq.ft. Existing	21.2%
Actual house size includes basement	7,195 sq.ft. +/-	2,888.5 sq.ft. Proposed	.401	1,798.5 sq.ft. Proposed	24.9%
15 JAFFRAY CT.	0.16 AC. +/-	1,427 sq.ft. Existing	.204	1,402 sq.ft. Existing	20.1%
As per property card w/o basement or walkways.	6,970 sq.ft. +/-	1,920.5 sq.ft. Proposed	.275	1,675 sq.ft. Proposed	24.0%
19 JAFFRAY CT.	0.17 AC. +/- 7,405 sq. ft. +/-	1,862 sq.ft. House not including basement	.251	1,779 sq.ft.	24.0%
11 JAFFRAY CT.	0.16 AC. +/- 6,970 sq. ft. +/-	1,054 sq.ft. House not including basement	.151	1,054 sq.ft.	15.1%
12 JAFFRAY CT.	0.13 AC. +/- 5,663 sq. ft. +/-	2,004 sq.ft. House not including basement	.353	1,447 sq.ft.	25.5%
16 JAFFRAY CT.	0.13 AC. +/- 5,663 sq. ft. +/-	998 sq.ft. House not including basement	.176	1,180 sq.ft.	20.8%
20 JAFFRAY CT.	0.14 AC. +/- 6,093 sq. ft. +/-	1,492 sq.ft. House not including basement	.244	1,662 sq.ft.	27.2%
2 W. HOME PL.	0.07 AC. +/- 3,049 sq. ft. +/-	1,365 sq.ft. House not including det. gar.	.447	1,356 sq.ft.	44.4%
6 W. HOME PL.	0.06 AC. +/- 2,614 sq. ft. +/-	1,305 sq.ft. House not including attic	.499	1,001 sq.ft.	38.2%
8 W. HOME PL.	0.09 AC. +/- 3,920 sq. ft. +/-	1,058 sq.ft. House 400 sq.ft. Garage	.308	1,145 sq.ft.	29.2%
2 E. HOME PL.	0.06 AC. +/- 2,614 sq. ft. +/-	1,284 sq.ft. House 294 sq.ft. Garage	.508	1,086 sq.ft.	41.5%
4 E. HOME PL.	0.06 AC. +/- 2,614 sq. ft. +/-	2,560 sq.ft. House	.979	1,068 sq.ft.	40.8%
					1

- NOTES:

 1. ADJACENT HOUSE LOCATIONS & SIZES BASED ON THE FOLLOWING:
- A. VILLAGE OF IRVINGTON WEBSITE AND G.I.S. MAPPING INFORMATION.
- B. TOWN OF GREENBURGH WEBSITE AND GIS INFORMATION. INCLUDING PROPERTY CARD AND G.I.S. MAPPING

W HOME PL

I O W HOME PL

12 W HOME PL

3 JAFFRAY COURT

2 JAFFRAY COURT

16 W HOME PL

- 2. LOT COVERAGE FOR ADJACENT PROPERTIES ONLY INCLUDES STRUCTURES AND ATTACHED PORCH FOOTPRINTS FROM AVAILABLE DATA. EXCLUDES WALKWAYS, STEPS, WALLS & EQUIP. PADS & SOME PATIOS
- FLOOR AREA AREA (F.A.R.) FOR ADJACENT PROPERTIES ONLY INCLUDES MAIN HOUSE & DETACHED STRUCTURES SIZE OVER 250 sq.ft. EXCLUDES BASEMENTS & ATTIC SPACE



19 JAFFRAY CT.

E HOME PL

FRONT



15 JAFFRAY CT.



15 JAFFRAY CT. RIGHT SIDE



15 JAFFRAY CT.



LEFT SIDE



16 JAFFRAY CT.





20 JAFFRAY CT.

11 JAFFRAY CT.



2 W. HOME PL.

2 E. HOME PL.

12 JAFFRAY CT.





6 W. HOME PL.

4 E. HOME PL.





AERIAL VIEW

Scale NOT TO	SCALE
Drawing By	A.O.
PEDA	_
GISTERED A	RCHIE
E PARTY	*XXX
* (/)	() *
0	13/
FOE NE	WYO
OF NO	

Date	10/17/22
Revised	

Drawing No.

PB-1



I 4 E HOME PL I O E HOME PL 4 E HOME PL E HOME PL E HOME PL W HOME PL 6 W HOME PL W HOME PL 23 JAFFRAY COURT 19 JAFFRAY COURT II5 JAFFRAY COURT I I JAFFRAY COURT JAFFRAY COURT 3 I JAFFRAY COURT 0

20 JAFFRAY COU

I 6 JAFFRAY COURT

12 JAFFRAY COURT

DIVISION I - GENERAL CONDITIONS

- 1.1 Scope of Work: Provide all labor, materials and equipment required to complete all work shown on drawings and work required for a fully completed job. All materials and workmanship shall be of the best quality. The specs below and plans included are set up as general limits and minimum standards for the scope of work so that the form and structural requirements are clearly established.
- 1.2 Code Compliance: All work and materials shall conform and comply with the current versions of the following authorities & codes: 2020 Residential Code of NYS

2020 Energy Conservation Construction Code of NYS w/ 2020 NYStretch Code as adopted. 2020 NYS Residential Plumbing Code

2020 Fire Code, 2020 Mechanical Code & 2020 Fuel Gas Code of NYS

2020 Existing Building Code of NYS National Electrical Code NFPA 70 2017 EDITION Village of Irvington Municipal Code

1.3 Work in Cold Weather: No work with materials containing water shall be carried out during unreasonably cold weather.

Such work may be started when temperature is 28 degrees F and rising, and shall be stopped when temperature is 34 degrees F and falling. Furthermore, during such cold weather conditions the following precautions shall be taken:

- a. Water shall be heated and kept warm
- b. Sand shall be heated and kept warm.
- c. An anti-freeze such as "Euco" made by Euclid Chemical Co. "Tri-Mix" by Sonnenborn, or "No Freeze" by Horn shall be added to the mixture in proportions as recommended by
- d. Material shall be placed as soon as possible and shall not be permitted to get too
- e. No material containing ice or frozen parts shall be used.

Furthermore, all work shall be protected against cold weather or frost by means of hay, straw, canvas, "salamanders" or other approved methods. Work damaged by cold weather or frost will not be accepted.

1.4 Permits: The contractor is responsible for obtaining any and all permits including the general permit from the local building department. Construction trade shall be responsible for obtaining permits relevant to their respectable trades (i.e. UL electrical permits and inspection; plumbing permits and inspections if applicable) final payment shall be subject to the contractor providing the owner with a Certificate of Occupancy upon completion of the job.

DIVISION II - SITEWORK: EXCAVATION AND BACKFILL

- 2.1 General: The work under this section shall include all necessary labor, material, equipment and fees required for the proper execution of the site work as shown on the drawings and/or described herein. The work includes building (foundation) excavation, retaining walls, backfill and rough grading.
- 2.2 Ordinances: All work shall be in conformance with all applicable codes and ordinances and shall be executed in a workpersonlike manner.
- 2.3 At no time shall bulldozers, trucks or other heavy equipment be permitted to approach foundation walls, grade beams and piers closer than 8 feet, unless walls and piers are braced and/or floor beams and joists are installed.
- 2.4 Footing Trenches: Excavate for all footings and proper subgrades. Bottom of all footings shall be level and kept free of standing water at all times. All footings shall be excavated to minimum depths shown on drawings. All footings shall be set on virgin soil with a minimum bearing capacity of 2,000 P.S.F.
- 2.5 Where footings are stepped, bottoms to be stepped not more than two feet vertical to
- 2.6 Where rock is encountered, the contractor shall notify the architect immediately. The contractor shall expose all areas cleanly for inspection. The architect and his structural consultant will advise the contractor of the measures for construction.
- 2.7 Backfill is to be comprised of clean earth, free from any wood or debris.
- 2.8 Backfill and subgrades below slabs shall be placed in 6" lifts and to be compacted at every lift. Areas under concrete slabs to be backfilled shall be fully compacted to 95% of proctor density with power tamper. All other backfill to be placed in 12" lifts and compacted at every lift.
- 2.9 Do not backfill against foundation walls until the concrete has achieved design strenath and/or until first floor framing is secured.
- 2.10 Finish grade is to slope away from the building on all sides and to follow grading plans if provided.
- 2.11 Termite and pest control: Provide a continuous fiberglass seal in between p.t. sill plates and top of foundation walls.

DIVISION III - CONCRETE

- 3.1 General: Work includes concrete footings, foundation walls, grade beams and piers, slabs on grade and all concrete work indicated on drawings or as hereinafter specified.
- 3.2 Concrete: "Ready-Mix" product, proportioned to produce a min. 3,000 psi comp. strength concrete for use in found. walls, footings, grade beams and piers and interior floor slabs. Min. 3.500 psi comp. strength concrete shall be used for all horizontal surfaces exposed to the weather including: porches, steps, walks and garage floor slabs, batched at a central plant; and transported dry to the site. Water for a four inch (4") slump shall be added at the job site and mixing carried out for fifteen (15) minutes.
- 3.3 Slabs on Grade: All floor slabs on grade shall be four inches (4") thick with 6x6 #10 mesh reinforcing, steel trowel finish. (At the owners option, garage slabs shall be (5") thick with 6×6 #10 mesh reinforcing).

Subgrades shall be maintained eight inches (8") below finish floor. Over entire area of subgrade, fill with minimum four inches (4") compacted bank run gravel and sand topping to eliminate protrusions. Provide a 6 mil polyethylene film vapor barrier over the sand topping with 6" lap at joints.

3.4 Steel Reinforcing: Provide reinforcement for all footings where indicated on drawings. Consult architect if soil beaming capacity does not have a minimum bearing capacity of 2,000 P.S.F., or if footings are set on fill and rock, for steel reinforcing requirements.

DIVISION IV - MASONRY

- 4.1 General: The work required under this section consists of all masonry work related items necessary to complete the work indicated on drawings and specified herein and/or as required by job conditions.
- 4.2 Concrete Block:
- a. All concrete block at below grade conditions shall be standard 60% solid 8" high x 16" long units in widths indicated on drawings. Blocks shall extend from top of footings to 8" above finished grade, or as indicated on sections and details.
- b. Provide square finished end blocks at all ends of block walls above grade.
- c. All block shall be laid in running bond, reinforced every second course with 9GA galvanized wire "Dur-O-Wall" reinforcing.
- d. Provide a raked joint at all exposed concrete block.

DIVISION V - METALS

- 5.1 General: Steel construction shall conform to AISC Manual of Steel Construction, 9th
- 5.2 Material: All structural steel shall conform to ASTM A-36. Columns shall be 3" I.D.

1/2" round x 12" long anchor bolts, in concrete and 16" long in masonry, 4'-0" O.C.,

- tube columns with sizes and locations indicated. 5.3 Anchor bolts: shall be A36 or A307 steel, placed in all foundation walls, set up high to attach the sillplates as indicated on sections and details See sections for locations of bolts for proper alignment with wood plates. If masonry is used, fill top of all block walls solid. The top of all foundation walls shall receive
- maximum 1'-0" from corners and a minimum of two bolts in each plate. Minimum anchor bolt embedment into concrete shall be 7" as per R403.1.6 5.4 All structural steel shall be shop painted with gray zinc chromatic primer 2.0 mils
- 5.5 Provide shop drawings for all structural steel to architect for approval prior to

DIVISION VI - WOOD

6.1 Rough Carpentry

- a. Framing Lumber: All first floor sill plates shall be construction grade, "S.Y.P." pressure treated minimum Fb=1550 psi. All other framing shall be construction grade "Doug. Fir," No. 2 and better, with a minimum Fb of 1000 psi and a maximum moisture content of 19%
- b. Cross bridging: "Doug. Fir" No. 2 and better construction grade, $5/4 \times 3$, $8' \times 0$ " maximum O.C. in all floor and roof framing.
- c. Subfloor sheathing shall be one layer 3/4" T&G CD interior plywood glued and screwed to floor joists as per manufacturers specs.
- d. Roof sheathing shall be 5/8" CDX; wall sheathing shall be 5/8" CDX plywood.
- e. All sheathing shall have a panel span rating of 32/16. Panel grades shall be APA rated "Sturd-I-Floor" for subfloors.
- f. Face grain of plywood to be perpendicular to joists and studding, with staggered joints. Provide clips where necessary.
- Wall studs: shall be 2x6 16" O.C. for exterior walls and 2x4 16" O.C. for interior partitions, or as noted otherwise.
- Rafters and floor joists shall be sizes, spans and locations as indicated on
- All LVL beams indicated on framing plans shall be as manufactured by "Weyerhaeuser"; sizes, spans and locations shall be as indicated on framing plans. Installation, nailing and the use of framing connectors shall be in accordance with the manufacturer's recommendations.
- All engineered framing members indicated on framing plans shall be as manufactured 7.9 by "Weyerhaeuser"; sizes, spans and locations shall be as indicated on framing plans. Installation, nailing and the use of framing connectors shall be in accordance with the manufacturer's recommendations.

Workmanship and Construction:

- a. All partitions to have single shoe and double cap plates, double studding around all openings, at corners and property trussed across all openings. Corners for all rooms to be framed solid for interior finish. Wood cats shall be placed between studs in all bearing partitions and those over 8' high.
- b. Beams and girders: Three-inches (3") minimum bearing over all supports. All headers and tail beams not supported by wood ledgers shall rest on metal hangers, "Teco" or equal. Splice over supports.
- c. Provide solid post or solid studding below all beams and girders at bearing points. Provide single jack studs at all openings to support headers.
- d. Set all beams, girders, joists and rafters with natural crown up.
- e. All wood plates and sills in contact with concrete shall be pressure teated, S.Y.P.
- f. Nailing: All perimeter (exterior) walls and interior bearing walls studs, jack studs and posts, shall be toe-nailed to sole and cap plates with three 16 penny nails, one nail on one side and two on opposite. Double end nailing is permitted to set partitions and can remain on non-bearing interior walls only

6.2 Finish Carpentry

MATERIALS

- a. 1. Exterior siding shall be "Hardie panel" vertical siding with 8" +/- exposure & "Hardie Plank" clapboard siding. Color as selected by owner. Provide owner w/ samples prior to installation. Remove existing siding and install new as per elevations
- 2. Exterior non-sided areas (panels, soffits, underside of cantilevered projections) shall be 1/2" Hardie panels.
- Exterior trim, bases and fascias shall be 1x & 5/4x Hardie trim or as noted on drawings.
- Interior trim around doors, windows and base shall be as indicated on drawings and general notes. 2 1/2" Sanitary Casing & 3 1/2" Sanitary base
- . Wood strip flooring shall be wide plank engineered wood as selected by owner. Laid in all areas of first floor except bathrooms or as noted on drawings. Install as per manufacturers specifications.

Workmanship:

- a. Work shall be accurately and neatly done, properly plumbed, squared or leveled
- b. Exterior hardware and all exterior nails shall be galvanized or of non-ferrous rust-resistant metal. Countersink nails and set nails in putty where face nailing is required. All nailing shall be blind wherever possible.

6.3 Wood Decks:

Materials: All lumber for deck framing shall be decay resistant, pressure treated Southern Yellow Pine or equal, with a minimum of 1550 psi stress grade. All rails shall be as indicated on drawings. All decking shall be 5/4" X 6" Trex transcend decking. All components of railing & deck to be finished in color as selected by owner.

Workmanship and Construction:

- a. All framing not resting on wood leaders shall rest on metal hangers, "Teco" or
- b. Decking members shall be installed with a "Finish-Nail" thickness separation to allow drainage of water and shrinkage.
- c. Deck railings shall have a minimum height of 3'-0". Spacing between railing members shall not exceed 3.9". d. No framing or finished wood shall be within 8" of finished grade.

DIVISION VII - THERMAL AND MOISTURE PROTECTION

- 7.1 Dampproofing: All foundation walls below grade shall be treated "Tuff N Dri" sprayon membrane by Owens/Corning. Follow manufacturer's instructions strictly for application. Provide a 1" thick protection board between membrane and earth. Material shall not extend above finished grade, and shall extend down to bottom of footing.
- Insulation: Shall be fiberglass batt-foil in the following thickness: Closed cell spray foam of matching R values may be substituted.
 - a. Exterior walls: Fiberglass Batt (R-15) @ existing 2x4 walls & (R-21) @ new 2x6 walls. or spray foam equiv. at R-6.5 per inch closed cell
 - b. Roof / Clg: (R-49) spray foam equiv. at R-6.5 per inch closed cell at new construction.
 - c. Floor: Fiberglass Batt 9" thick (R-30).
 - Slab edge: rigid board, 24" long with a minimum R-10 rating.
- 7.3 Roofing: Shall be GAF Lifetime shingles as selected by owner. Roof shingles shall be set above 15# felt building paper. Also install "GAF Weatherwatch" waterproof underlayment along all eaves, valleys and crickets for a distance of 6'-0" from lowest edge up sloping portion of roof. Install in accordance with manufacturers instructions.
- Flashing: Flash all hips, valleys, projections through roof, intersections of roof and vertical surfaces, including drip and rake edges, and any other conditions shown on the drawings or requiring flashing. Finished surfaces shall be copper to match existing finish or as otherwise indicated on drawings.
 - (All flashing, i.e., drip and rake edges, counter flashing, etc., shall be aluminum or copper as called out on drawings. All seams shall be soldered and shall have a minimum overlap of 6". All flashing along drip and rake edges shall be secured to roof cross framing & shall extend a minimum of 18" under the roof shingles. All exposed drip and rakes shall have a maximum of 1 1/4" exposure along the fascias.)
- Sealants: Provide sealant around all doors, windows and other openings for a watertight condition. Sealant shall be gun grade gum consistency. Color to be selected
- 7.6 Air Infiltration Barrier: All exterior walls shall be wrapped with "Tyvek" air infiltration barrier as manufactured by "Dupont". Follow manufacturer's instructions for installation.
- Ridgevents shall be "Cor-Vent" corrugated plastic installed in strict accordance with manufactures directions ready to receive capshingles or equal. Vents shall run continuous across ridges to within 6" of ends.
- 7.8 All soffit vents shall be material as noted on drawings or to match existing.
- Install white aluminum k style gutters and leaders at whole house. leader to extend to new drywells and existing piping.

DIVISION VIII - DOORS AND WINDOWS

- Interior Doors: The contractor may have doors pre-hung if he coordinates each door type. Doors shall be (1) panel prehung 1 5/8" thick solid composite or to match existing in sizes as indicated on plans. Standard hardware as provided by owner. Provide 1 1/2 pair butts on each door.
- Windows: Sizes and types as shown on the drawings. All glazing shall be low-e insulated glass, units shall be equipped with screens and hardware for locking and operation. Units shall be in sizes and models as indicated on plans. Wood / clad units shall be as manufactured by "Andersen", and shall be finished as selected by owner.
- 8.3 All doors and windows with glazing less than 18" AFF shall be tempered glass.
- 8.4 French Doors: Shall be glazed with tempered, insulated glass complete with locks Wood / clad units shall be as manufactured by "Andersen", and shall be finished as selected by owner.

DIVISION IX - FINISHES

- Gypsum Board: Gypsum board shall be 1/2" gypsum board, tapered edge. Provide "Dur-O-Rock" behind any ceramic tile in wet areas.
 - Provide a three coat compound and sanding finish over all gypsum board areas in preparation for paint and/or other finish.
 - Provide 5/8" firecode "C" Gypsum board in areas where fire-rating as required, in thickness of one layer for one hour wall and two layers for two hour walls.
- Ceramic Tile: Install owner supplied ceramic tile at areas indicated on plans. Tile shall be in sizes as selected by Owner, and installed over 1/2" plywood underlayment laid over 3/4" plywood subfloor. Set tile in a setting bed and grout according to manufacturer's installation instructions. A one-part mildew-resistant silicone sealant shall be applied over tile in nontraffic areas. A multi-part pourable urethane sealant shall be used in high-traffic areas. Contractor may elect to install tile over reinforced cement mud job as an alternate.
- Marble Thresholds: Shall be ASTM C 503 and as follows: Color to be white with a honed finish. Classification to be "Group A" as per the M.I.A. soundness classification.
- 9.4 Painting and Staining: (if included)

clean the windows thoroughly.

- Materials: Unless otherwise specified, exterior stain or paint shall be manufactured by "Benjamin Moore" Stain or paint of all exterior surfaces, including trim, doors
- windows, fascias, soffits, columns, railings shall be selected by the owner. Workmanship and Construction: Contractor shall furnish and lay drop cloths in all areas where painting is done and shall protect floors and other work from damage during the process of this work. Oily rags and waste must be removed from the building at the end of each work day. Upon completion of work, the painter shall clean off all paint spots from glass, hardware and other items not to be painted, and

Painting contractor is responsible for all putty work and finish sanding.

a. Interior: It is the intention of this specification to require two (2) coats of paint or stain to all unfinished surfaces inside the building, the taping of all sheetrock surfaces, and painting of the same as indicated. Interior trim around doors and windows, and base trim shall receive (2) coats of semi-gloss latex paint.

Interior Flooring and Stairs: Interior wood finish flooring shall receive (1) coat of stain under (1) coat of sealer under (2) coat of polyurethane. Interior stairs and handrail will receive (1) coat of stain (in color to match finish flooring if present, or as selected by Owner) under (2) coats of polyurethane.

DESIGN LOADS (for areas of new construction) GROUND SNOW LOAD 30 psf. LOWER FLOOR LIVE / DEAD LOAD 40 / 12 psf UPPER FLOOR BED. LIVE / DEAD 30 / 12 psf UPPER FLOOR OTHER LIVE / DEAD 40 / 12 psf. ROOF LIVE / SNOW LOAD | 30 / 15 psf

DIVISION X - SPECIALTIES

- 10.1 Mirrors: Shall be supplied by owner and installed in areas shown and in sizes as indicated by plans. Material shall be 1/4" thick polished plate with polished edges and properly glued to
- 10.2 Accessories: Install owner supplied bathroom accessories. at locations verified in field.

DIVISION XI - MECHANICAL

- 11.1 Plumbing: It is the intention of this specification to require conection to the existing water supply and waste water evacuation system. The contractor shall supply and install the equipment, fixtures and fittings as selected by the owner and located on the drawings in full conformance with the applicable local and national plumbing codes. Contractors shall supply certificates of inspection and compliance to the owner upon completion.
- All new plumbing fixtures to be located in compliance w/ section R307 of the Residential Code of NYS.
- 11.2 Heating: (see suplimental instruction to bidders for detailed HVAC requirements. Provide heating to all new finished area's to comply with section R303.8 of the Residential
- Building Code of the State of New York. **HVAC NOTE:**

All mechanical / HVAC work to be filed separately

by mechanical sub contractor. (Verify submission reg'ts.)

11.3 Cooling: see heating above.

DIVISION XII - ELECTRICAL

12.1 It is the intention of this specification to require connection to the existing electrical system as per the fire Prevention and Building Code or any agency having authority. The systems and each of its components shall conform to all applicable codes. All equipment and fixtures shall be selected by the owner. The contractor shall supply the owner with certificates of inspection and compliance upon completion. All required panels and subpanals are assumed to be included.

ENERGY STATEMENT

To the best of my knowledge, belief and professional judgement, such plans and specifications are in compliance with the current version of the 2020 Energy Conservation Construction Code of NYS w/ prescriptive energy requirements of the 2020 NYStrech Code as adopted.

GENERAL NOTE

Not all portions of this specification may be applicable to the proposed project Contractors to verify any and all discrepancies with Architect prior to submitting contruction proposal.

SMOKE / CARBON MONOXIDE DETECTORS

Provide & install hard wired, interconnected smoke detectors and carbon monoxide detectors to all portions of the residence as required by current version of the New York State Residential Building Code or any other applicable code.

Construction Type: 5b existing & proposed

ARC-FAULT PROTECTION: Arc-Fault circuit-interrupter protection shall be provided as per E3902.16 of the 2020 Residential Code of NYS OCCUPANCY & CONSTRUCTION TYPE: Occupancy classification: R-3 existing & proposed

DRAWING LIST SHEET TITLE A-100 | SPECIFICATIONS & GENERAL NOTES A-101 | SITE PLAN, NOTES & ZONING DATA A-102 | PROPOSED FLOOR PLANS A-201 | PROPOSED EXTERIOR ELEVATIONS A-301 | SECTIONS, DETAILS & WINDOW SCHEDULE A-401 PLAN DETAILS & INTERIOR ELEVATIONS E-101 | ELECTRICAL PLANS F-101 | FRAMING PLANS X-101 EXISTING FLOOR PLANS X-201 EXISTING EXTERIOR ELEVATIONS

CLIMATIC AND GEOGRAPHI DESIGN CRITERIA	IC .				
GROUND SNOW LOAD 30 psf					
WIND DESIGN					
WIND SPEED	115-120 mph				
TOPOGRAPHIC EFFECTS	NO				
SPECIAL WIND REGION	YES				
WIND-BORN DEBRIS ZONE	NO				
SEISMIC DESIGN CATAGORY	С				
SUBJECT TO DAMAGE					
WEATHERING	SEVERE				
FROST DEPTH	42"				
TERMITE	MODERATE/HEAVY				
WINTER DESIGN TEMPATURE	0°- 10°				
ICE BARRIER UNDERLAYMENT REQUIEMENT	YES				
FLOOD HAZARDS MAP # 36119CO261F	NO				
AIR FREEZING INDEX	2000				
MEAN ANNUAL TEMPATURE	51.6 °F				

CHITE NY 10589 gmail.com X


Additions & Alterations
ADRE & MUIR
RESIDENCE

PROJECT CIFICATION

AS NOTED Drawing By A.O.

S

Date 1/20/23 Revised

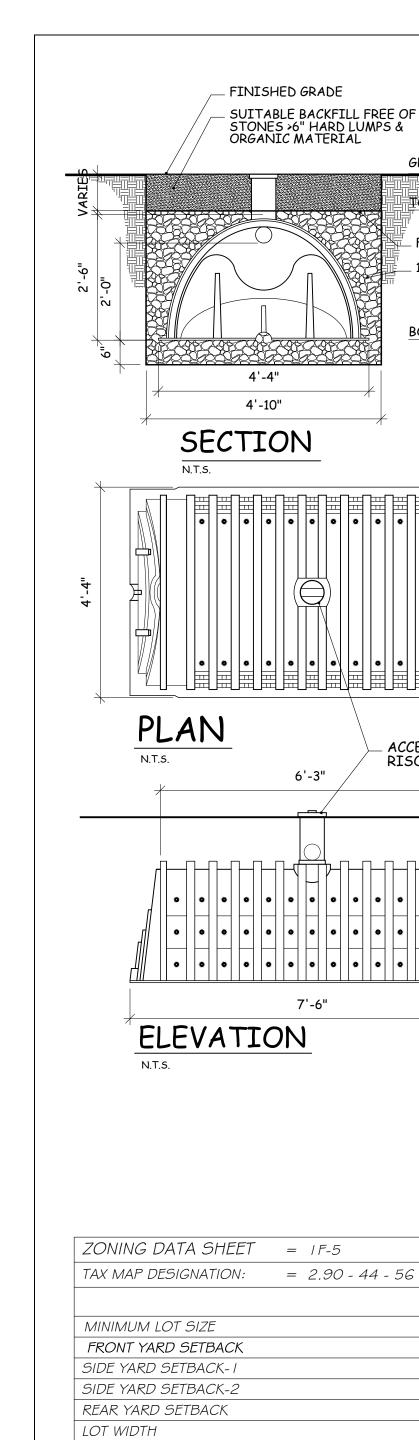

GRADE 135'+/-

TOP/ OVERFLOW

FILTER FABRIC

BOTTOM 130' +/-

1 1/2" TO 2" STONE


ACCESS PORTS WITH 6" PVC. PIPE

RISOR INSTALLED AS NECESSARY

FINISHED GRADE

STORMTECH SC-740 OR CULTEC RECHARGER 330

INFILTRATION UNIT.

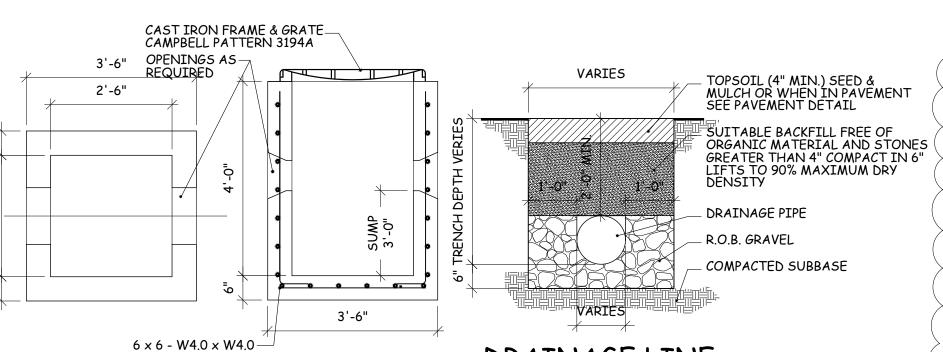


DRAINAGE LINE TRENCH DETAIL YARD DRAIN PLAN SECTION

INFILTRATION SYSTEM DESIGN DESIGN STORM 5.8 INCHES = 0.483 ET.

REQUIRED TREATMENT VOLUMES 343 SF. NEW ROOF (REAR ADDITION) @ 100% $343 \times 0.483 = 165.6 \, CF.$

TOTAL REQUIRED TREATMENT VOLUME 165.6 CF. REQUIRED ROOF TO BE TREATED 164.6 CF. / 0.483 = 343 SF.

PROVIDE TREATMENT VOLUMES DESIGN VOLUME ST. 740 = 67.61 CF. EACH 164.6 / 67.61 = 2.43 or USE 3 UNITS $3 \times 67.61 = 202.83 > 164.6$ CF.

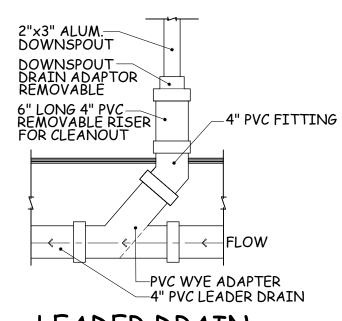

LEADER DRAIN

1. Existing gutters / leaders extend to above & below ground piping & or drainage structures.

- Existing downspouts Locations & piping to remain undisturbed. 2. The infiltration system must not be connected until construction is complete and the site is
- 3. All downspouts from the proposed rear addition, (343 sf.) to be connected to the
- 4. Cut and fill material shall not be imported to or exported from the site.
- 5. The building inspector or village engineer may require additional erosion control measures if deemed appropriate to mitigate unforeseen siltation and erosion of disturbed soils.
- 6. "As-Built" drawings of the site improvements shall be submitted to the Village Engineer for review prior to obtaining Certificate of Occupancy.
- 7. The setting and infiltration chambers shall be inspected annually to determine the depth of solids accumulated therein. When the depth of solids exceeds 3/4 of the depth of the chamber they are to be removed. If significant solids are accumulated within the infiltration chambers they should be removed.
- 8. The infiltration system access ports shall be shown on the "As Built"
- 9. The area of the proposed infiltraction system shall be protected from over -compaction during construction. Fence off area during construction or de-compact soil prior to installation of infiltration units. POST CONSTRUCTION NOTES:

1. Clean out catch basin twice yearly or as needed.


2. Visually inspect dry well access ports yearly.

	PERMITTED	EXISTING	PROPOSED	COMMENTS
MINIMUM LOT SIZE	5,000 sq.ft.	7,194.9 sq.ft.	7,194.9 sq.ft.	MEETS REQUIREMENTS
FRONT YARD SETBACK	30'	30.1'	30.1'	MEETS REQUIREMENTS
SIDE YARD SETBACK- I	10'	14.6'	14.6'	MEETS REQUIREMENTS
SIDE YARD SETBACK-2	10'	14.0'	13.3' +/-	MEETS REQUIREMENTS
REAR YARD SETBACK	30'	39' +/-	31.6' +/-	MEETS REQUIREMENTS
LOT WIDTH	50'	59'	59'	MEETS REQUIREMENTS
LOT DEPTH	100'	116.77+	116.77+	MEETS REQUIREMENTS
HEIGHT	35'	24.25'	24.25'	MEETS REQUIREMENTS
TOTAL LOT COVERAGE (5,000 x 24% + 16% of 2,194)	1,551 sq.ft.	1,525.5 sq.ft.	1,798.5 sq.ft.	EXCEEDS MAXIMUM ALLOWED
FLOOR AREA CALCULATIONS	EXISTING	PROPOSED	INCREASED	
BASEMENT	544 sq.ft.	922 sq.ft.	378 sq.ft.	
GARAGE	296 sq.ft.	296 sq.ft.	0 sq.ft.	
FIRST FLOOR	982.5 sq.ft.	1,339.5 sq.ft.	357 sq.ft.	
SECOND FLOOR	581 sq.ft.	581 sq.ft.	0 sq.ft.	
ATTIC	N/A	N/A	N/A	
TOTAL FLOOR AREA	2,153.5 sq.ft.	2,888.5 sq.ft.	735 sq.ft.	
MAX. PERMITTED FAR (.36 x 7, 194) = 2,589	2,589 sq.ft.			

CLIMATIC AND GEOGRAPH DESIGN CRITERIA	IC
GROUND SNOW LOAD	30 psf
WIND DESIGN	,
WIND SPEED	115-120 mph
TOPOGRAPHIC EFFECTS	NO
SPECIAL WIND REGION	YES
WIND-BORN DEBRIS ZONE	NO
SEISMIC DESIGN CATAGORY	С
SUBJECT TO DAMAGE	
WEATHERING	SEVERE
FROST DEPTH	42"
TERMITE	MODERATE/HEAVY
WINTER DESIGN TEMPATURE	0°-10°
ICE BARRIER UNDERLAYMENT REQUIEMENT	YES
FLOOD HAZARDS	NO
AIR FREEZING INDEX	2000
MEAN ANNUAL TEMPATURE	51.6° F

	COVERAGE CALCULATIONS	EXISTING	PROPOSED	INCREASE
	MAIN HOUSE	982.5 sq.ft.	1,339.5 sq.ft.	357 sq.ft.
mph	SCREENED PORCH	192 sq.ft.	O sq.ft.	-192 sq.ft.
ПРП	FRONT PORCH	41 sq.ft.	27 sq.ft.	-14 sq.ft.
	FRONT WALKWAY \$ STEPS	118 sq.ft.	118 sq.ft.	O sq.ft.
	REAR DECK \$ STEPS	172 sq.ft.	284 sq.ft.	112 sq.ft.
	STONE CURB	20 sq.ft.	20 sq.ft.	O sq.ft.
	DRIVEWAY	313 sq.ft.	313 sq.ft.	O sq.ft.
	A/C EQUIP. PAD	N/A	10 sq.ft.	10 sq.ft.
E/HEAVY	TOTAL COVERAGE	* 1,525.5 sq.ft.	* 1,798.5 sq.ft.	273 sq.ft.
L/IILAVI	* LOT COVERAGE TOTAL EXCL MAX. LOT COV. PERMITTED		7	

INSULA	INSULATION AND FENESTRATION REQUIREMENTS BY COMPONANT									
CLIMA ZONE		SKYLIGHT "b" U-FACTOR	GLAZED FENESTRATION SHGC	CEILING R-VALUE	WOOD FRAME WALL R-VALUE	MASS WALL R-VALUE	FLOOR R-VALUE	BASEMENT WALL "c" R-VALUE	SLAB "d" R-VALUE \$ DEPTH	CRAWLSPACE WALL "c" R-VALUE
4	0.32	0.55	0.40	49	20 or 13 + 5 h	8/13	19	10/13 "c"	10, 2ft.	10/13 "c"

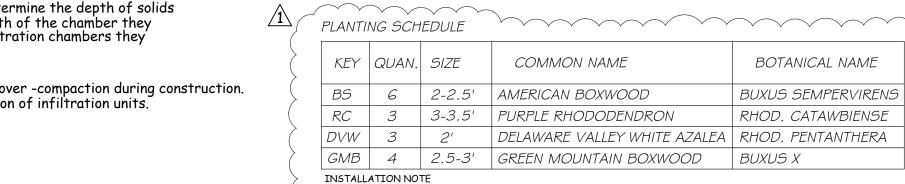

4. MULCH PLANTS W/ 2-2.5" OF CEDAR BARK

SEE NOTE 2

DEPTH VARIES

SEE NOTE 2

SIDE SLOPES (SEE BELOW)

CONCRETE WASHOUT AREA

1. CONCRETE WASHOUT AREA(S) SHALL BE INSTALLED PRIOR TO CONCRETE PLACEMENT ON SITE. THE CONCRETE WASHOUT AREA SHALL BE ENTIRELY

2. LOCATION: WASHOUT AREA(S) ARE TO BE LOCATED AT LEAST 50 FEET FROM

ANY STREAM, WETLAND, STORM DRAINS, OR OTHER SENSITIVE RESOURCE.

NOT LIMITED TO, OPERATIONS ASSOCIATED WITH GROUT AND MORTAR.

3. SURFACE DISCHARGE IS UNACCEPTABLE. THEREFORE, HAY BALES OR OTHER CONTROL MEASURES, AS APPROVED BY THE ENGINEER, SHOULD BE USED

5. HARDENED CONCRETE WASTE SHOULD BE REMOVED AND DISPOSED OF WHEN

4. WASHOUT AREA(S) ARE TO BE INSPECTED AT LEAST ONCE A WEEK FOR STRUCTURAL INTEGRITY, ADEQUATE HOLDING CAPACITY AND FOR LEAKS,

WITH ALL APPLICABLE LAWS, REGULATIONS, AND GUIDELINES.

ALL PLANTS TO BE FREE OF DISEASE
WOODY PLANT PITS DUG 12" WIDER THAN ROOT BALL, BACKFILL W/ TOPSOIL.
SOAK ALL PLAN ROOTS AT TIME OF PLANTING

SIZE: THE WASHOUT MUST HAVE SUFFICIENT VOLUME TO CONTAIN ALL LIQUID AND CONCRETE WASTE GENERATED BY WASHOUT OPERATIONS INCLUDING, BUT

AROUND THE PERIMETER OF THE CONCRETE WASHOUT AREA FOR CONTAINMENT.)

THE WASTE HAS ACCUMULATED TO HALF OF THE CONCRETE WASHOUT'S HEIGHT. THE WASTE CAN BE STORED AT AN UPLAND LOCATION, AS APPROVED BY THE

ENGINEER. ALL CONCRETE WASTE SHALL BE DISPOSED OF IN A MANNER CONSISTENT

HAY BALES OR COMPACTED EARTH BERM (SEE NOTE 3)

. 10 MIL POLYETHYLENE SHEETING

PROTECTION NOTE:

PUST CONTROL NOTES:

> INTSTALL 3/4" PLYWOOD SHEETS OVER 8" — WOOD CHIP MULCH AT CRITICAL ROOT ZONE OF PROTECTED 32" MAGNOLIA TREE ON NEIGHBORING PROPERTY

PROVIDE MISTING WATER SPRAYS TO REDUC AIRBORN DUSTING DURING EXCAVATION AND EXTERIOR CONSTRUCTION ACTIVITIES

AVOID DUST GENERATING WORK DURING DRY \$ HIGH WIND DAYS.

SAND BAGS TO SECURE SHEETING (OR METHOD AS DIRECTED BY RNGINEER)

SIDE SLOPES TO BE 2:1 OR 3:1 (NOMINAL)

EXISTING GROUD

STABILZE ENTIRE PILE WITH VEGTATION OR COVER SLOPE OR LESS STRAWBALES OR SILT FENCE INSTALLATION NOTE .NSTALLATION NOTE

AREA CHOSEN FOR STOCKPILING OPERATIONS SHELL BE DRY & STABLE

MAXIMUM SLOPE OF STOCKPILING SHALL BE 1:2

UPON COMPLETION OF SOIL STOCKPILING EACH PILE SHALL BE
SURROUNDED BY SILT FENCING OR STRAWBELZED WITH
VEGETATION OR COVERED

SEE SPECIFICATIONS (EROSION CONTROL) FOR INSTALL OF SILTFENCE

-FINISHED GRADE 4" COMPACTED GRAVEL

DECK LANDING PAD SOIL STOCKPILE DETAIL

1. Install erosion control and tree protection measures.

7. Remove erosion control and tree protection measures.

4. Excavate for and install infiltration system and required piping.

10' MAX. C. TO C


2. Excavate for new slab on grade foundations

6. Stabalize site and install new landscaping.

CONSTRUCTION SEQUENCE:

5. Back fill infiltration system

3. Erect structure

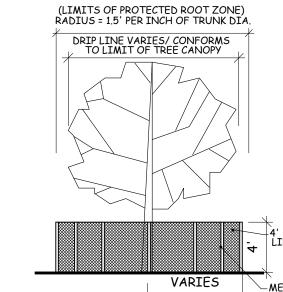

-METAL POLES W/ MAX. SPACING OF 6' DRIVEN MIN. 18" INTO TREE PROTECTION

TREE PROTECTION NOTES: WHEN EXCAVATING WITHIN ANY CRITICAL ROOT ZONE, PRELIMINARY EXPLORATION SHOULD BE PERFORMED WITH AN AIR SPADE TO UNCOVER ANY ROOTS.

- 2. WHEN ROOTS ARE ENCOUNTERED IN ANY EXCAVATION, ROOT PRUNING SHALL BE PERFORMED BY A CERTIFIED ARBORIST UTILIZING APPROVED METHODS. WHEN TRENCHING FOR PIPING & ROOF LEADERS, TUNNEL UNDER ROOTS WHERE POSSIBLE & BRIDGE ROOTS GREATER THAN 1" DIAMETER.
- 3. BACKFILL THE EXCVAVATION AS SOON AS POSSIBLE AND WATER THE SOIL AROUND ROOTS TO AVOID AIR

 4. NO WORK OR MATERIAL STORAGE SHALL BE PERMITTED BEYOND THE DISTURBANCE LIMIT LINE OR WITHIN ANY PROTECTIVE TREE BARRIER.

 5. PROTECTIVE TREE BARRIERS ARE TO BE MAINTAINED AND REMAIN IN PLACE UNTIL ALL SITE WORK IS COMPLETE AND WITH APPROVAL FROM VILLAGE INSPECTOR.
- 6. PROTECTION FENCING SHALL NOT BE INSTALLED CLOSER TO THE TREE THAN THE DRIPLINE OF THOSE TREES TO BE SAVED UNLESS NOTED ON THE PLAN. 7. NO MECHANINCAL EXCAVATION WITHIN THE DRIP LINE OF ANY PROTECTED TREE (HAND DIG ONLY)

PERSPECTIVE VIEW

N.T.S. (IF REQUIRED) CONSTRUCTION SPECIFICATIONS,

WOVEN WIRE FENCE (MIN. 14 GAUGE W/ MAX. 6" MESH SPACING)

- 36" MIN. LENGTH FENCE

POSTS DRIVEN MIN. 16"

= 16" MIN.

IŅ TO GROUND.

WOVEN WIRE FENCE

(MIN. 14 1/2" GAUGE

EMBED FILTER CLOTH

A MIN. OF 6" IN GROUND


SILT FENCE DETAIL

W/ MAX. 6" MESH

SPACING) WITH FILTER CLOTH

— HEIGHT OF FILTER COMPACTED SOIL

- 1. FILTER FABRIC TO EMBEDDED IN SOIL A MIN. OF 6 INCHES
- 2. INSPECTIONS SHALL BE FREQUENT AND REPAIR OR REPLACEMENT SHALL BE MADE PROMPTLY AS NEEDED. 3. SILT FENCE TO BE REMOVED AT END OF CONSTRUCTION BUT NOT BEFORE
- ALL DISTURBED AREA ARE STABILIZED AND VEGETATED. 4. FOR SILT FENCE INSTALLATION ON PAVED AREAS REMOVE PORTION OF ASPHALT NECESSARY TO TOE-IN THE FABRIC AND TO INSTALL THE POSTS. THE PAVEMENT HAS TO BE RESTORED BEFORE FINAL SITE CLEANING.

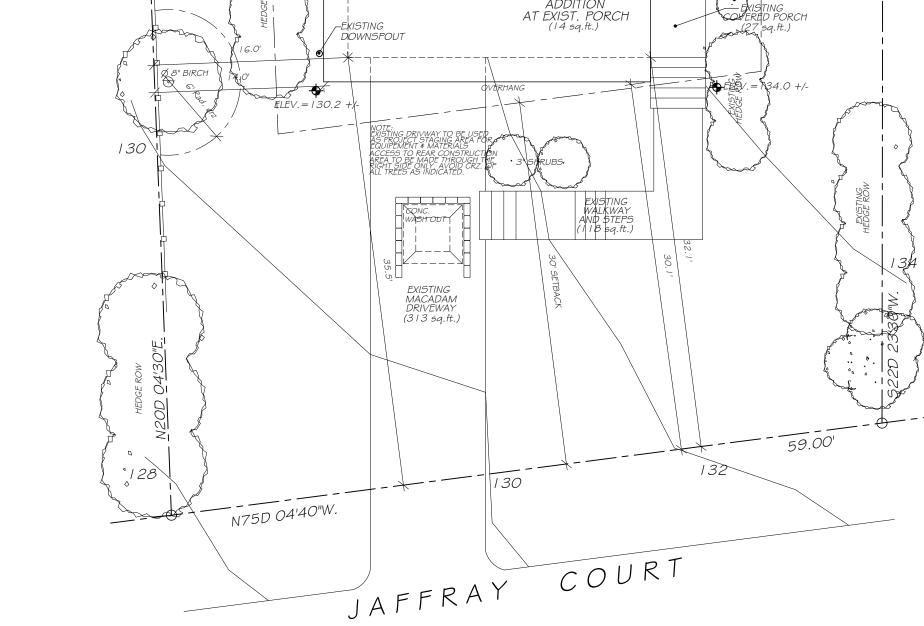

EXISTING I 1/2 STORY

FRAME HOUSE

BASEMENT ELEV.

SECTION-BLOCK-LOT = 2.90-44-56-LOT AREA = 7,194.9 sq.ft. +/-OR 0.165 AC. +/-

= 1F-5

GRINNELL STREET

STONE RUBBLE CURE (20 sq.ft.)

DISTURBANCE

TREE PROTECTION AT—/ CRITICAL ROOT ZONE

I O' SETBACK

DOWNSPOUT

SITE PLAN NOTES:

N/F PARSONS, BROOKS \$ VIRGINIA 2 W. HOME PLACE 2.90-44-47

PROROSED-DOWNSPOU

ELEV. = 134.5

TEMP. SOIL STOCKPILE -

O WORK OR ACCESS.

DNSTRUCTION AND LIMIT FDISTURBANCE MITS OF CONSTRUCTION PROX. 850 sq.ft.

ELEVI 138.2' +/-

132

36" MIN. FENCE POST

_ UNDISTURBED

GROUND

- NO STEEP SLOPES EXIST WITHIN THE AREA OF NEW OR EXISTING CONSTRUCTION.
- SITE PLAN BASED ON SURVEY AS PREPARED BY SUMMIT LAND SURVEYING P.C. LAND SURVEYORSTED 06/04/2022. TOPO & SPOT ELEVATIONS BASED ON FIELD OBSERVATIONS & GIS TOPO MAPS

ZONE

- 3. NO EXISTING UTILITIES WILL BE DISTURBED BY THE PROPOSED WORK.
- 4. EXISTING TOPOGRAPHY WILL REMAIN AS IS AND NO NEW RE-GRADING IS PROPOSED.
- VILLAGE ENGINEER NOTES:
- THE BUILDING INSPECTOR OR VILLAGE ENGINEER MAY REQUIRE ADDITIONAL EROSION CONTROL MEASURES IF DEEMED APPROPRIATE TO MITIGATE UNFORESEEN SILTATION AND EROSION OF DISTURBED SOILS.
- AS BUILT DRAWINGS OF THE SITE IMPROVEMENTS SHALL BE SUBMITTED TO THE VILLAGE ENGINEER FOR REVIEW PRIOR TO OBTAINING CERTIFICATE
- 3. CUT / FILL MATERIAL SHALL NOT BE IMPORTED OR EXPORTED FROM THE SITE 4. NO EXISTING UTILITIES WILL BE DISTURBED BY PROPOSED WORK,
- THE STORM WATER SYSTEM HAS BEEN DESIGNED TO CAPTURE THE VOL. OF THE ENTIRE 100 YR STORM EVENT. TEST TO VERIFY THE ENTIRE VOLUME WILL INFILTRATE


CHITE X

ADRE & MUIR RESIDENCE

S PROPO SITE PL

AS NOTED Drawing By A.O.

11/12/22 Date 12/07/22 Revised // REVISED 12/15/22

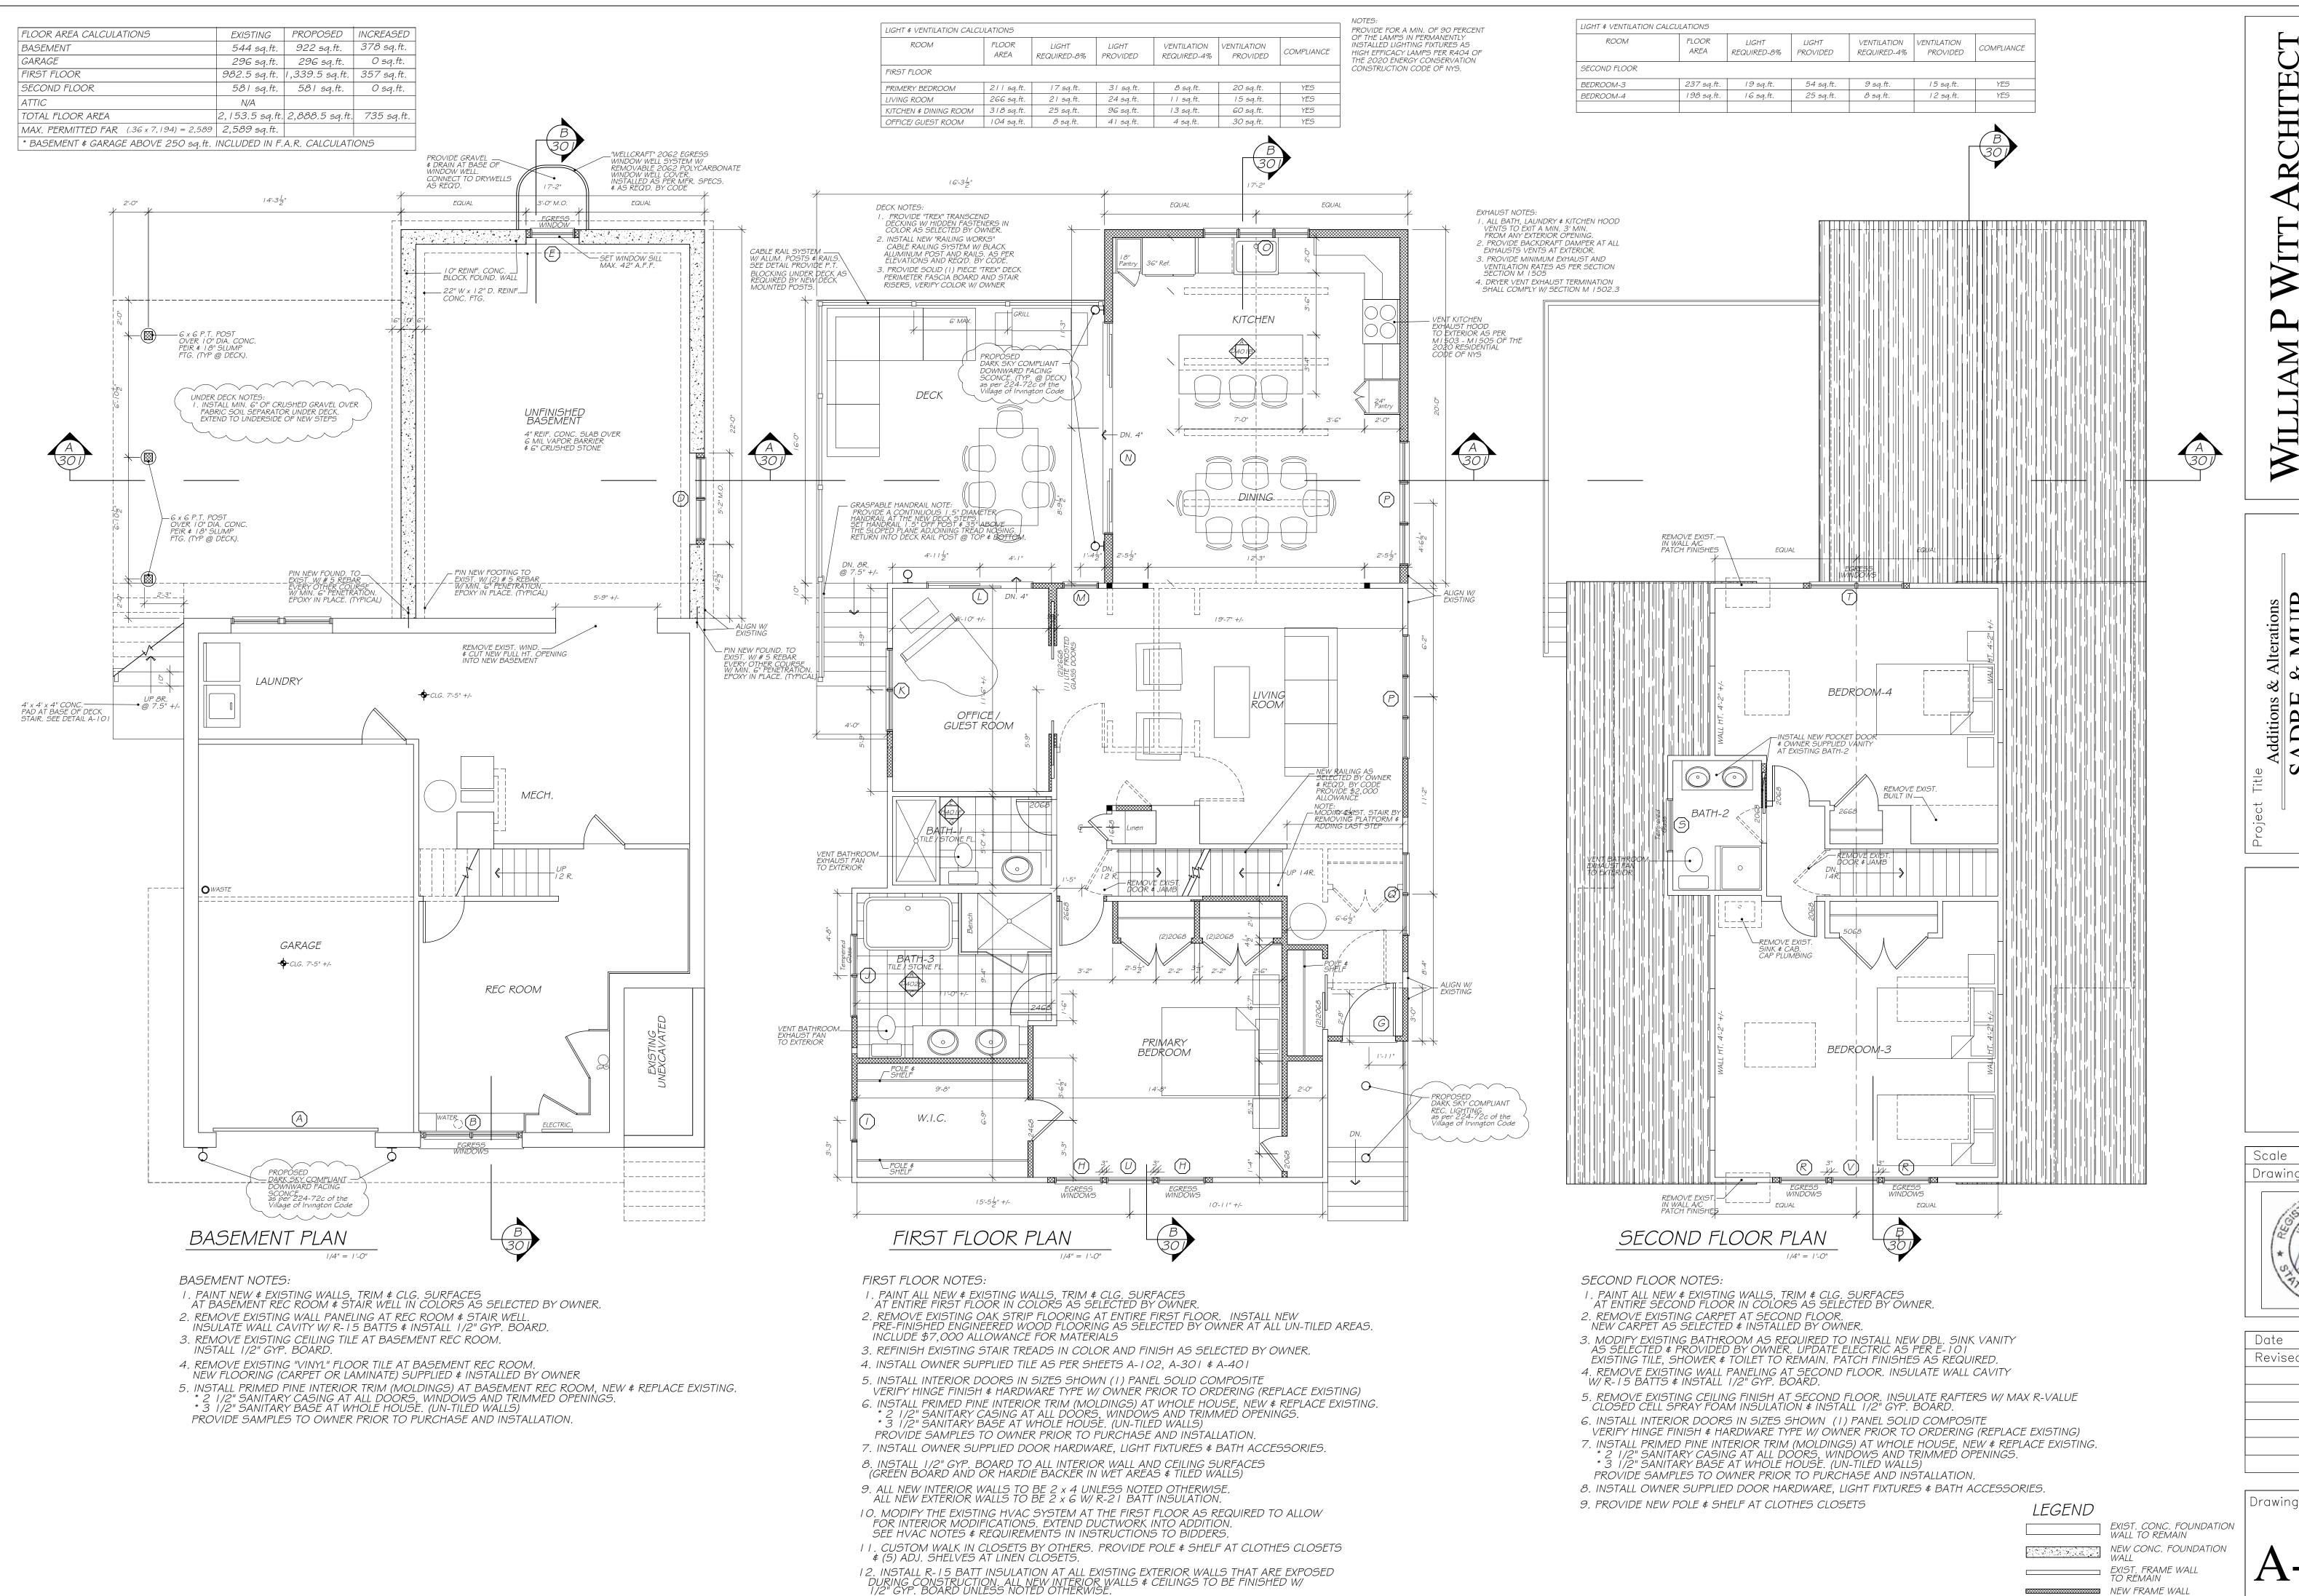


13. FINISH UNDERSIDE OF CEILING IN ADDITION W/ 1 x 6 NICKEL GAP (MDF OR PRIMED PINE)

ARCHITE

Additions & Alterations
SADRE & MUIR
RESIDENCE

PROPOSED FLOOR PLAN

1/4'' = 1'-0''

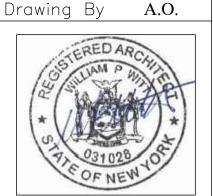

Date	10/20/22
Revised	12/15/22
	01/20/23

Drawing No.

NEW FRAME WALL

EXIST. FRAME WALL TO BE REMOVED



CHITE


Additions & Alterations
SADRE & MUIR
RESIDENCE

PROPOSED ELEVATIONS

Scale 1/4'' = 1'-0''Drawing By A.O.



Date	10/20/22
Revised	01/20/23

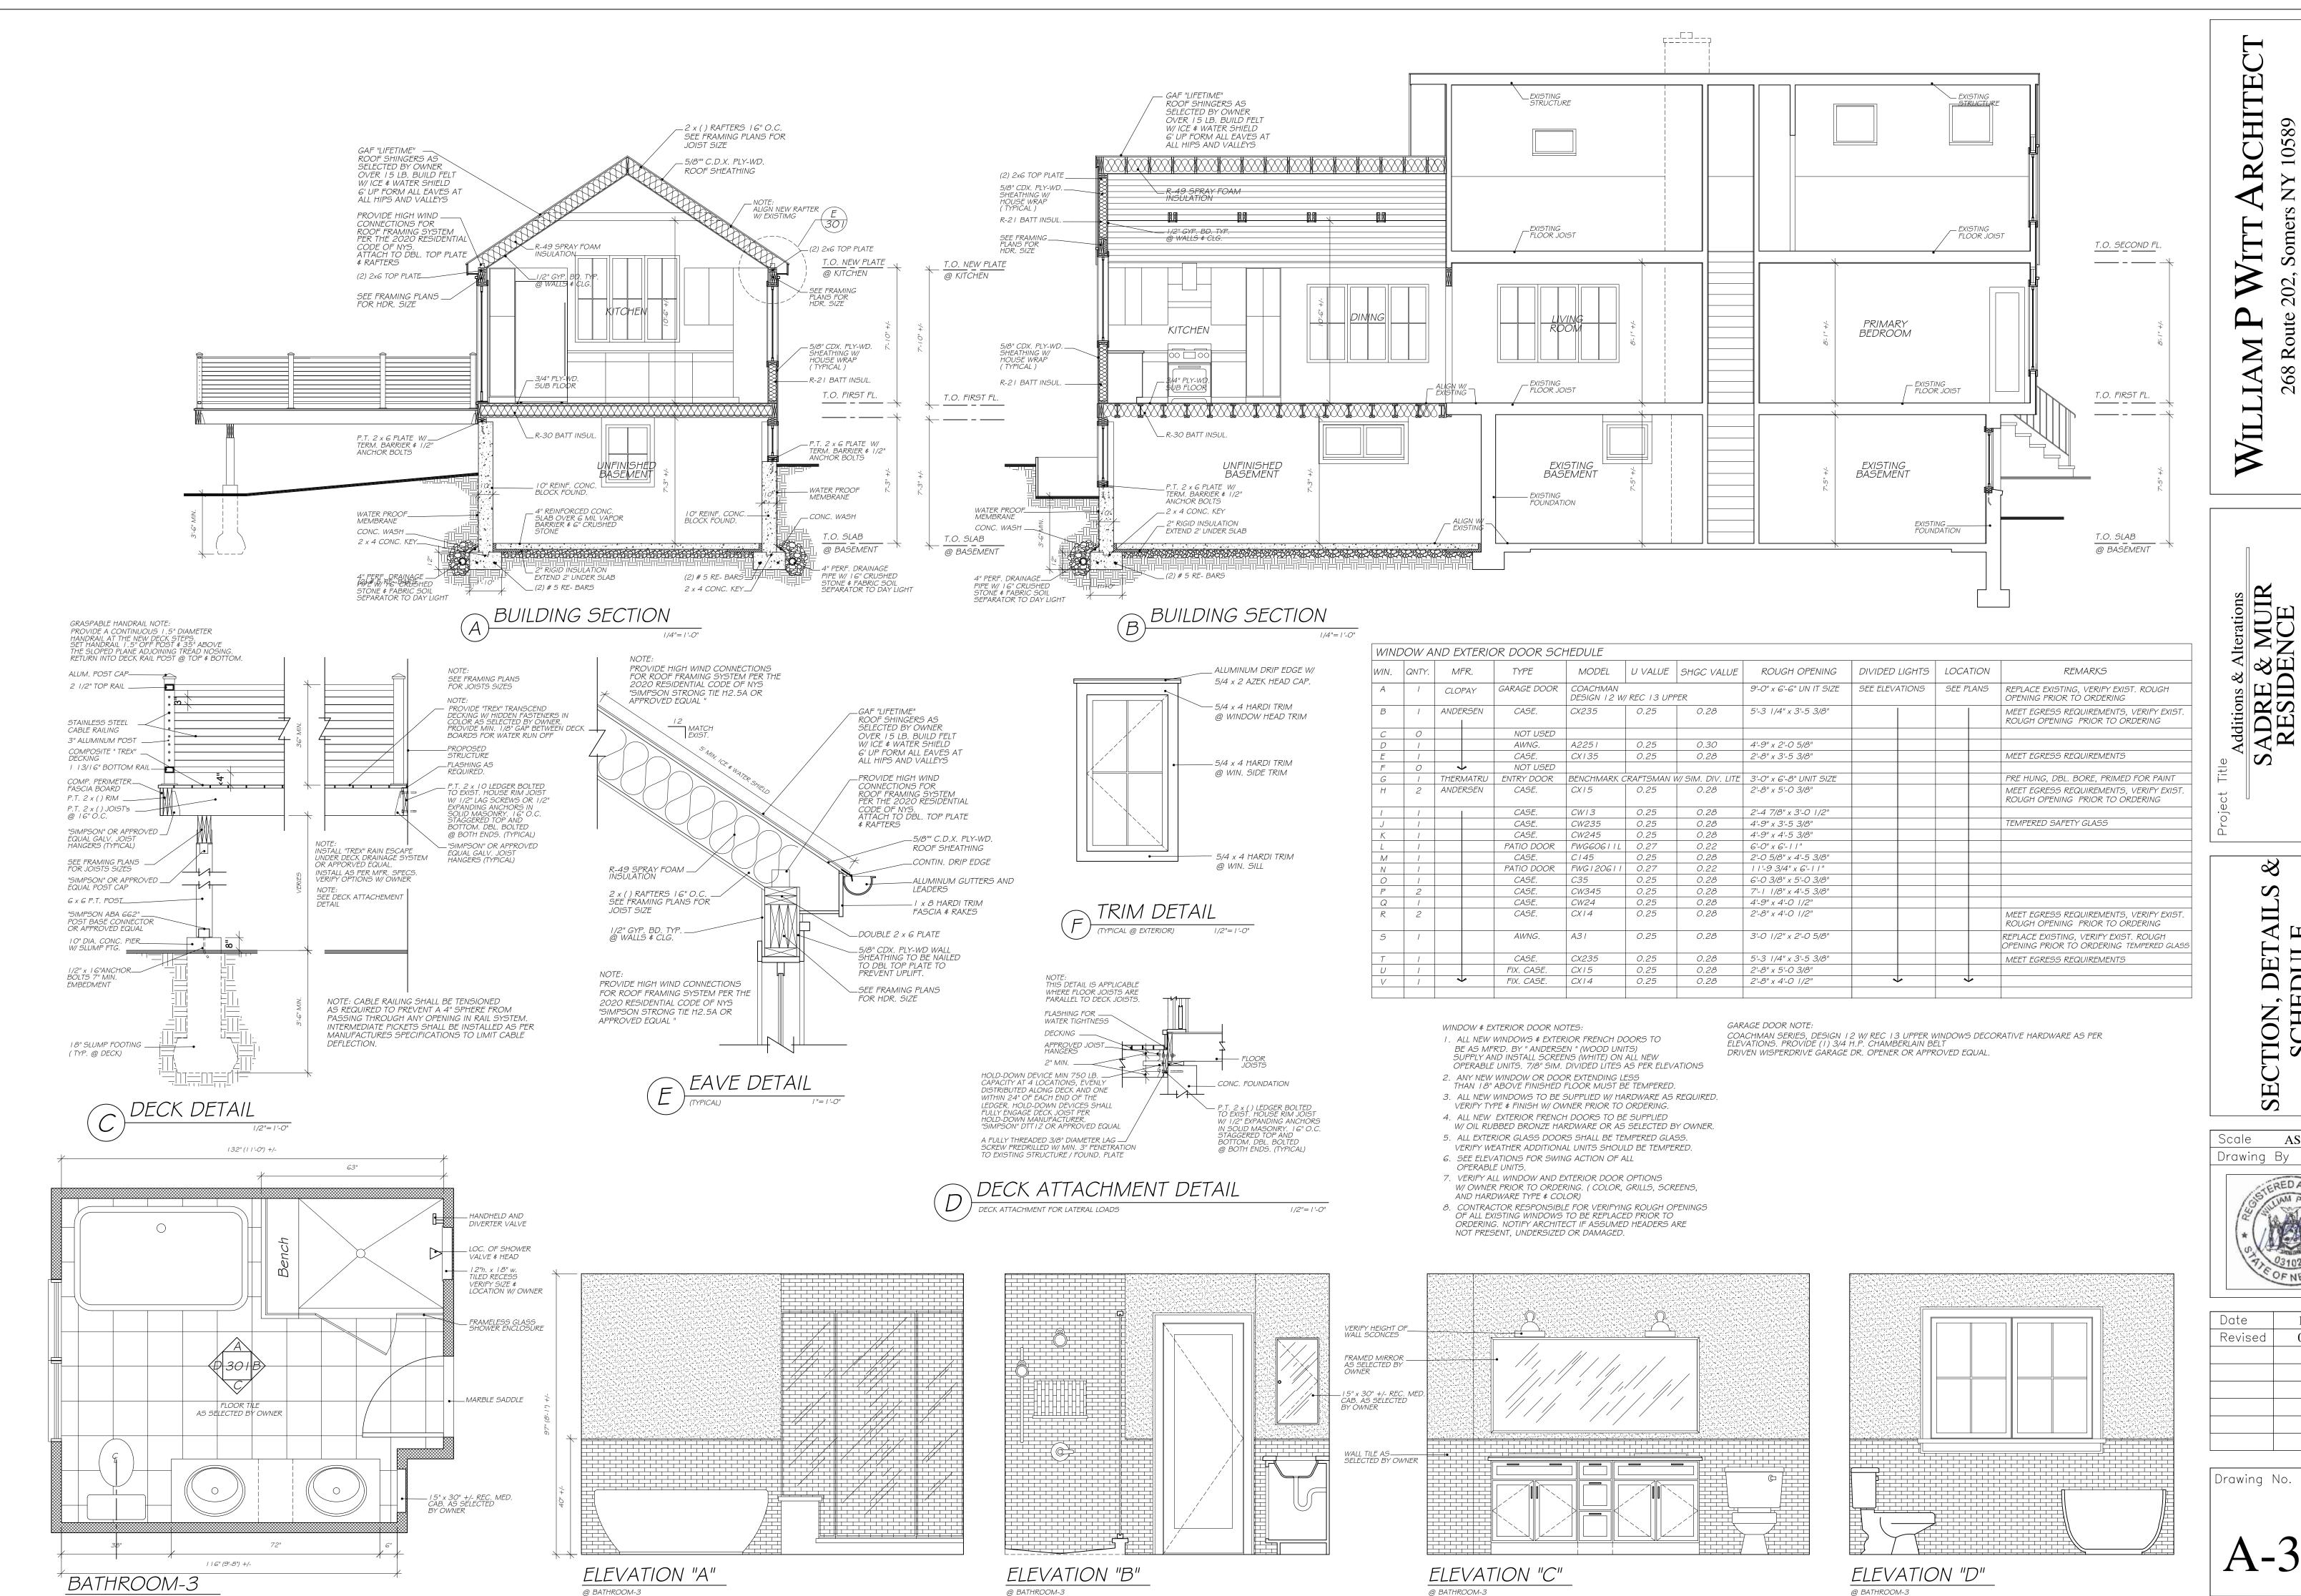


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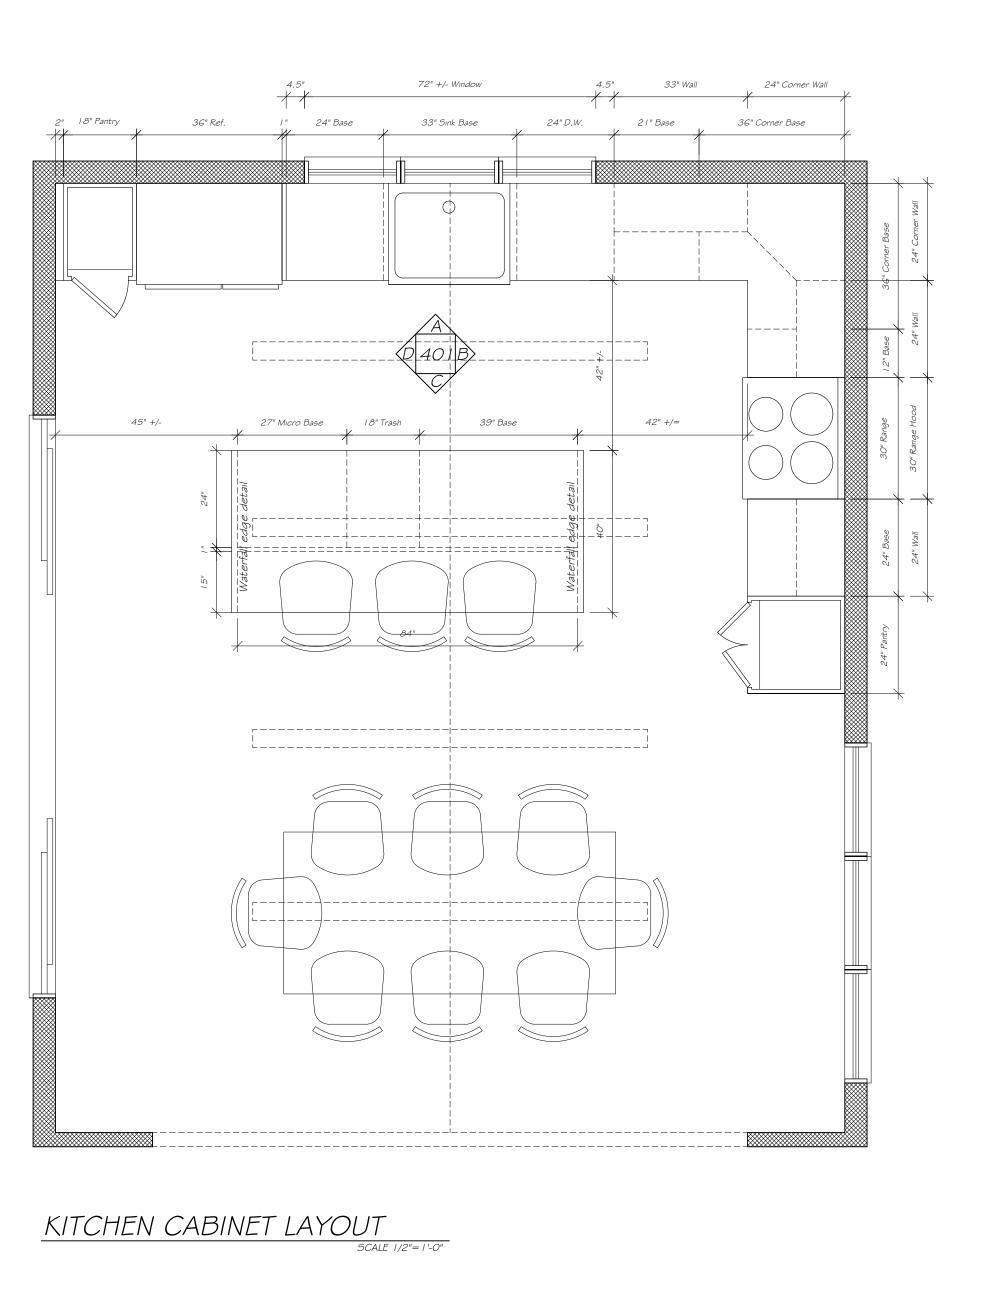
15 JAFFRAY COURT Irvington, NY10533


TION, DETAI SCHEDULE


AS NOTED

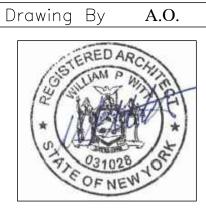

Date	10/17/22
Revised	01/20/23




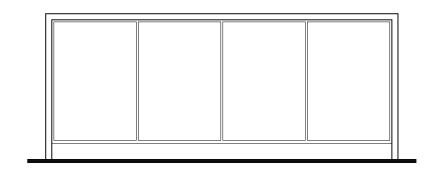

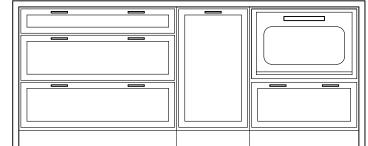




- 7. KITCHEN CABINETS MANUFACTURER TO VERIFY ALL DIMENSIONS AND FIELD CONDITIONS WITH CONTRACTOR
- PRIOR TO PLACING CABINET ORDER. 8. PROVIDE ELECTIRCAL, WATER, DRAINS AND GAS AS

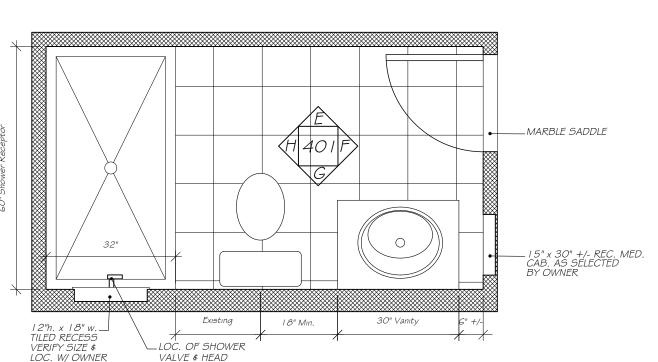


BATHROOM- I




ELEVATION "A"

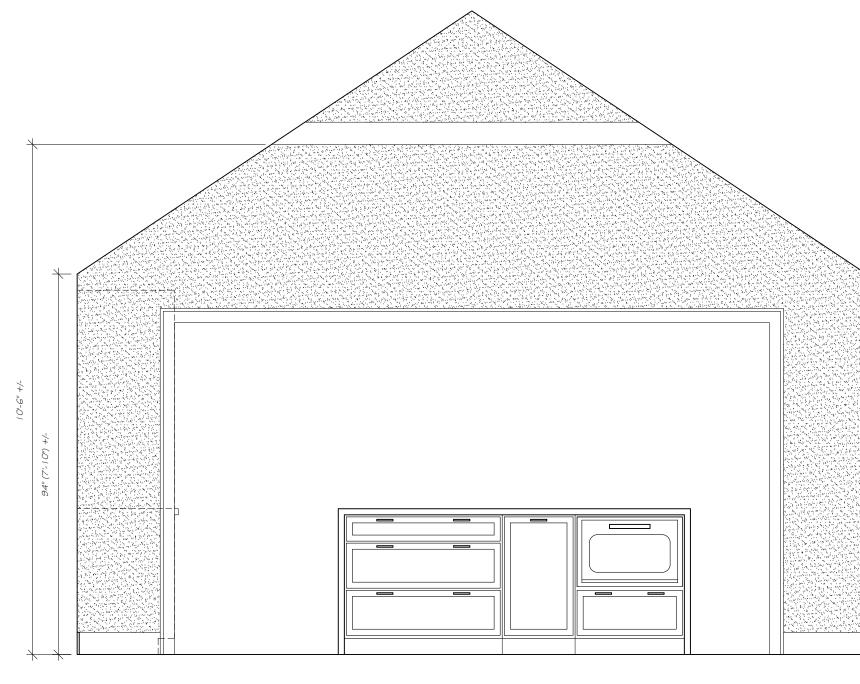


ELEVATION "C"

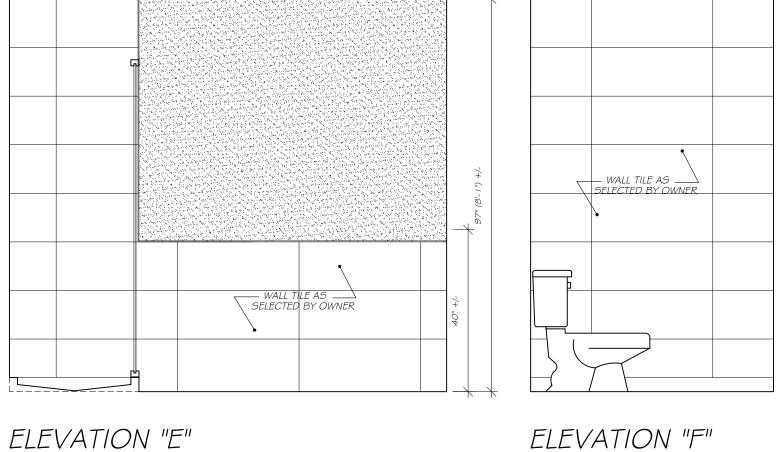




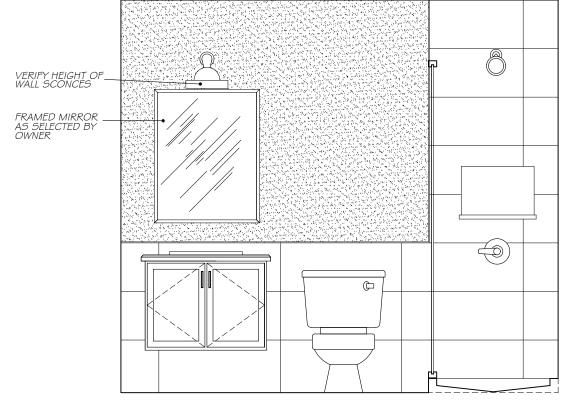


ELEVATION "G"

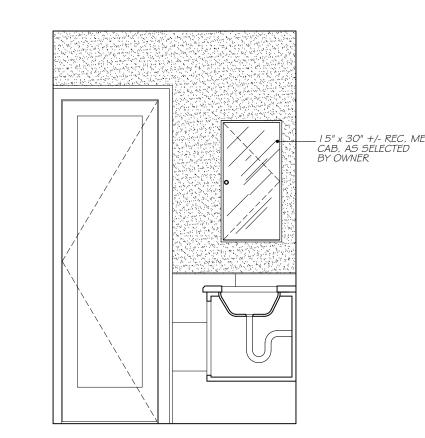


ELEVATION "H" @ BATHROOM- I

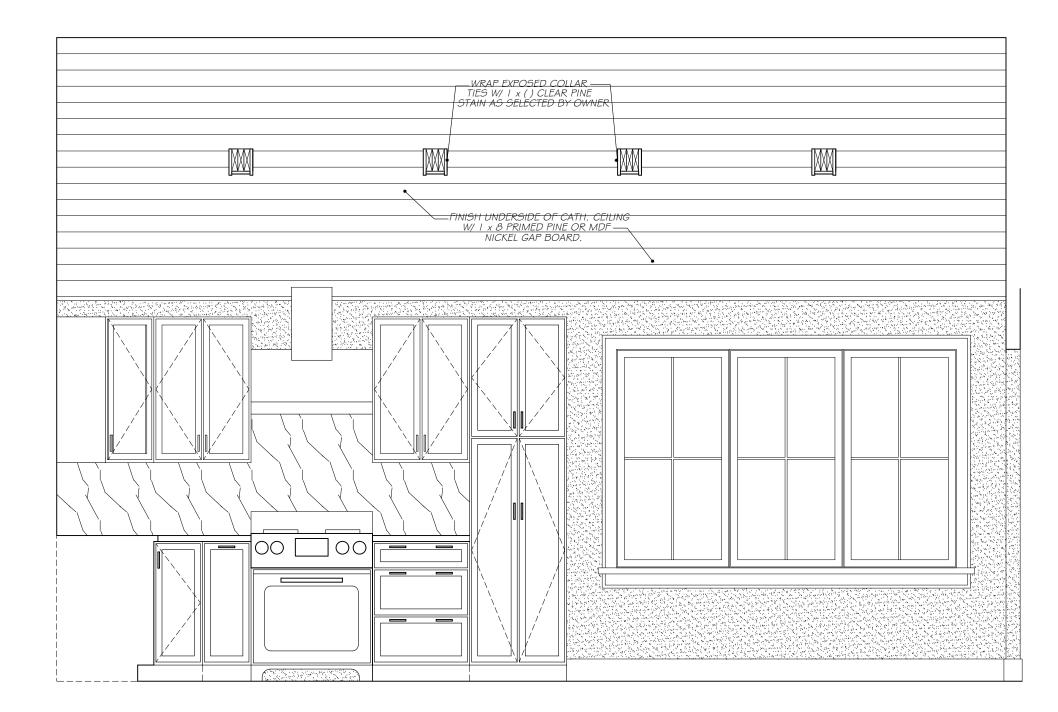

ELEVATION "B"

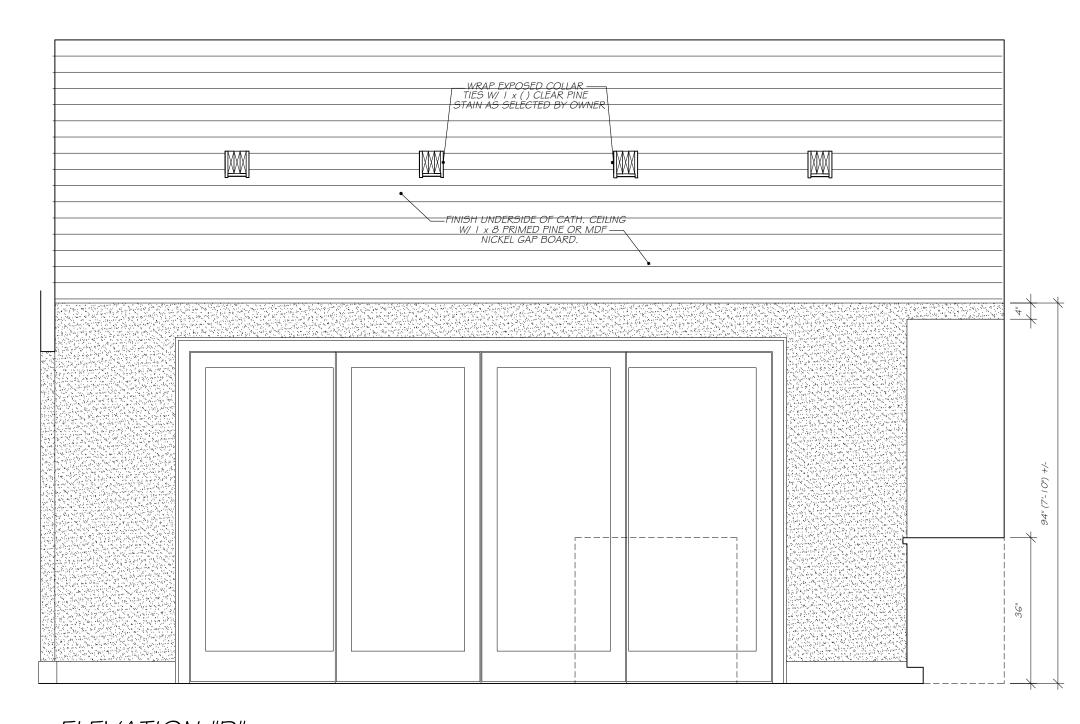

ELEVATION "D"

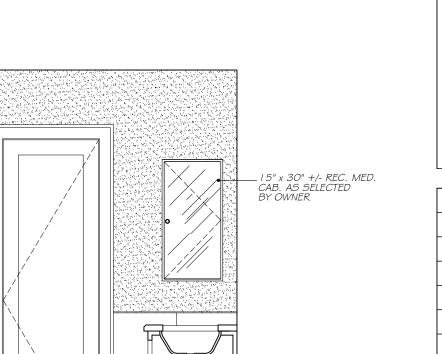

Date	10/17/22
Revised	01/20/23

1/2" = 1'-0"

Drawing By A.O.

ARCHITECT

202, Somers NY 10589 5 Bwittarch@gmail.com

Drawing No.


KITCHEN ISLAND LAYOUT KITCHEN NOTES: I. VERIFY FINAL KITCHEN LAYOUT, APPLIANCES AND PLUMBING FIXTURE LOCATIONS W/ OWNER PRIOR TO ROUGH IN.


2. CABINET MFR., COUNTER TOP MATERIAL, AND TILE BACK SPLASH TO BE DET. VERIFY W/ OWNER. 3. INTERIOR TRIM TO BE AS INDICATED OR AS DETAILED ON DRAWINGS 4. VENT EXHAUST FROM RANGE HOOD THROUGH


CEILING OR WALL TO EXTERIOR AS REQ'D. 5. KITCHEN FLOOR MATERIAL TO BE WOOD STRIP

FLOORING AS SELECTED BY OWNER G. ALL BASE AND WALL CABINETS WITH EXPOSED SIDES TO BE SUPPLIED WITH FINISHED END PANELS (DOORS)

REQUIRED VERIFY SPECS W/ OWNER \$ MFR.

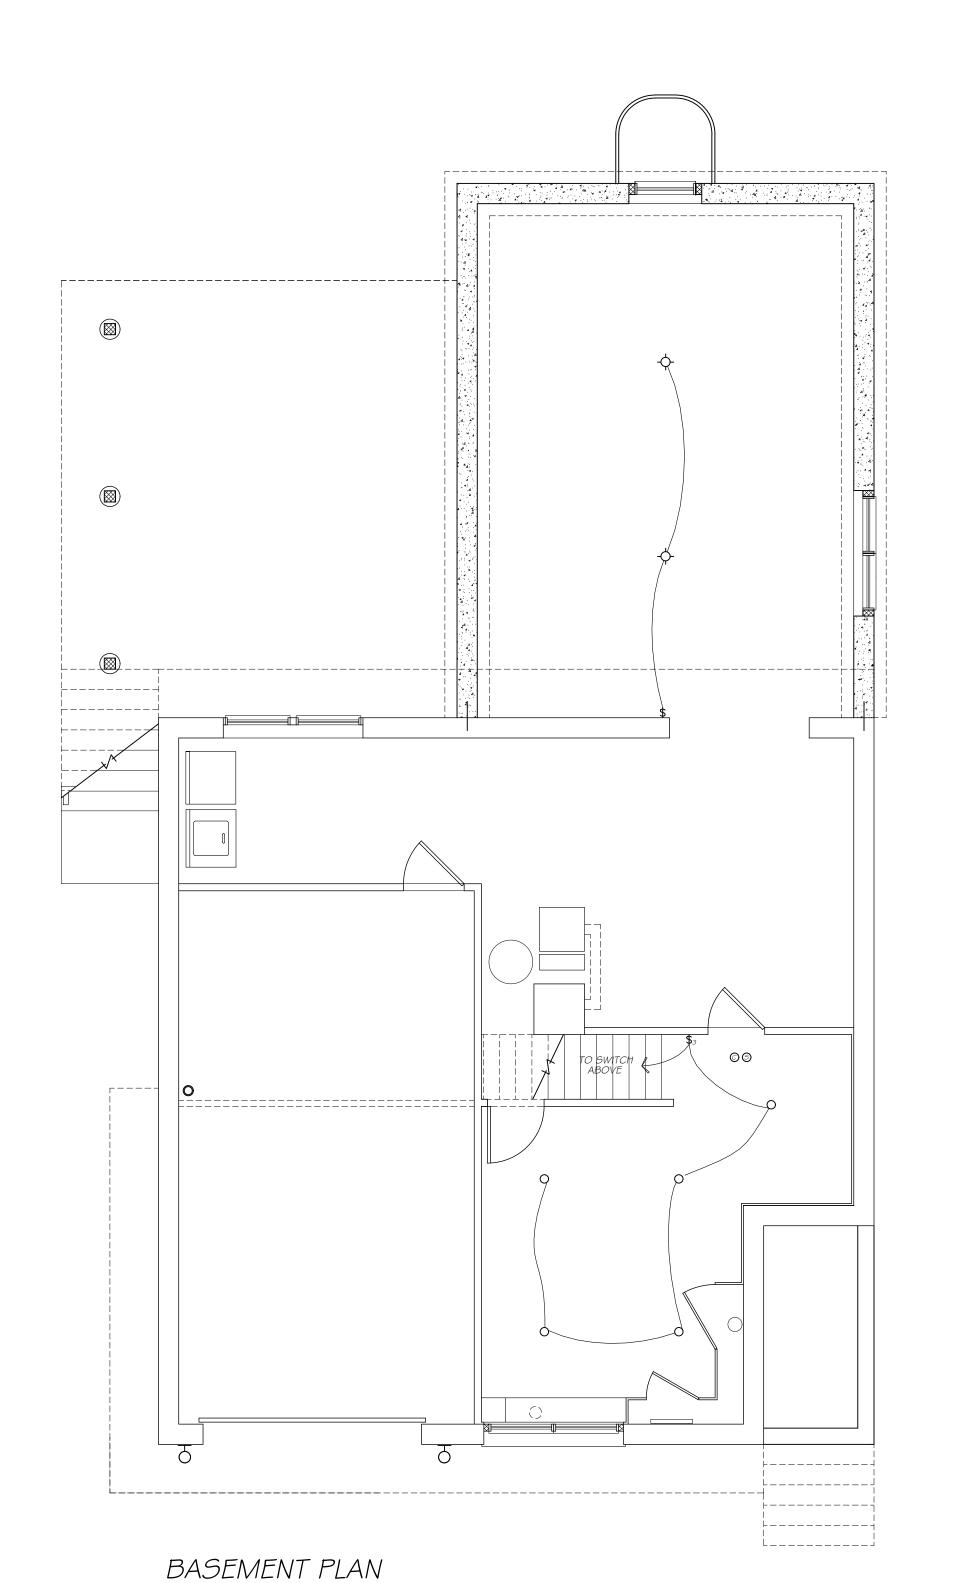

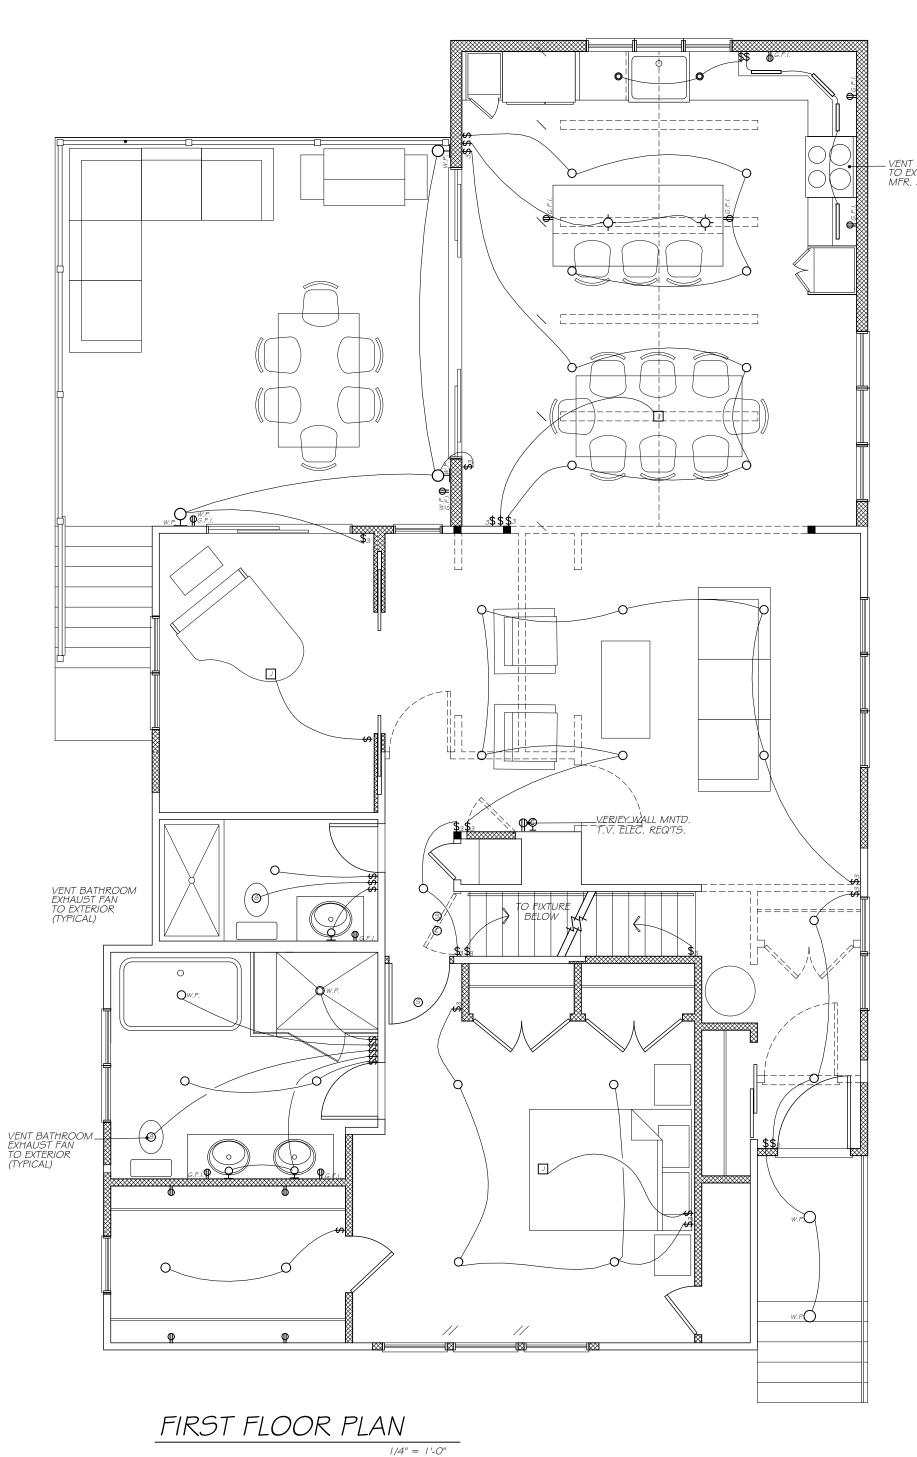

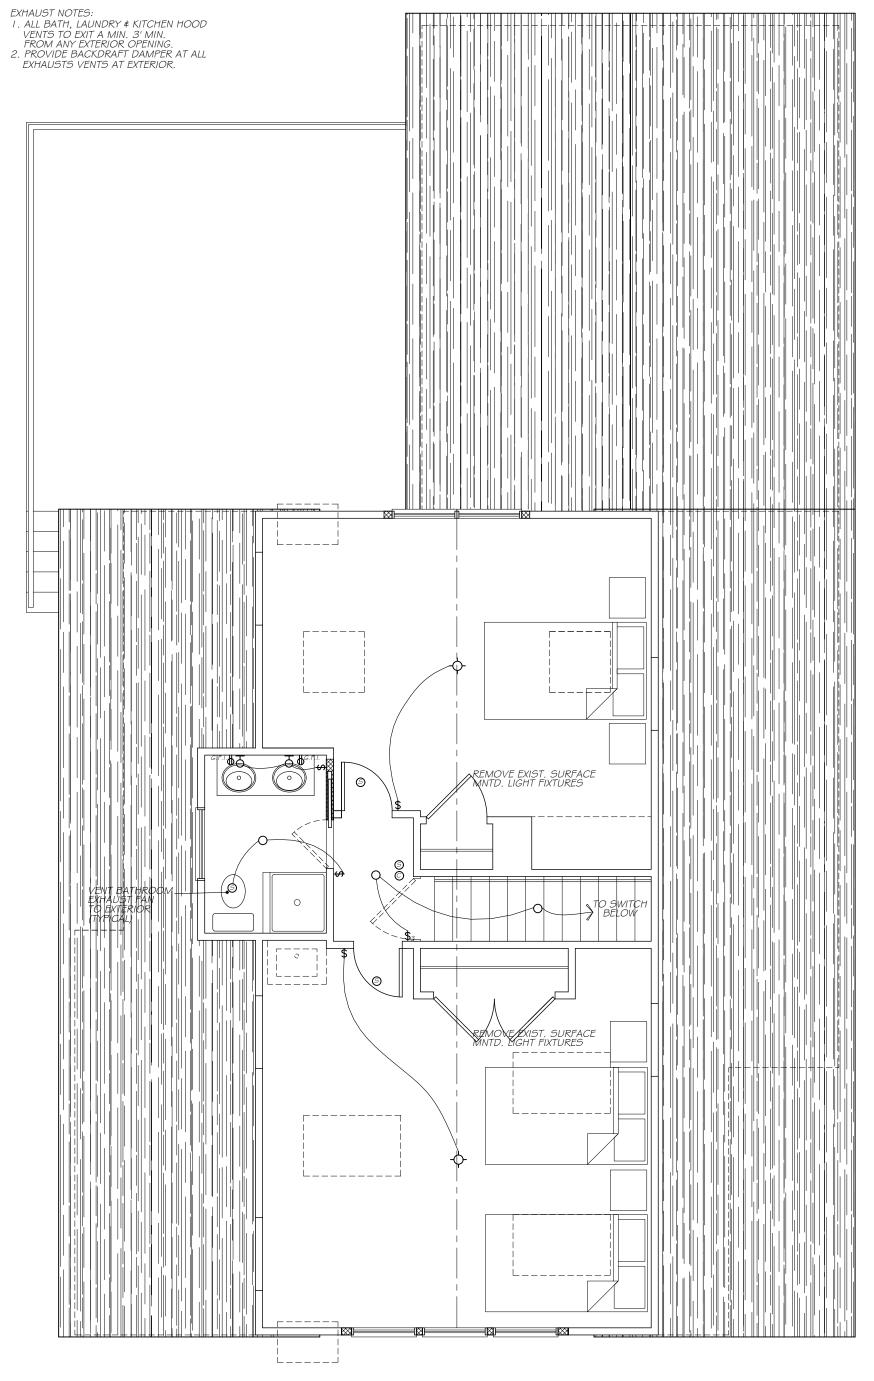

SECOND FLOOR PLAN

- Ψ_{w.P.} WATER PROOF RECEPTICAL ₱_{G.F.I.} G.F.I. RECEPTICAL
- Ψ₂₂₀ 220 VOLT RECEPTICAL FLOOR OUTLET

Фсьс. CEILING OUTLET

ELECTRIC SYMBOLS

P DUPLEX OUTLET

- Q CABLE TV. OUTLET (RGG QUAD) HOME RUN ▼ TELEPHONE OUTLET (CAT 5E) HOME RUN
- SURFACE MOUNTED LIGHT FIXTURE
- O 5" RECESSED LIGHT W/ LED BULB & TRIM • 3" RECESSED LIGHT W/ LED BULB \$ TRIM
- UNDERCOUNTER LIGHTING ☐ CEILING FAN JUNCTION BOX

- \$_D DIMMER SWITCH
- © CARBON MONOXIDE DET. (INSTALL AS REQ'D.)
 © EXHAUST FAN HEAT DETECTOR (INSTALL AS REQ'D. BY CODE) SMOKE ALARM (INTERCONNECTED)
- \$ SINGLE POLE SWITCH \$3 THREE POLE SWITCH

- ELECTRICAL NOTES:

 I. WALL OUTLETS AT AREA'S OF

 NEW WORK BY ELECTRICIAN AS

 REQ'D. BY CODE. UNLESS OTHERWISE

 NOTED ON DRAWING.
- 2. INSTALL HARDWIRED, INTERCONNECTED SMOKE DETECTORS W/ BATTERY BACKUP LOCATE AS REQ'D. BY CURRENT CODE.

 3. PROVIDE HARDWIRED, CARBON MONOXIDE DETECTORS W/ BATTERY BACKUP LOCATE AS REQ'D. BY CURRENT CODE.
- 4. VERIFY APPLIANCE \$ NEW MECHANICAL EQUIPMENT ELECTRICAL REQUIREMENTS W/ OWNER PRIOR
- TO ROUGH IN 5. PROVIDE OWNER W/ \$500 ALLOWANCE FOR THE SELECTION & INSTALLATION OF DIMMER SWITCHES. VERIFY LOCATIONS.
- 6. PROVIDE FOR A MIN. OF 90 PERCENT OF THE LAMPS IN PERMANENTLY INSTALLED LIGHTING FIXTURES AS HIGH EFFICIENCY LAMPS PER THE 2020 ENERGY CONSERVATION CONSTRUCTION CODE OF NYS.
- 7. ALL BATH, LAUNDRY & KITCHEN EXHUAST VENTS TO EXIT A MIN. OF 3' FROM ANY EXTERIOR OPENING. PROVIDE BACKDRAFT DAMPER AT ALL EXHAUST VENTS.

 8. ALL RECESSION INSULATION TO BE BOTH.
- ROOF OR FLOOR INSULATION TO BE BOTH IC & UL RATED.

 9. ALL BATH VENTS TO EXTERIOR A 3'
 MIN. FROM ANY EXTERIOR OPENING.
- I O. PROVIDE BACKDRAFT DAMPER AT ALL EXHAUSTS VENTS AT EXTERIOR.

- ELECTRICAL NOTES:
- I. KITCHEN REQUIREMENTS: * RANGE * DISHWASHER
- * EXHAUST HOOD * REFRIG. * MICROWAVE OVEN

* UNDER CAB. LIGHTS

- * G.F.C.I. WALL OUTLETS * DISPOSAL 2. VERIFY CENTER OF KITCHEN
- ISLAND PRIOR TO ROUGHING IN CLG. FIXTURES.
- 3. SEE FINAL KITCHEN PLAN BY OTHERS AND VERIFY APPLIANCE REQUIREMENTS PRIOR TO ROUGH. 4. VERIFY KITCHEN COUNTER ELECTRICAL OUTLET LOCATIONS W/ KITCHEN SUPPLIER
- LIGHTING NOTE:
 PROVIDE FOR A MIN. OF 90 PERCENT
 OF THE LAMPS IN PERMANENTLY
 INSTALLED LIGHTING FIXTURES AS
 HIGH EFFICIENCY LAMPS PER 404 OF
 THE 2020 ENERGY CONSERVATION
 CONSTRUCTION CODE OF NYS. EXHAUST NOTES:
- Date 10/20/22 Revised 12/15/22 1 . ALL BATH, LAUNDRY & KITCHEN HOOD VENTS TO EXIT A MIN. 3' MIN. FROM ANY EXTERIOR OPENING. 01/20/23 2. PROVIDE BACKDRAFT DAMPER AT ALL EXHAUSTS VENTS AT EXTERIOR.

Drawing No.


E-101

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Drawing By ___A.O.

1/4" = 1'-0"


ARCHITEC

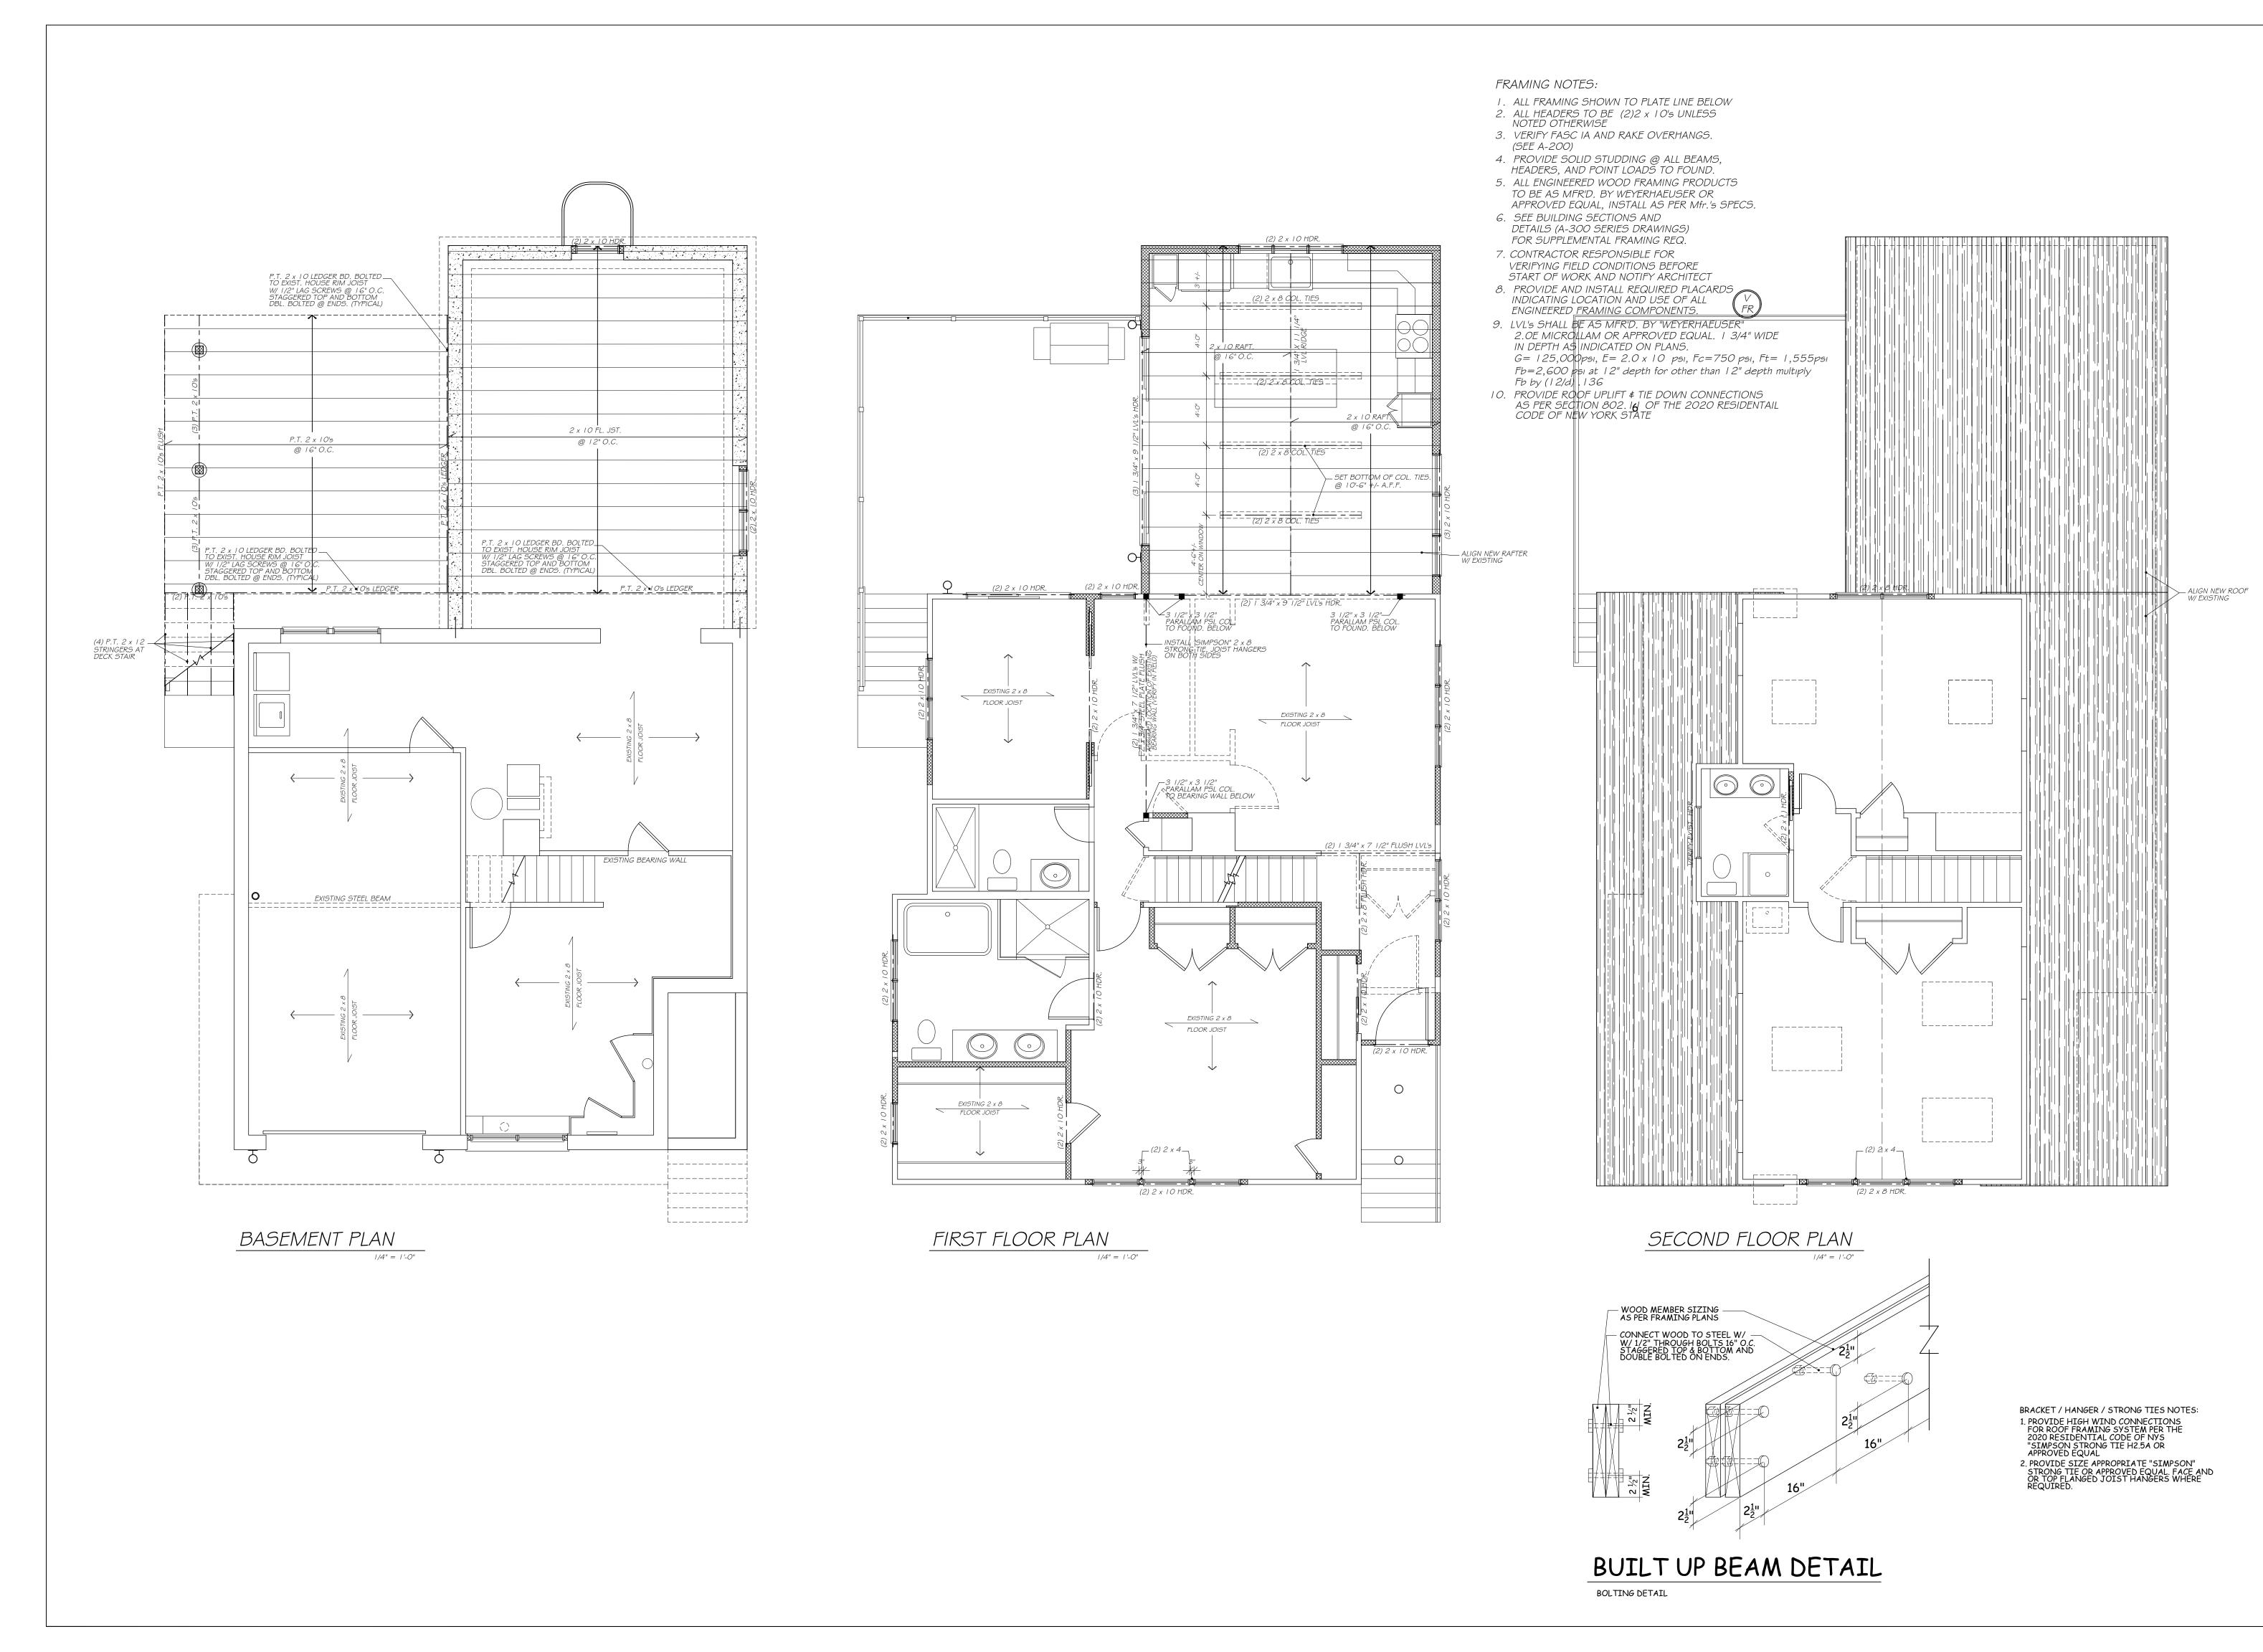

ARCHITE Somers NY 10589 wittarch@gmail.com

Additions & Alterations
SADRE & MUIR
RESIDENCE


1/4'' = 1'-0''Drawing By A.O.

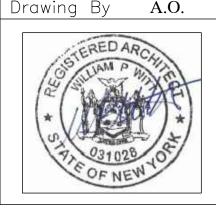



Date	10/20/22
Revised	12/15/22
	01/20/23

Drawing No.

F-101

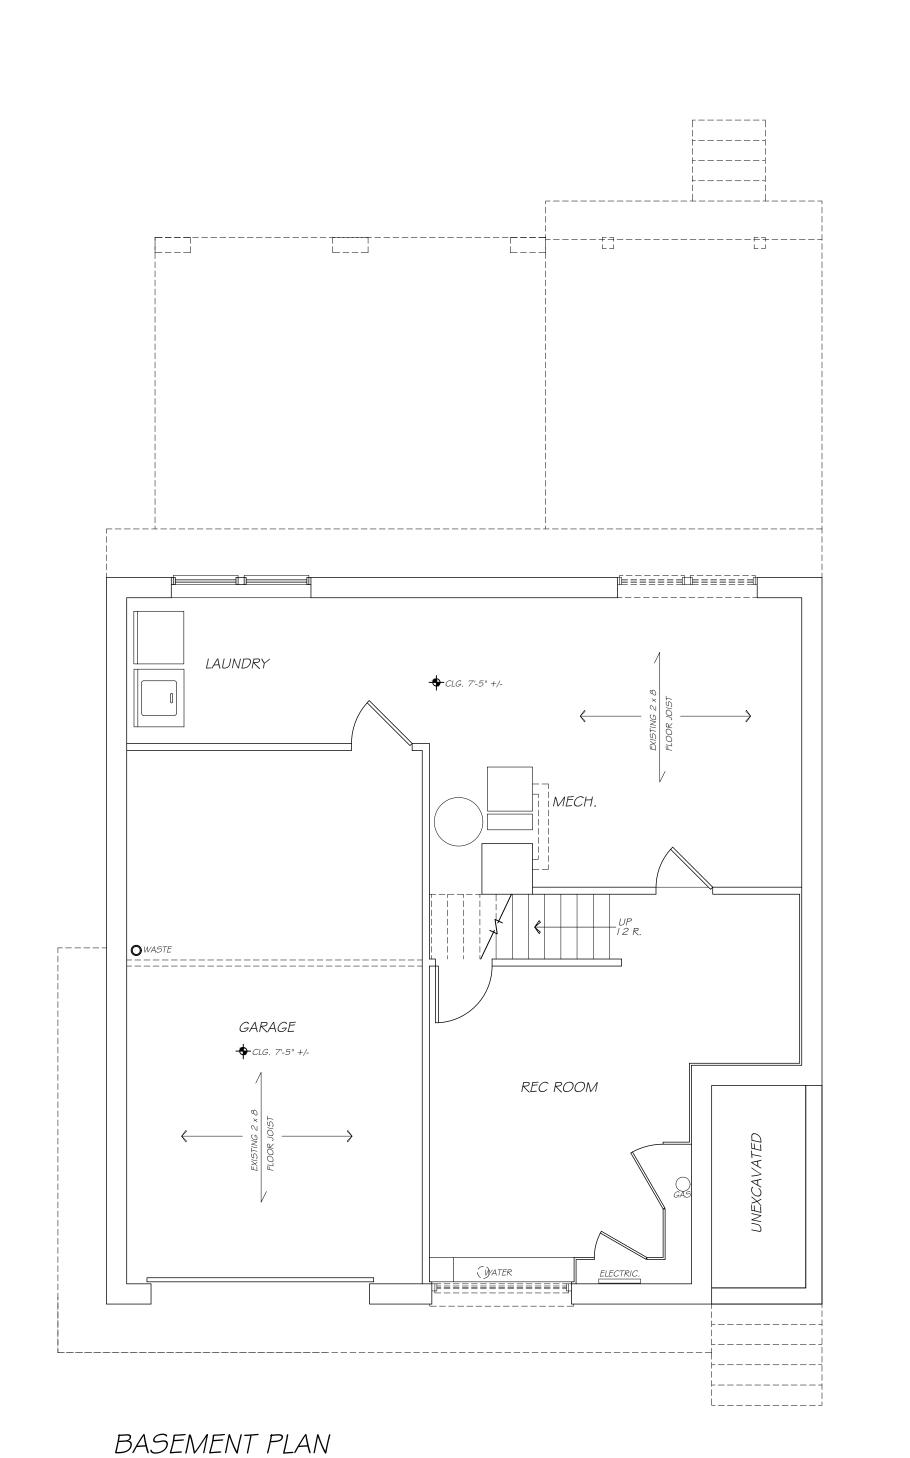

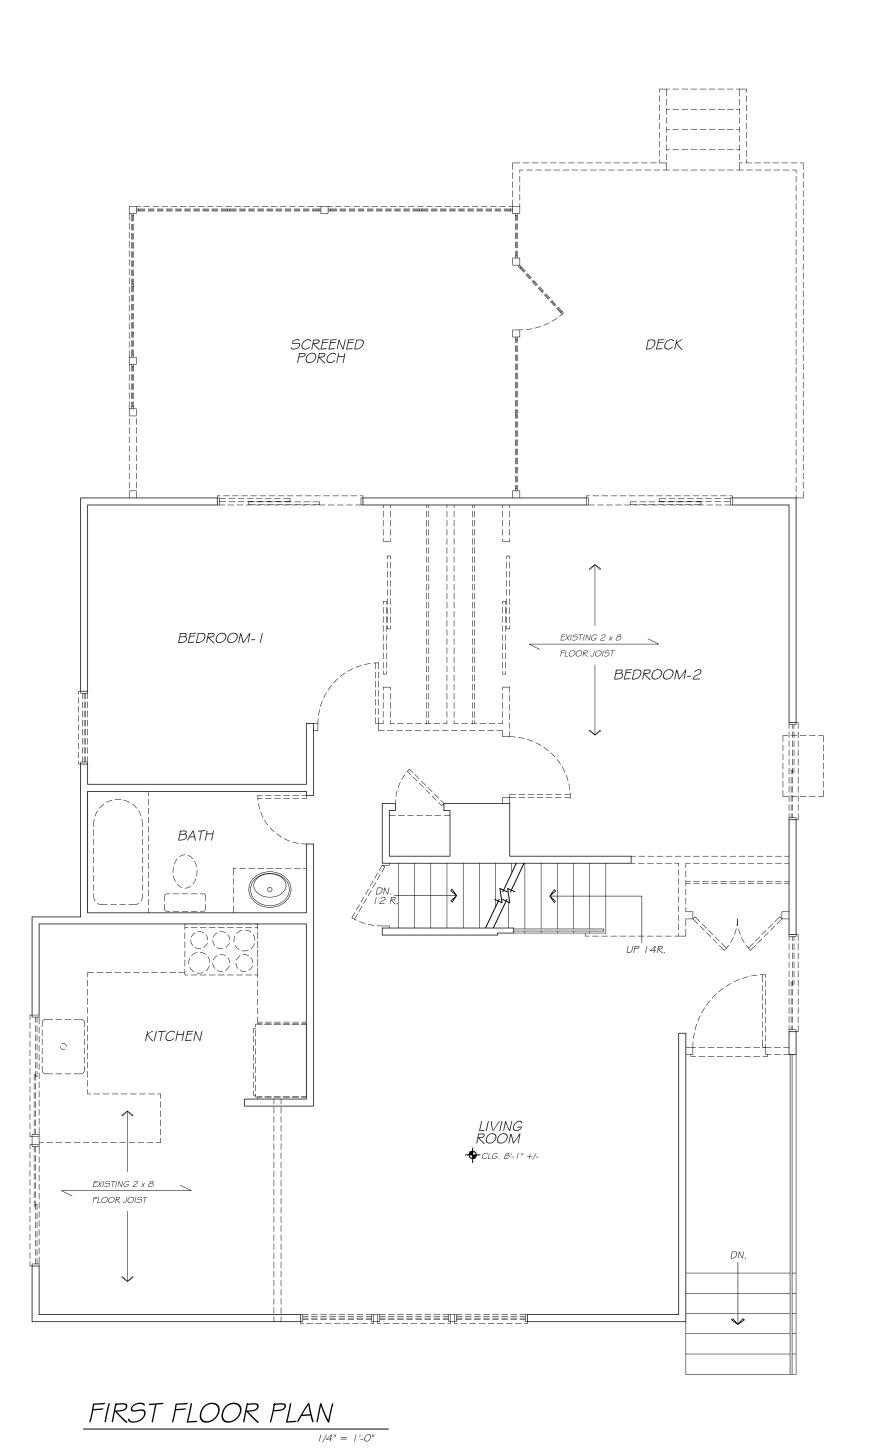

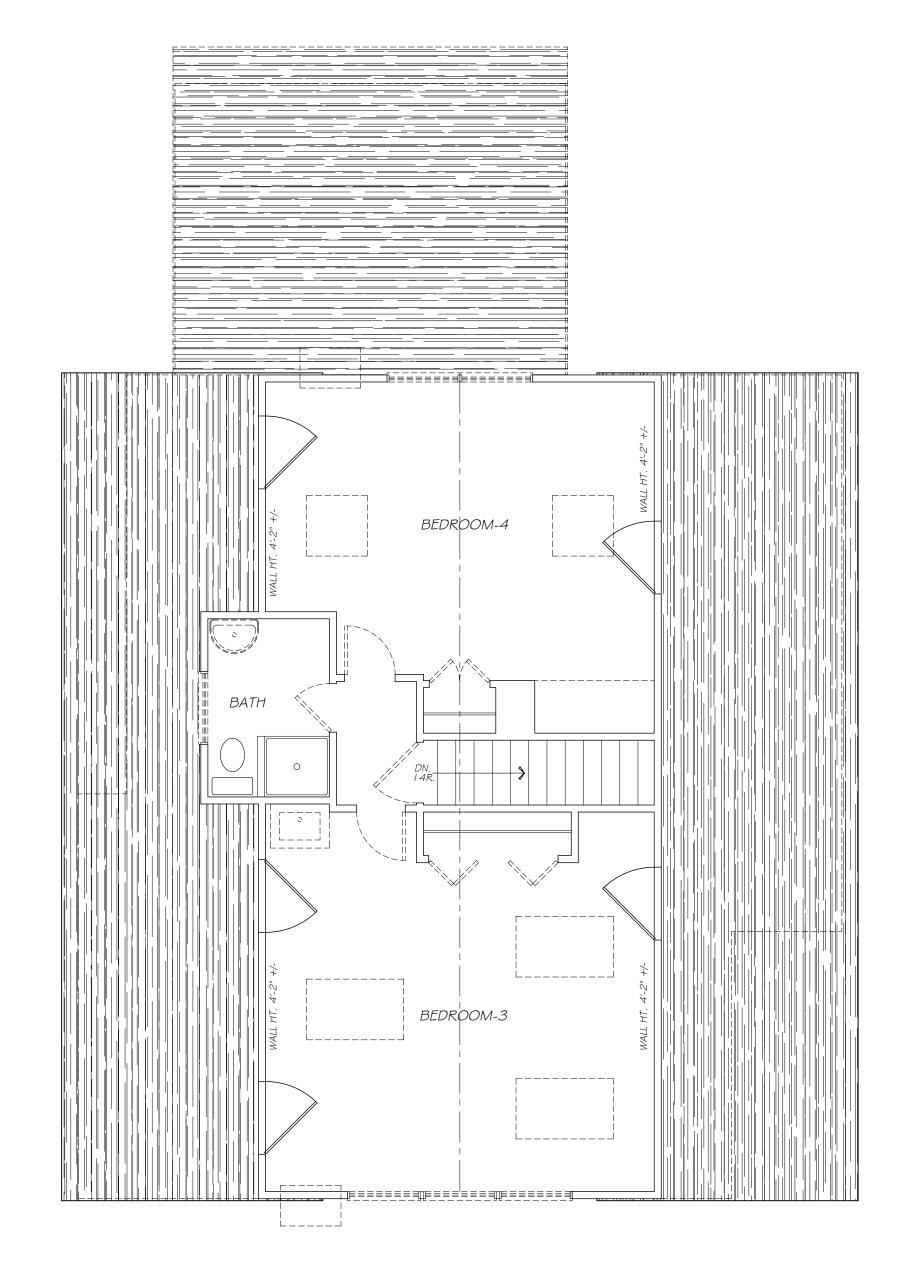

SECOND FLOOR PLAN

EXIST. CONC. FOUNDATION
WALL TO REMAIN

EXIST. CONC. FOUNDATION
WALL TO REMOVED

EXIST. FRAME WALL
TO REMAIN

EXIST. FRAME WALL
TO BE REMOVED

WILLIAM P WITT ARCHITECT
268 Route 202, Somers NY 10589
914-276-0225 Bwittarch@gmail.com

EXISTING
EXISTING
FLOOR PLANS
awing By A.O.

Scale 1/4" = 1'-0"

Drawing By A.O.

Date 09/14/22
Revised

Drawing No.

X-101





/ILLIAM P WITT ARCHITECT
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SADRE & MUIR
RESIDENCE

15 JAFFRAY COURT
Irvington, NY10533

EXISTING ELEVATIONS



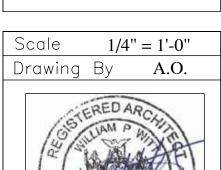

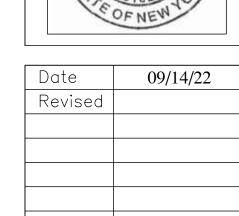X-201